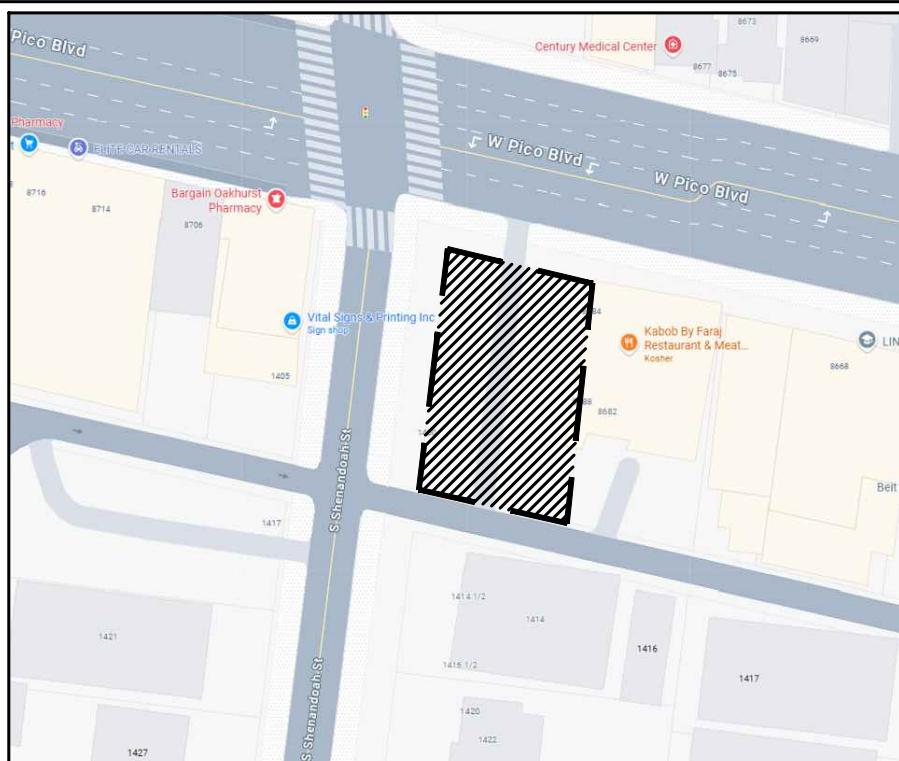
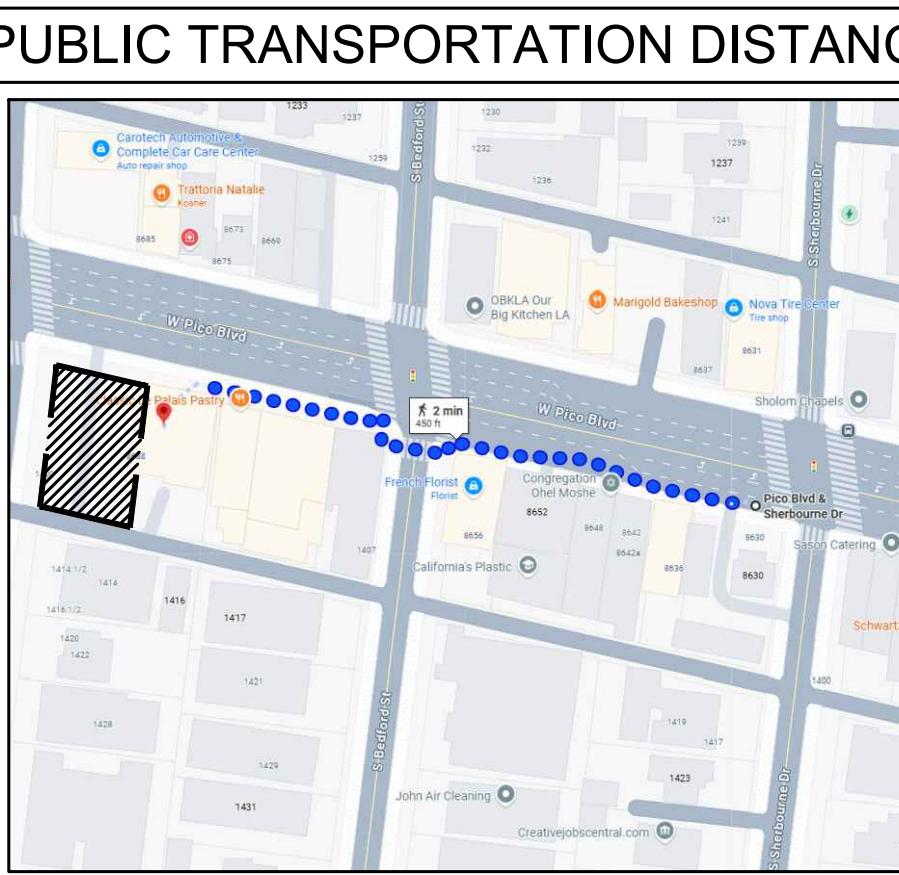


8688 W PICO BLVD LOS ANGELES, CA 90035

55 UNIT APARTMENTS 100% AFFORDABLE

100 % PRIVATELY FUNDED, NO TAX CREDIT NOT PUBLIC HOUSING NO PARKING REQUIRED FOR 100 % AFFORDABLE PROJECT. FULLY SPRINKLERED BUILDING

BDC
BEBERLY DESIGN

PROJECT ADDRESS		DRAWING INDEX		BUILDING AREA,ZONING CODE		DENSITY CALCULATION:																					
8688 W PICO BLVD LOS ANGELES, CA 90035		SHEET TITLE A.0 COVER SHEET A1.0 SITE PLAN A2.0 FIRST FLOOR PLAN A2.1 SECOND FLOOR PLAN A2.2 THIRD FLOOR PLAN A2.3 FOURTH FLOOR PLAN A2.4 FIFTH FLOOR PLAN A2.5 ROOF PLAN A3.0 ELEVATIONS A3.1 ELEVATIONS A3.2 ELEVATIONS A4.0 SECTIONS A4.1 SECTIONS A5.0 WINDOW & DOOR SCHEDULE D-1 DETAILS D-2 DETAILS D-3 DETAILS D-4 DETAILS D-5 DETAILS D-6 DETAILS DA-1 DISABLE NOTES DA-2 DISABLE NOTES DA-3 DISABLE NOTES DA-4 DISABLE NOTES DA-5 DISABLE NOTES N-1 GREEN BUILDING NOTES N-2 FIRE DEPARTMENT NOTES N-3 GENERAL NOTES N-4 ENERGY NOTE, BICYCLE SPECIFICATIONS N-5 TOC VERIFICATION N-6 N-7		PER TOD LOW, BASE FAR= 1.5 : 1 MAXIMUM ALLOWABLE FLOOR AREA: LOT AREA = 7,836.52 SQ.FT $7,836.52 \times 1.5 = 11,754.78$ SQ.FT. PER DENSITY BONUS OFF MENU INCENTIVE = 3:1 FAR $7,836.52 \times 3 = 23,509.56$ SQ.FT. PROPOSED BUILDING AREA: 25,326 SQ.FT $25,326 \text{ SF } / 7,836.52 \text{ SF } = 3.24:1$ FAR "PER OFF-MENU INCENTIVE"		ZONE = C4-1-O , MAX FAR = 1.5:1 LOT AREA: 7,836.52 SQ.FT DENSITY C4: 1 UNIT / 400 SQ.FT. ALLOWABLE UNITS: $7,836.52 / 400 = 19.59 = 20$ TOTAL PROPOSED UNIT = 55 DENSITY INCREASE: 55 / 20 = 175% AB 1763 (2019) FOR 100% AFFORDABLE PROJECTS UNLIMITED DENSITY AND A HEIGHT INCREASE OF 33 FEET OR 3 ADDITIONAL STORIES; FOR 100% AFFORDABLE PROJECTS LOCATED WITHIN 1/2 MILE OF A MAJOR TRANSIT STOP (§ 65915(f)(3)(D)) AND 65915(D)(2)(D) INCOME LEVELS FOR ALL DWELLING UNITS, EXCLUSIVE OF A MANAGER'S UNIT OR UNITS, MUST BE RESTRICTED FOR LOWER-INCOME HOUSEHOLDS (DEFINED IN § 50079.5), EXCEPT THAT UP TO 20 PERCENT OF ALL UNITS IN THE DEVELOPMENT MAY BE RESTRICTED FOR MODERATE INCOME HOUSEHOLDS (DEFINED BY § 50053). TOTAL UNIT PROPOSED = 55 UNITS AFFORDABILITY LEVEL PERCENTAGE # OF UNITS MANAGER UNIT 1 MODERATE INCOME 20% 11 LOW INCOME LEVEL 80% 43																					
PROJECT OWNER		8688 WEST PICO LLC 8688 W PICO BLVD LOS ANGELES, CA 90035 EMAIL: glotthut@gmail.com TEL: (310)722-1177		REQUESTED INCENTIVES		APPLICABLE CODES																					
DESIGN BY		BEVERLY DESIGN 1300 MIDVALE AVE #505, LOS ANGELES, CA 90024 BEVERLYDESIGNCENTER@GMAIL.COM TEL: (818)297-4118		NO REQUIRED PARKING, 100% AFFORDABLE. -FAR INCREASE -SIDE SETBACK -REAR SETBACK -OPEN SPACE		2024 CALIFORNIA BUILDING CODE (CBC) 2024 CALIFORNIA RESIDENTIAL CODE (CRC) 2024 CALIFORNIA FIRE CODE (CFC) 2024 CALIFORNIA GREEN BUILDING CODE (CGBSC) 2024 CALIFORNIA ELECTRICAL BUILDING CODE (CHBS) 2024 CALIFORNIA ENERGY CODE (CEC) 2024 CALIFORNIA ELEVATOR SAFETY CODE 2024 CALIFORNIA REFERENCE STANDARDS CODE 28 CFR PART 36 (ADA) TITLE 24 TITLE 8 CALIFORNIA STATE CODE FOR ELEVATORS																					
STRUCTURAL ENGINEER		PADIR CONSULTING ENGINEERS CORP. EMAIL: PRESIDENT@PADIR.US TEL: (415)728-5259		1-OFF-MENU INCENTIVE TO ALLOW FOR A FAR OF 1.5:1 IN LIEU OF 1.5:1 2-OFF-MENU INCENTIVE TO ALLOW FOR AN EASTERLY SIDE YARD OF 5' IN LIEU OF 10' 3-OFF-MENU INCENTIVE TO ALLOW FOR A WESTERLY SIDE YARD OF 0' IN LIEU OF 10' 4-OFF-MENU INCENTIVE TO ALLOW FOR A REAR YARD OF 12' IN LIEU OF 19' AS MEASURED FROM CENTER LINE OF ALLEY 5-OFF-MENU INCENTIVE TO ALLOW FOR A 50% OPEN SPACE REDUCTION WAIVER 1) WAIVER OF DEVELOPMENT STANDARD TO REDUCE ON-SITE TREES BY 25%		SCHOOL DISTRICT ASSESSABLE		NOTE																			
SURVEY		MOLAI LAND & DESIGN 24308 BURBANK BLVD WOODLAND HILLS, CA 91367 818-325-9225 MOLAII22@YAHOO.COM		ADDRESS: 8688 & 8684 W PICO BLVD LOS ANGELES, CA 90035 PROJECT SCOPE: (55) UNITS, 7 STORY RESIDENTIAL APARTMENT BUILDING		STORY USE AREA (SQ.FT.) FIRST LOBBY,PARCEL ROOM TRASH,RECYCLE 501 SECOND LOBBY 254 THIRD DWELLING UNITS 5,645 FOUR DWELLING UNITS 5,645 FIFTH DWELLING UNITS 5,645 SIXTH DWELLING UNITS 5,645 SEVENTH DWELLING UNITS 5,645 ROOF 404 TOTAL 29,384		1. OBTAIN SEPARATE PERMIT FOR THE FOLLOWING ITEMS: RETAINING WALLS, GRADING WORK, BLOCK FENCE, FIRE SPRINKLER SYSTEM, ELECTRICAL, MECHANICAL, PLUMBING, EMERGENCY RESPONDER RADIO COVERAGE IN ACCORDANCE, WORK, SHORING AND DEMOLITION, FIRE ALARM SYSTEM WITH LAFC § CBC 915.4.2/4, SOLAR VOLTAIC 2. THIS BUILDING SHALL BE PROVIDED WITH A MANUAL ALARM SYSTEM WITH THE CAPABILITY TO SUPPORT VISIBLE ALARM NOTIFICATION APPLIANCES IN ACCORDANCE WITH NFPA 72", (907.2.9, 907.5.2.3.3, 907.5.2.3.4) OCCUPANT NOTIFICATION SHOULD COMPLY WITH ALL OF 907.5 PER 907.2.9.1, WITH INITIATING DEVICES PER 907.4. 3. THIS PROJECT IS 100% PRIVATELY FUNDED. THIS IS NOT HOUSING FACILITIES OWNED AND/OR OPERATED BY, FOR, OR ON BEHALF OF A PUBLIC ENTITY AND NO TAX CREDIT RECEIVED FROM STATE OR FEDERAL. 4. NO GUEST PARKING PROVIDED OR REQUIRED. 5. MANUAL FIRE ALARM TO BE PROVIDED PER CFC 907.2.1 THROUGH 907.2.23 6. FIRE SPRINKLER NOTE: THIS BUILDING AND GARAGE MUST BE EQUIPPED WITH AN AUTOMATIC FIRE EXTINGUISHING SYSTEM, COMPLYING WITH (NFPA-13), THE SPRINKLER SYSTEM SHALL BE APPROVED BY PLUMBING DIV. PRIOR TO INSTALLATION. 7. PROVIDE EMERGENCY RESPONDER RADIO COVERAGE IN ACCORDANCE WITH LAFC 510."CFC 916.1" 8. FIRE ALARM AND SPRINKLER SYSTEM IS REQUIRED TO BE MONITORS BY A SUPERVISORY SERVICE PER 901.6.1 AND 901.6.3																			
GEOTECHNICAL ENGINEER		LANDSCAPE		PROJECT DATA		AREA SUMMARY (LABC)		VICINITY MAP																			
LANDSCAPING		ASSESSOR PARCEL NO. (APN) 4303011001 BUILDING CODE: 2024 CALIFORNIA BUILDING CODE (CBC) ZONE: C4-1-O		LEGAL DESCRIPTION THE LAND REFERRED TO HEREIN BELOW IS SITUATED IN THE CITY OF LOS ANGELES, COUNTY OF LOS ANGELES, STATE OF CALIFORNIA, AND IS DESCRIBED AS FOLLOWS: LOTS 190 AND 191, TRACT 6721, IN THE CITY OF LOS ANGELES, BOOK 71, PAGE 21 OF MAPS, IN THE OFFICE OF THE COUNTY RECORDER.		STORY OCC USE FIRST S-2 PARKING 6,094 R-2 LOBBY,TRASH,RECYCLE 501 77 424 424 SECOND S-2 PARKING 6,607 R-2 LOBBY,(DOUBLE HEIGHT) ELEV,LOBBY 254 42 212 212 THIRD R-2 RESIDENTIAL 5,645 221 82 404 5,342 4,938 FOURTH R-2 RESIDENTIAL 5,645 221 82 404 5,342 4,938 FIFTH R-2 RESIDENTIAL 5,645 221 82 404 5,342 4,938 SIXTH R-2 RESIDENTIAL 5,645 221 82 404 5,342 4,938 SEVENTH R-2 RESIDENTIAL 5,645 221 82 404 5,342 4,938 ROOF R-2 404 404 TOTAL S-2 12,701 R-2 29,384 27,346 25,326																					
ELECTRICAL ENGINEER		CIVIL		STORIES: 7 - STORY (2)PARKING AND(5) RESIDENTIAL		REQUIRED TREES CALCULATION		PUBLIC TRANSPORTATION DISTANCE																			
MECHANICAL & PLUMBING		ELECTRICAL		PARKING CALCULATION AUTOMOBILE PARKING REQUIRED PER LAMC <table border="1"> <thead> <tr> <th>UNITS</th> <th># OF UNITS</th> <th>AUTO PARKING</th> <th>TOTAL</th> </tr> </thead> <tbody> <tr> <td>STUDIO</td> <td>5</td> <td>1</td> <td>5</td> </tr> <tr> <td>1- BDRM</td> <td>50</td> <td>1</td> <td>50</td> </tr> <tr> <td>TOTAL</td> <td>55</td> <td></td> <td></td> </tr> </tbody> </table> 100% AFFORDABLE PROJECT - NO PARKING IS REQUIRED. "27 AUTOMOBILE PARKING WILL BE PROVIDED"		UNITS	# OF UNITS	AUTO PARKING	TOTAL	STUDIO	5	1	5	1- BDRM	50	1	50	TOTAL	55			OPEN SPACE CALCULATION REQUESTED REDUCTION OF 50% IN THE OPEN SPACE PROVIDED: 2,750 SQ.FT		SEPARATE PERMIT - -FIRE ALARM SYSTEM & MONITORING -EMERGENCY RESPONDER RADIO COVERAGE -ACTIVE METHANE ALARM SYSTEM -SOLAR PHOTOVOLTAIC SYSTEM -HIGH-PILED COMBUSTIBLE STORAGE NOTE: APPLY FIRE TREATED WOOD FOR ALL EXTERIOR WALL ALL FIRE RATED DOORS TO BE SELF OR AUTOMATIC CLOSING. IMPORTANT NOTE FOR TYPE OF CONSTRUCTION: FRAMING (2-HR FIRE RATED MIN.) FOR TYPE III-A CONSTRUCTION BUILDING CONSTRUCTION TYPE: (FULLY SPRINKLERED NFPA-13) 5-LEVEL TYPE III-B OVER 2-LEVEL TYPE I-A			
UNITS	# OF UNITS	AUTO PARKING	TOTAL																								
STUDIO	5	1	5																								
1- BDRM	50	1	50																								
TOTAL	55																										
MECHANICAL		MECHANICAL		BICYCLE PARKING REQUIRED PER LAMC (LONG TERM) <table border="1"> <thead> <tr> <th>UNITS</th> <th># OF UNITS</th> <th>SPACES/UNIT</th> <th>TOTAL</th> </tr> </thead> <tbody> <tr> <td>1-25</td> <td>25</td> <td>1</td> <td>25</td> </tr> <tr> <td>26-55</td> <td>30</td> <td>1/1.5 UNITS</td> <td>30/1.5=20</td> </tr> <tr> <td>TOTAL</td> <td>55</td> <td></td> <td>25+20=45</td> </tr> </tbody> </table> REQUIRED PARKING PER BICYCLE ORDINANCE		UNITS	# OF UNITS	SPACES/UNIT	TOTAL	1-25	25	1	25	26-55	30	1/1.5 UNITS	30/1.5=20	TOTAL	55		25+20=45	REQUIRED PARKING PER BICYCLE ORDINANCE		LADBS APPROVAL STAMP			
UNITS	# OF UNITS	SPACES/UNIT	TOTAL																								
1-25	25	1	25																								
26-55	30	1/1.5 UNITS	30/1.5=20																								
TOTAL	55		25+20=45																								

NOTICE:
 THE DESIGNS SHOWN AND DESCRIBED HEREIN, INCLUDING ALL TECHNICAL DRAWINGS, GRAPHICS, AND MODELS THEREIN, ARE THE SOLE PROPERTY OF THE DESIGNER AND ARE NOT BE COPIED, DUPLICATED, REUSED OR COMMERCIAL EXPLOITED IN WHOLE OR IN PART WITHOUT THE WRITTEN PERMISSION OF THE DESIGNER.

ALL THESE DOCUMENTS HAVE BEEN PREPARED TO DESCRIBE NEW WORK ONLY AND DO NOT REPRESENT AS-BUILT OR ACCORDING TO EXISTING CONDITIONS. THE DESIGNER DOES NOT WARRANT THE ACCURACY OF THIS INFORMATION AND SHALL NOT BE RESPONSIBLE FOR DISCREPANCIES BETWEEN THIS DOCUMENT AND THE ACTUAL CONDITIONS. THESE DOCUMENTS ARE THE SOLE PROPERTY OF THE DESIGNER AND ARE AVAILABLE FOR LIMITED REVIEW AND EVALUATION AS INSTRUMENTS OF SERVICE AND NOT FOR COMMERCIAL PURPOSES.

CONTRACTORS, CONSULTING FIRMS, VENDORS AND OFFICE PERSONNEL ONLY IN ACCORDANCE WITH THIS NOTICE. DO NOT SCALE OFF THESE DRAWINGS. ALL RIGHTS RESERVED COPYRIGHT, BEVERLY DESIGN

OWNER :

8688 WEST PICO LLC

PROJECT :

8688 W Pico Blvd,
Los Angeles, CA 90035

SHEET TITLE:

COVER SHEET

REVISION:
 NO. DATE BY

SCALE :
 DRAWN :

DATE : December 25

JOB NUMBER :

SHEET

A.0

8688 W PICO BLVD LOS ANGELES, CA 90035

55 UNIT APARTMENTS 100% AFFORDABLE
100 % PRIVATELY FUNDED, NO TAX CREDIT NOT PUBLIC HOUSING NO PARKING REQUIRED FOR 100 % AFFORDABLE PROJECT. FULLY SPRINKLERED BUILDING

The logo for BEBERLY DESIGN, featuring the letters 'B' and 'DC' in a bold, sans-serif font. The 'B' is a dark grey block, and the 'DC' is a white block with a dark grey outline.

NOTICE:
THE DESIGNS SHOWN AND DESCRIBED
HEREIN, INCLUDING ALL TECHNICAL
DRAWINGS, GRAPHICS, AND MODELS
HEREOF, ARE PROPRIETARY AND SHALL NOT
BE COPIED, DUPLICATED, REUSED OR
COMMERCIALIZED EXPLOITED IN WHOLE OR IN
PART WITHOUT THE WRITTEN PERMISSION OF

ALL THESE DOCUMENTS HAVE BEEN
REPAVED TO DESCRIBE NEW WORK ONLY
AND DO NOT REPRESENT AS-BUILT OR
ACCURATE EXISTING CONDITIONS. THE
DESIGNER DOES NOT WARRANT IN ANY WAY
THE ACCURACY OF THIS INFORMATION AND
SHALL NOT BE RESPONSIBLE FOR
DISCREPANCIES BETWEEN THIS DOCUMENT
AND EXISTING CONDITIONS. THESE PLANS ARE
THE SOLE PROPERTY OF THE DESIGNER AND
ARE AVAILABLE FOR LIMITED REVIEW AND
EVALUATION AS 'INSTRUMENTS OF SERVICE'
BY THE CLIENT, CONSULTANTS,
CONTRACTORS, GOVERNING AGENCIES,
VENDORS AND OFFICE PERSONNEL ONLY IN
ACCORDANCE WITH THIS NOTICE. DO NOT
SCALE OFF THESE DRAWINGS. ALL RIGHTS
RESERVED COPYRIGHT, BEVERLY DESIGN

OWNER :

8688 WEST PICO LLC

PROJECT :

8688 W Pico Blvd,
Los Angeles, CA 90035

SHEET TITI

REVISION:

SCALE :

DATE : December 25

SHEET

A

A 01

A.

THE INFLUENCE OF THE CULTURE OF THE PARENTS ON THE CHILD'S LANGUAGE DEVELOPMENT 11

AREA PER UNIT

UNIT No	DESCRIPTION	AREA (SQ.FT.)	UNIT No	DESCRIPTION	AREA (SQ.FT.)	UNIT No	DESCRIPTION	AREA (SQ.FT.)	UNIT No	DESCRIPTION	AREA (SQ.FT.)	UNIT No	DESCRIPTION	AREA (SQ.FT.)	UNIT No	DESCRIPTION	AREA (SQ.FT.)	UNIT No	DESCRIPTION	AREA (SQ.FT.)
						301	1-BED/1-BATH	472	401	1-BED/1-BATH	472	501	1-BED/1-BATH	472	601	1-BED/1-BATH	472	701	1-BED/1-BATH	472
						302	1-BED/1-BATH	418	402	1-BED/1-BATH	418	502	1-BED/1-BATH	418	602	1-BED/1-BATH	418	702	1-BED/1-BATH	418
						303	1-BED/1-BATH	382	403	1-BED/1-BATH	382	503	1-BED/1-BATH	382	603	1-BED/1-BATH	382	703	1-BED/1-BATH	382
						304	1-BED/1-BATH	382	404	1-BED/1-BATH	382	504	1-BED/1-BATH	382	604	1-BED/1-BATH	382	704	1-BED/1-BATH	382
						305	1-BED/1-BATH	382	405	1-BED/1-BATH	382	505	1-BED/1-BATH	382	605	1-BED/1-BATH	382	705	1-BED/1-BATH	382
						306	1-BED/1-BATH	400	406	1-BED/1-BATH	400	506	1-BED/1-BATH	400	606	1-BED/1-BATH	400	706	1-BED/1-BATH	400
						307	1-BED/1-BATH	370	407	1-BED/1-BATH	370	507	1-BED/1-BATH	370	607	1-BED/1-BATH	370	707	1-BED/1-BATH	370
						308	1-BED/1-BATH	385	408	1-BED/1-BATH	385	508	1-BED/1-BATH	385	608	1-BED/1-BATH	385	708	1-BED/1-BATH	385
						309	1-BED/1-BATH	385	409	1-BED/1-BATH	385	509	1-BED/1-BATH	385	609	1-BED/1-BATH	385	709	1-BED/1-BATH	385
						310	1-BED/1-BATH	385	410	1-BED/1-BATH	385	510	1-BED/1-BATH	385	610	1-BED/1-BATH	385	710	1-BED/1-BATH	385
						311	STUDIO/1-BATH	340	411	STUDIO/1-BATH	340	511	STUDIO/1-BATH	340	611	STUDIO/1-BATH	340	711	STUDIO/1-BATH	340
FIRST FLOOR = 0 UNIT			SECOND FLOOR = 0 UNIT			3RD FLOOR = 11 UNITS			4TH FLOOR = 11 UNITS			5TH FLOOR = 11 UNITS			6TH FLOOR = 11 UNITS			7TH FLOOR = 11 UNITS		

ATTN. OWNERS/CONTRACTORS:

IT IS THE RESPONSIBILITY OF THE CONTRACTOR TO EXAMINE ALL PLANS AND SPECIFICATIONS PRIOR TO STARTING THE CONSTRUCTION WORK. CONTRACTOR SHALL VERIFY ALL DISCREPANCIES AND OMISSIONS. CONTRACTOR MAY CONTACT DESIGNER/ ENGINEER FOR ANY QUESTIONS DETAILS, SPECIFICATIONS AND CLARIFICATIONS. THE DESIGNER/ ENGINEER SHALL NOT BE RESPONSIBLE FOR ANY SHORTCOMING ON THE PART OF THE CONTRACTOR OR ANY ERROR CAUSED BY THE CONTRACTOR AS A RESULT OF LACK OF PLANNING AND/OR FORESIGHT. EACH CONTRACTOR SHALL VISIT THE SITE AND VERIFY ALL DIMENSIONS, GRADES AND CONDITIONS AT THE SITE BEFORE COMMENCING WORK AND REPORT ALL DISCREPANCIES AND MODIFIED FIELD CONDITIONS TO THE DESIGNER/ ENGINEER IN WRITING. CONTRACTOR MAY PROVIDE ONLY PRELIMINARY BIDS BASED ON THIS PLAN, IF THIS IS NOT APPROVED AND STAMPED BY THE CITY. FINAL BIDS SHALL BE BASED ON APPROVED PLANS ONLY. IF NO GENERAL CONTRACTORS RETAINED FOR THE JOB, KNOWLEDGEABLE PROJECT MANAGER/ JOB SUPERVISOR TO ACT AS HIS AGENT

TOTAL: 55 UNITS INCLUDING "50 ONE BEDROOM UNITS AND 5 STUDIO"

LADBS APPROVAL STAMP



NOTICE:
THE DESIGNS SHOWN AND DESCRIBED
HEREIN, INCLUDING ALL TECHNICAL
DRAWINGS, GRAPHICS, AND MODELS
THESE ARE THE SOLE PROPERTY OF THE
DESIGNER AND MAY NOT
BE COPIED, DUPLICATED, REUSED OR
COMMERCIALY EXPLOITED IN WHOLE OR IN
PART WITHOUT THE WRITTEN PERMISSION OF

ALL THESE DOCUMENTS HAVE BEEN
PREPARED TO DESCRIBE NEW WORK ONLY
AND DO NOT REPRESENT AS-BUILT OR
ACCORDING TO EXISTING CONDITIONS. THE
DESIGNER DECLINES ANY AND ALL LIABILITY
THE ACCURACY OF THIS INFORMATION AND
SHALL NOT BE RESPONSIBLE FOR
DISCREPANCIES BETWEEN THIS DOCUMENT
AND ANY OTHER DOCUMENTS. THESE ARE
THE SOLE PROPERTY OF THE DESIGNER AND
ARE AVAILABLE FOR LIMITED REVIEW AND
EVALUATION AS 'INSTRUMENTS OF SERVICE'
FOR THE USE OF CONTRACTORS, CONSULTANTS,
CONTRACTORS, CONSULTANTS, AGENCIES,
VENDORS AND OFFICE PERSONNEL ONLY IN
ACCORDANCE WITH THIS NOTICE. DO NOT
SCALE OFF THESE DRAWINGS. ALL RIGHTS
RESERVED COPYRIGHT, BEVERLY DESIGN

OWNER :

8688 WEST PICO LLC

PROJECT :

8688 W Pico Blvd,
Los Angeles, CA 90035

SHEET TITLE:

RENDERING

REVISION:
NO. DATE BY

SCALE :
DRAWN :

DATE : December 25
JOB NUMBER :


SHEET

R.1

LEGAL DESCRIPTION

THE LAND REFERRED TO HEREIN BELOW IS SITUATED IN THE CITY OF LOS ANGELES. COUNTY OF LOS ANGELES. STATE OF CALIFORNIA. AND IS DESCRIBED AS FOLLOWS:

LOTS 190 AND 191, TRACT 6721, IN HE CITY OF LOS ANGELES, BOOK 71, PAGE 21 OF MAPS, IN THE OFFICE OF THE COUNTY RECORDER.

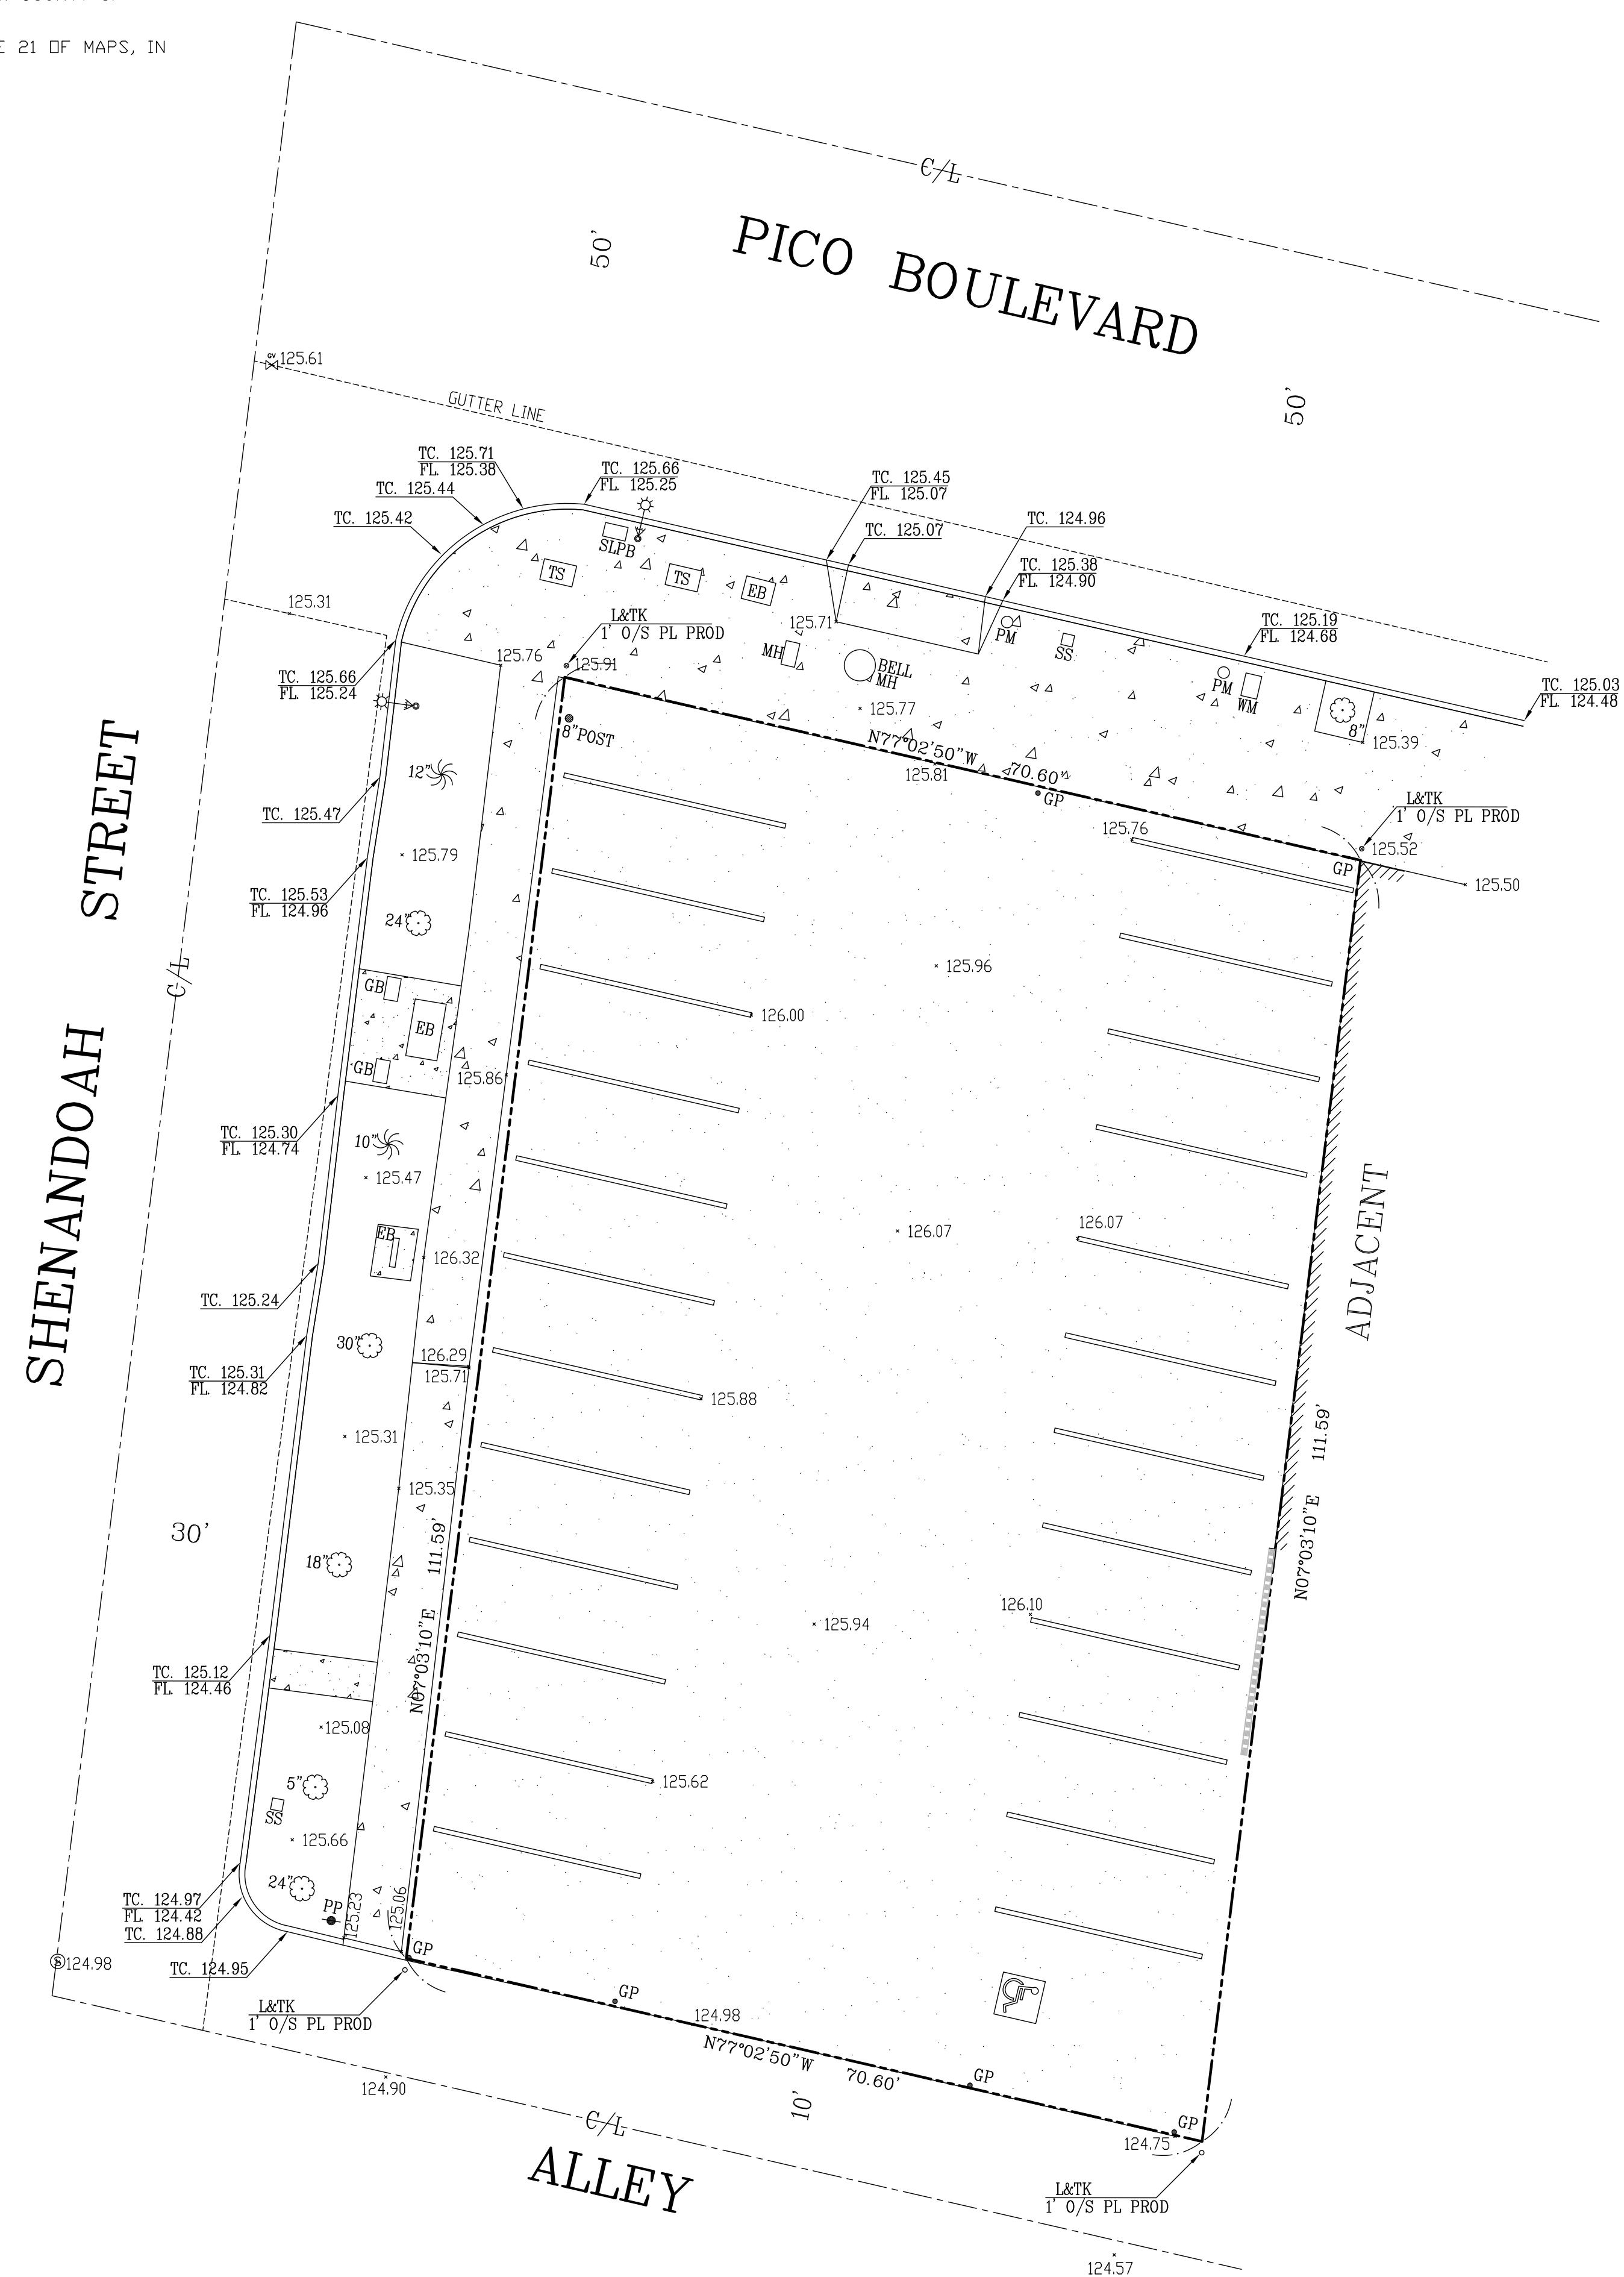

LEGEND	
WM	WATER METER
PP	POWER POLE
SLPB	STREET LIGHT BOX
PROJ	PROJECTION
PM	PARK METER
GB	GROUND BOX
C/L	CENTER LINE
TS	TRAFFIC SIGNAL
EB	ELECTRIC BOX
SLPB	STREET LIGHT BOX
TS	TERAFFIC SIGNAL BOX
	TRAFFIC LIGHT WITH STREET LIGHT
	GAS VALVE
	BOUNDARY LINE
	CENTERLINE
	TREE
	PALM
	CONC. BLOCK WALL
+	SPOT ELEVATION
SS	STREET SIGN
GP	GUARD POST
	ASPHALT PATTERN
	CONCRETE PATTERN

TOPOGRAPHIC SURVEY

PREPARED FOR:
ARZAD NOORULLAH
310-722-1177

NOTES:

1. THE LEGAL DESCRIPTION, BOUNDARIES AND EASEMENT SHOWN HEREON ARE PER RECORD DATA
2. MISC. DATA
TOTAL PROPERTY AREA: 7836.52 SQ.FT.


BENCH MARK:

FD WIRE SPK IN N CURB PICO BLVD
5' E OF SHENANDOAH ST.
ELEVATION=125.248'
BM NO. : 13-10690

No.	Revision/Issue	Date


Firm Name and Address

MOLAI LAND & DESIGN
24308 BURBANK BLVD
WOODLAND HILLS, CA 91367
818-325-9225
MOLAI22@YAHOO.COM

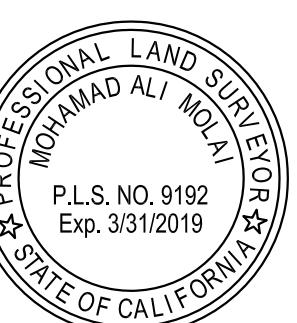


Project Name and Address

8688 WEST PICO BLVD.
LOS ANGELES, CA. 90035

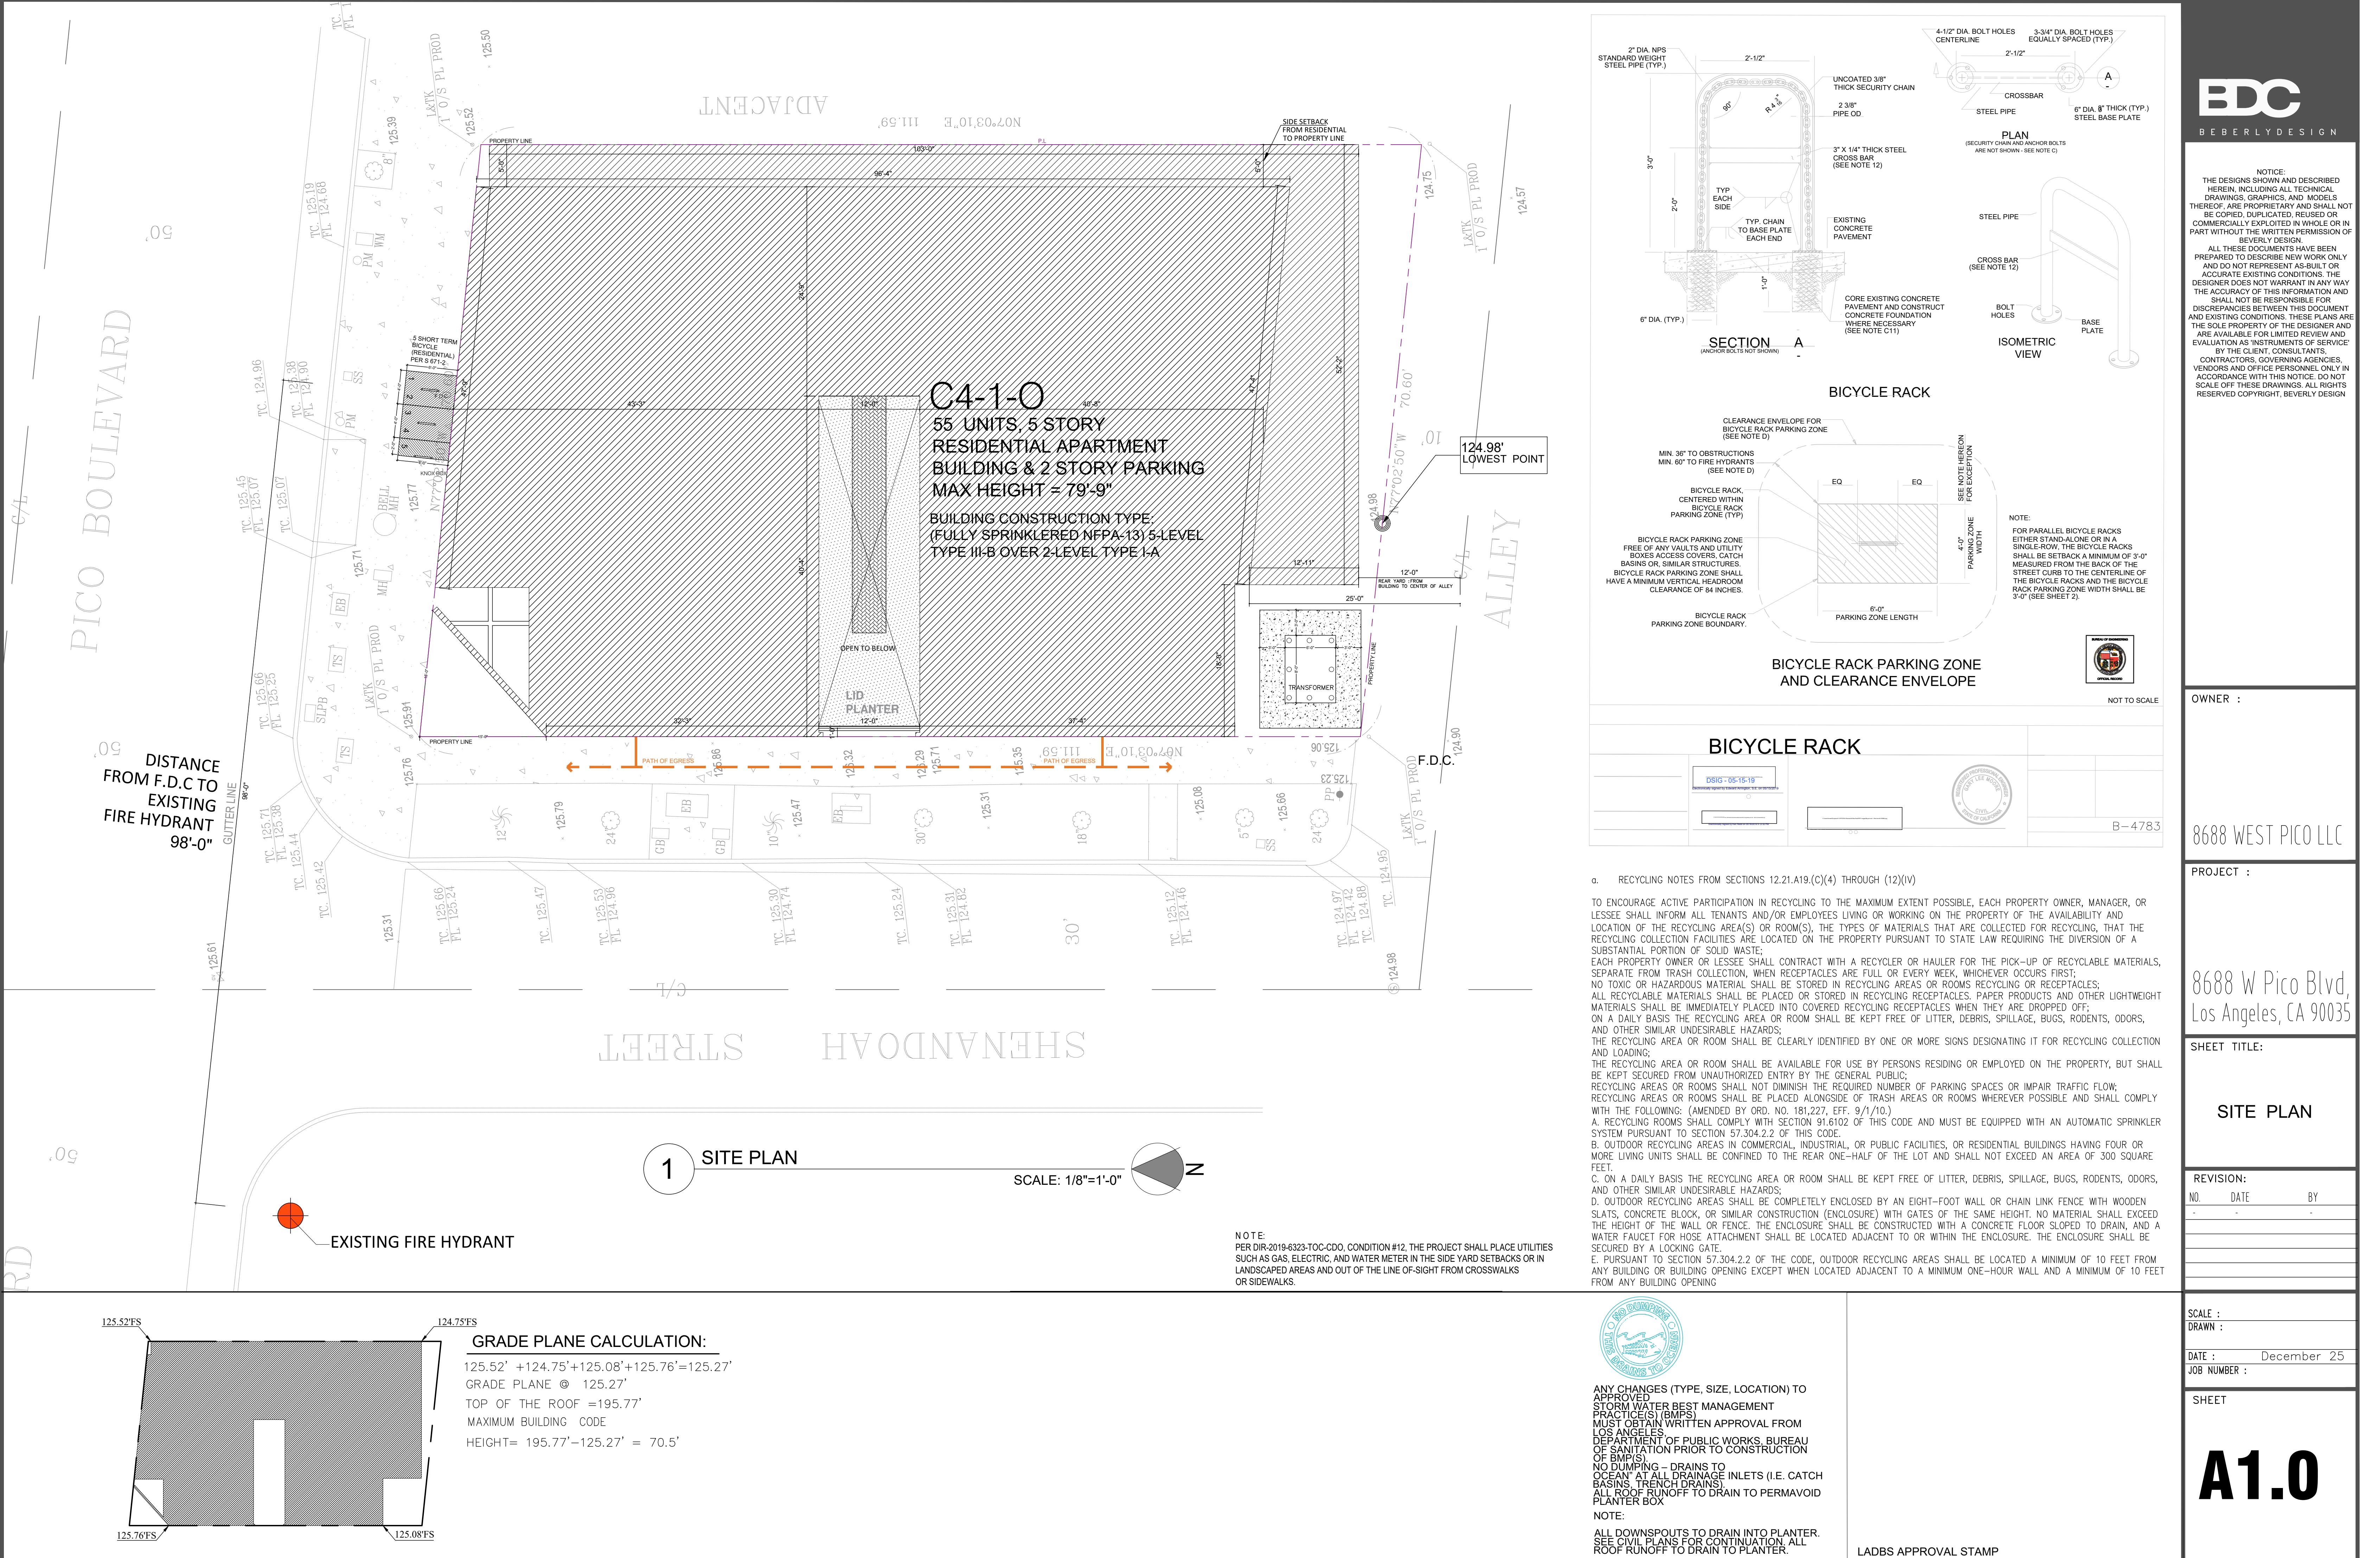

NOTICE:
THE DESIGNS SHOWN AND DESCRIBED
HEREIN, INCLUDING ALL TECHNICAL
DRAWINGS, GRAPHICS, AND MODELS
THEREOF, ARE PROPRIETARY AND SHALL NOT
BE COPIED, DUPLICATED, REUSED OR
COMMERCIALY EXPLOITED IN WHOLE OR IN
PART WITHOUT THE WRITTEN PERMISSION OF
BEVERLY DESIGN.
ALL THESE DOCUMENTS HAVE BEEN
PREPARED TO DESCRIBE NEW WORK ONLY
AND DO NOT CONSTITUTE AS A STATEMENT OF
ACCURATE EXISTING CONDITIONS. THE
DESIGNER DOES NOT WARRANT IN ANY WAY
THE ACCURACY OF THE INFORMATION AND
RESULTS OF THE DESIGN. IN THE EVENT OF
DISCREPANCIES BETWEEN THIS DOCUMENT
AND EXISTING CONDITIONS, THESE PLANS ARE
THE SOLE PROPERTY OF THE DESIGNER AND
ARE AVAILABLE FOR LIMITED REVIEW AND
EVALUATION AS A PAYMENT OF SERVICE
BY THE CLIENT, CONSULTANTS,
CONTRACTORS, GOVERNING AGENCIES,
VENDORS AND OFFICE PERSONNEL ONLY IN
ACCORDANCE WITH THIS NOTICE. NO COPIES
SHALL BE MADE OF THESE DRAWINGS. ALL RIGHTS
RESERVED. COPYRIGHT, BEVERLY DESIGN

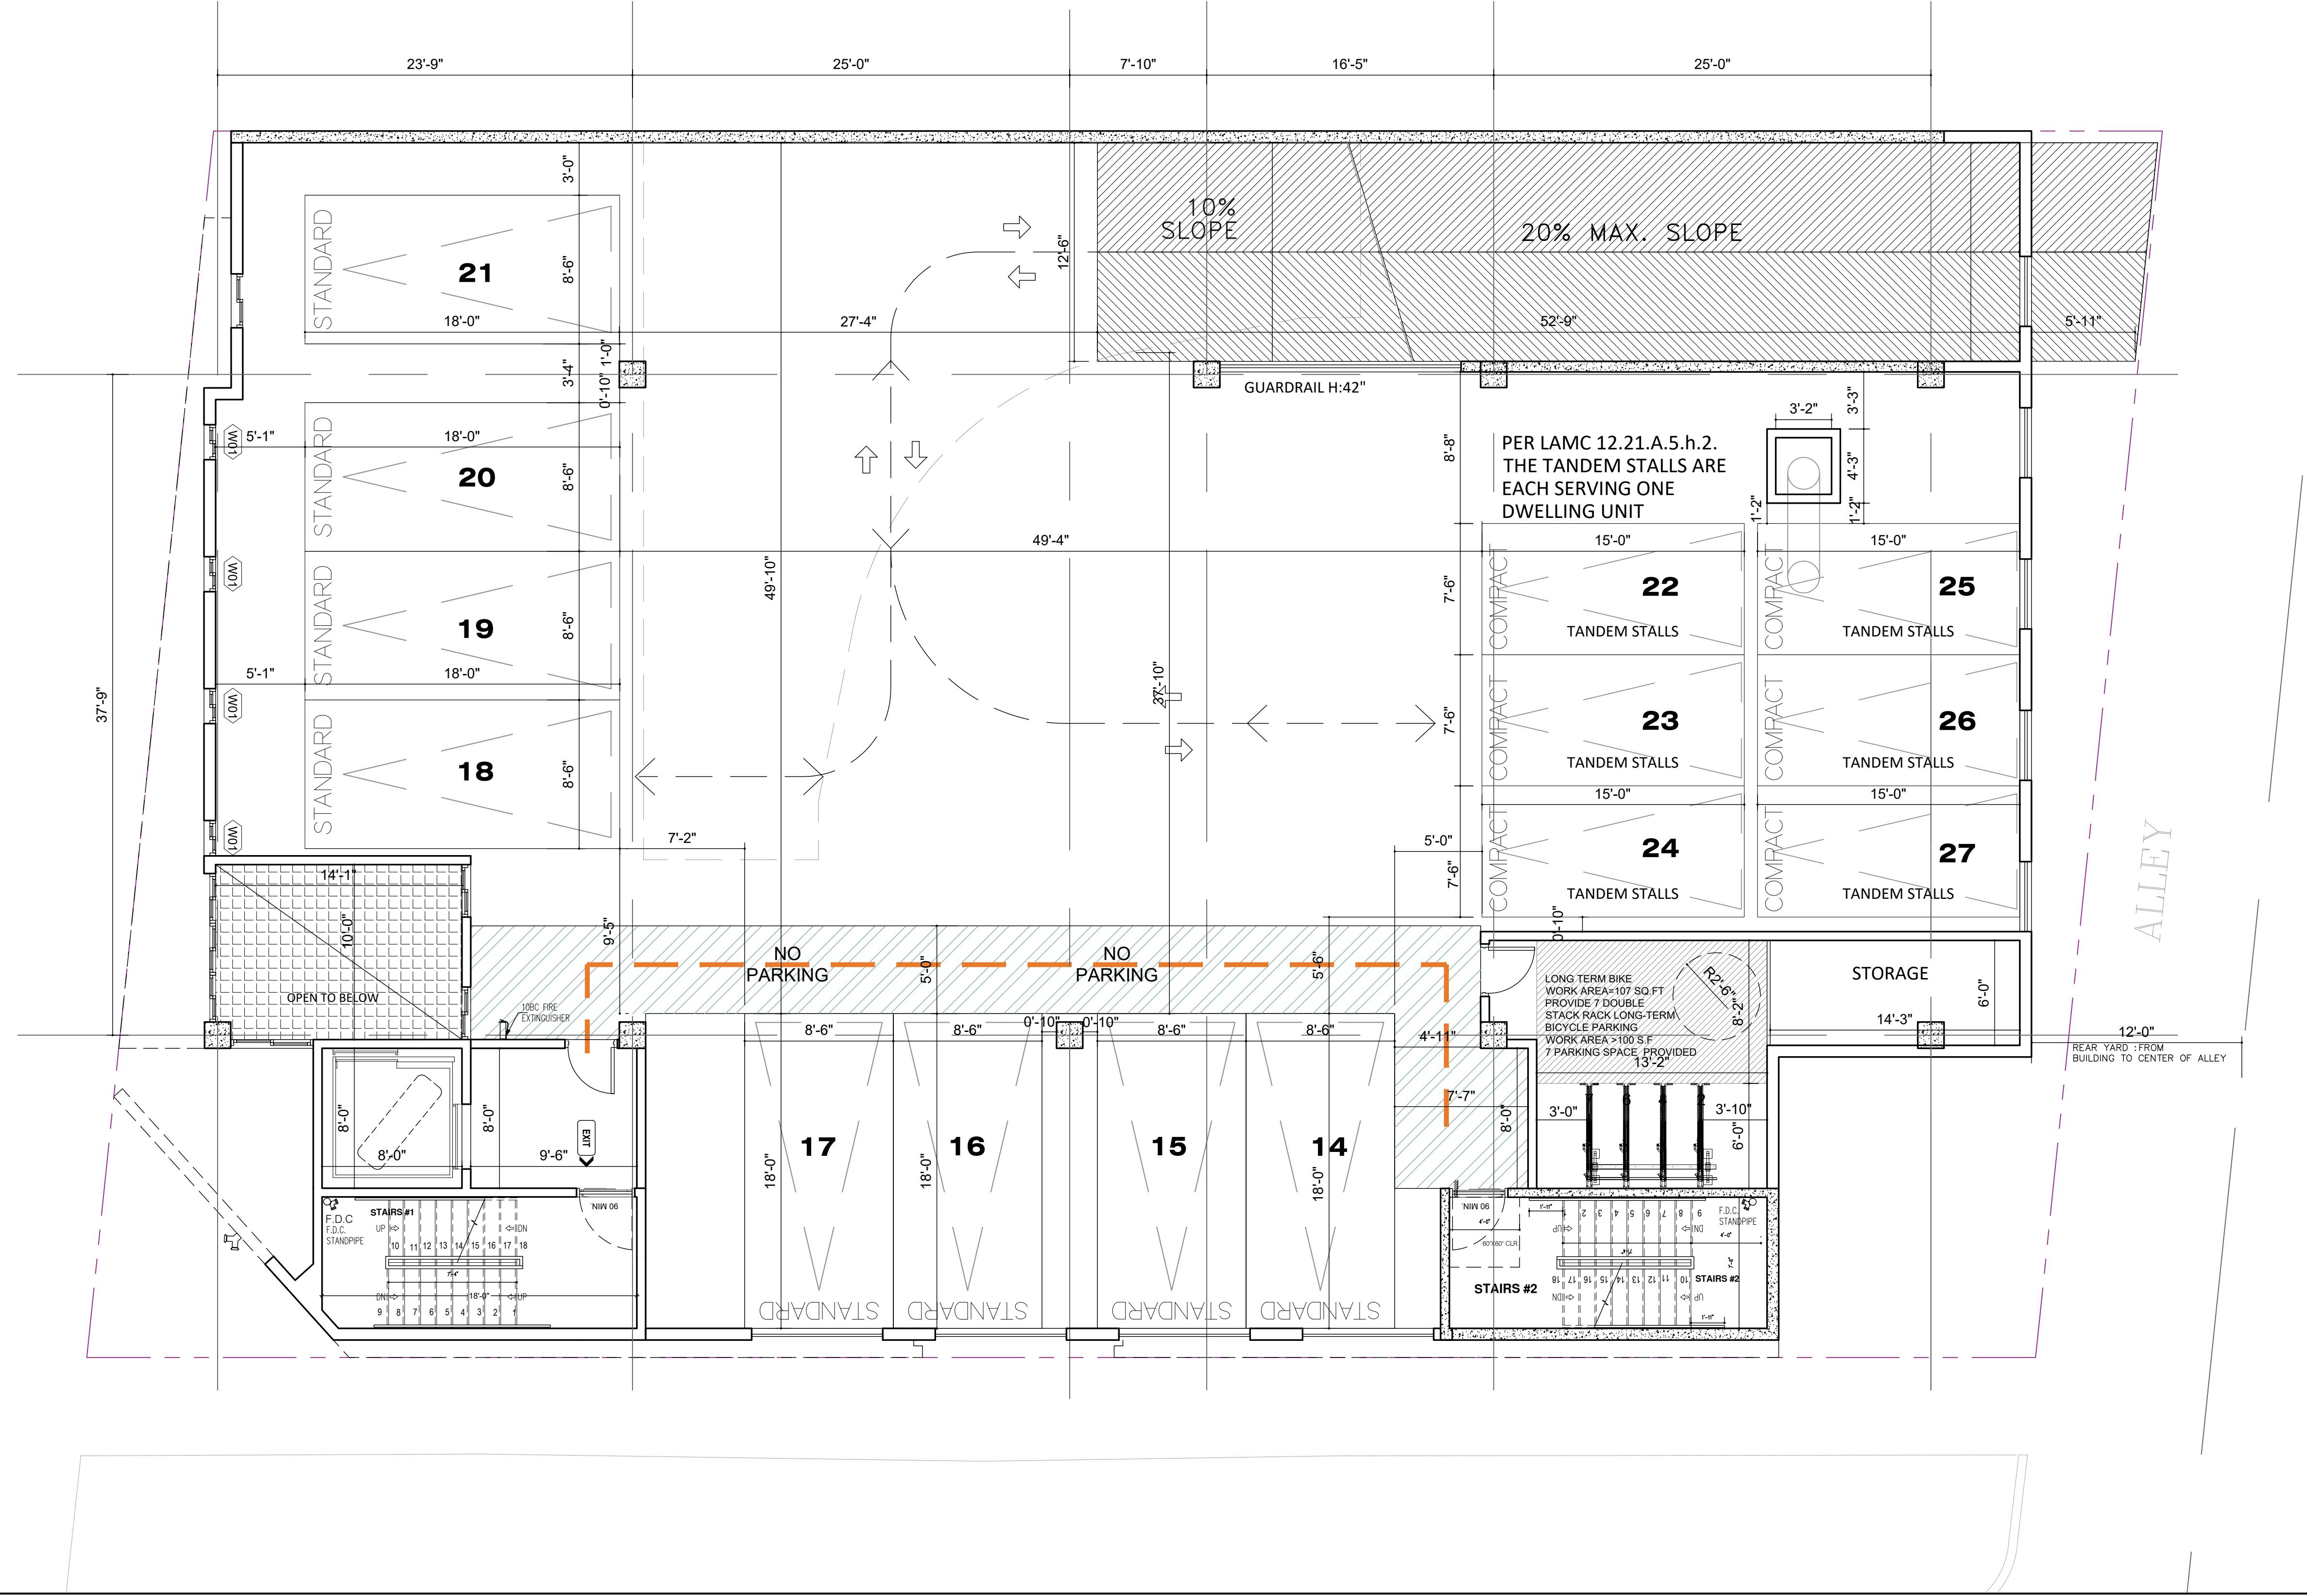

FLOOR PLAN NOTES

1. REFER TO ENLARGED UNIT, STAIR AND ELEVATOR CORE PLANS FOR ADDITIONAL INFORMATION.
2. ALL DIMENSIONS ARE TO FACE OF MASONRY, CONCRETE, OR STUDS, U.N.O.
3. ALL WALLS TO TERMINATE TO UNDERSIDE OF FLOOR/CEILING/ROOF ASSEMBLY ABOVE U.N.O.
4. ALL METAL/METAL INTERIOR WALLS TO RECEIVE A MINIMUM OF (1) LAYER OF 5/8" GYPSUM WALL BOARD, EACH SIDE, U.N.O.
5. ALIGN FACE OF WALL FINISH WITH ADJACENT FACE OF COLUMN WHERE OCCURS, U.N.O.
6. ALIGN INTERIOR FACE OF SHAFT WALL FINISH WITH SLAB EDGE OF SHAFT OPENING TYP. U.N.O.
7. MAX. EXTERIOR WALKWAYS INCLUDING BALCONY AND DECK SURFACES TO SLOPE A MAXIMUM OF 10%.
8. WHERE DOORS ARE NOT DIMENSIONED DOORS SHALL BE INSTALLED WITH HINGE SIDE AT 4" FROM ADJACENT FRAMED WALL.
9. PROVIDE ANTI-GRAFFITI FINISH AT THE FIRST 9 FEET, MEASURED FROM GRADE, AT EXTERIOR WALLS AND DOORS.
10. ALL ELEVATOR AND STAIR ENTRANCE SIGNS SHALL BE PROVIDED IN ALL INTERIOR CORRIDORS OR GROUP A E.R-2.1 (C) 1013.7

11. NONABSORBENT INTERIOR FLOOR AND WALL FINISHES SHALL BE USED WITHIN AT LEAST 2 FEET AROUND AND PERPENDICULAR TO EXTERIOR ENTRIES AND/OR OPENINGS SUBJECT TO FOOT TRAFFIC.
12. WHERE REQUIRED BY NFPA 13 SECTION 8.15.1, PROVIDE FIRE SPRINKLER AT ALL VERTICAL CLEAR SPACES THAT ARE CONSTRUCTED OF COMBUSTIBLE SPACES, WHERE ALTERNATE METHOD ARE ALLOWED, ONE OF THE FOLLOWING OPTIONS MAY BE USED UNLESS NOTED OTHERWISE.
A. NFPA 13 SECTION 8.15.1.7 FILL CONCEALED SPACE ENTIRELY WITH NONCOMBUSTIBLE INSULATION.
B. NFPA 13 SECTION 8.15.1.2.10 FINISH THE CONCEALED SPACE WITH TYPE X GYP BD, AND NO ACCESS PROVIDED TO THE SPACE.
C. NFPA 13 SECTION 8.15.1.2.18.2 COMBUSTIBLE SOFFITS, EAVES, OVERHANG AND DECORATIVE ELEMENTS SHALL BE DRAFT STOPPED, VOLUME NOT TO EXCEED 160 CUBIC FT, OR SECTION 8.15.1.2.14 VERTICAL PIPE CHASES UNDER 10 SF WHERE PROVIDED IN MULTIFLOOR BUILDINGS WHERE THE CHASES ARE FIRESTOPPED AT EACH FLOOR USING METAL SHEATHING, AND DRAFT STOPPED AT THE FLOOR CONSTRUCTION, AND WHERE SUCH PIPE CHASE SHALL CONTAIN NO SOURCE OF IGNITION.

13. AISLE AND AISLE ACCESSWAYS SERVING AS A PORTION OF THE EXIT ACCESS IN THE MEANS OF EGRESS SYSTEM SHALL COMPLY WITH CBC SECTION 1018. THE MINIMUM WIDTH OR REQUIRED CAPACITY OF AISLES SHALL BE UNOBSTRUCTED.

NOTES:

- DOUBLE STRIPING OF STALLS SHALL BE PER ZONING CODE SECTION 12.21A5, CHART NO. 5.
- USEABLE ENCLOSED SPACE UNDER ELEVATOR SHAFTS AS ELEVATOR, STAIRS, ETC.
- STEWARTS SHALL BE PROVIDED WITH A 2 HR FIRE-RESISTANCE RATED CONSTRUCTION OR THE SAME FIRE RATING OF THE STAIRS ENCLOSURE WHICHEVER IS GREATER. (1009.6.3)
- BASE CABINETS DIRECTLY UNDER THE KITCHEN SINK COUNTER AREA, INCLUDING TOEBOARD AND SHELVING, SHALL BE REMOVABLE WITHOUT THE USE OF SPECIALIZED TOOLS OR KNOWLEDGE IN ORDER TO PERMIT EASIER SPACES FOR A WHEELCHAIR TO TURN.
- THE KITCHEN SINK COUNTER AREA SHALL BE EXTENDED TO THE WALL TYP. (1133A)
- MAXIMUM CLEARANCE TO THE EXTERIOR WALL IS 10' 0".
- KITCHEN COUNTER HEIGHT SHALL BE MAX. 36" MAX MATERIAL IS GRANITE STONE.
- 4" SWING FROM THE BATHROOM DOOR IS MAX. 36" MAX MATERIAL IS GRANITE STONE.
- 9. PROVIDE ANTI-GRAFFITI FINISH AT THE FIRST 9 FEET, MEASURED FROM GRADE, AT EXTERIOR WALLS AND DOORS.
10. ALL ELEVATOR AND STAIR ENTRANCE SIGNS SHALL BE PROVIDED IN ALL INTERIOR CORRIDORS OR GROUP A E.R-2.1 (C) 1013.7

GREEN BUILDING CODE NOTES

1. A SEPARATE ELECTRICAL PLAN CHECK IS REQUIRED TO VERIFY THE RACEWAY METHOD(S), WIRING SCHEMATIC(S) AND ELECTRICAL CONNECTIONS FOR THE ELECTRICAL CHARGING SYSTEM. THE ELECTRICAL SYSTEM SHALL HAVE SUFFICIENT CAPACITY TO SIMULTANEOUSLY CHARGE ALL ELECTRIC VEHICLES AT THEIR FULL RATED AMPERAGE.
2. THE SERVICE PANEL OR SUBPANEL(S) SHALL HAVE SUFFICIENT CAPACITY TO ACCOMMODATE THE REQUIRED NUMBER OF DEDICATED 40 AMPERE MINIMUM BRANCH CIRCUITS FOR THE INSTALLATION OF THE EVSE.
3. THE ELECTRICAL SYSTEM SHALL HAVE SUFFICIENT CAPACITY TO SIMULTANEOUSLY CHARGE ALL DESIGNATED EV SPACES AT THE FULL RATED AMPERAGE OF THE EVSE. PLAN DESIGN SHALL BE BASED UPON A 40-AMPERE MINIMUM BRANCH CIRCUIT. A SEPARATE ELECTRICAL PERMIT IS REQUIRED.
4. THE SERVICE PANEL OR SUBPANEL CIRCUIT DIRECTORY SHALL IDENTIFY THE OVERCURRENT PROTECTIVE DEVICE SPACES RESERVED FOR FUTURE EV CHARGING PURPOSES AS EV CAPABLE IN ACCORDANCE WITH THE LOS ANGELES ELECTRICAL CODE. THE RACEWAY TERMINATION SHALL BE PERMANENTLY AND VISIBLY MARKED AS "EV CAPABLE".
- EXHAUST FAN SHALL BE ENERGY STAR COMPLIANT AND BE DUCTED TO TERMINATE TO THE OUTSIDE OF THE BUILDING.
- EXHAUST FAN NOT FUNCTIONING AS A COMPONENT OF A WHOLE HOUSE VENTILATION SYSTEM, MUST BE CONTROLLED BY A HUMIDITY CONTROL DEVICE. THE EXHAUST FAN SHALL NOT BE CONTROLLED BY A THERMOSTAT AND CONTAINING 50 LBS OR LESS SHALL INSTALL A SEPARATE METER OR SUBMETER WITHIN COMMON AREA SAND WITH EACH INDIVIDUAL DWELLING UNIT.
- THE ELECTRICAL SYSTEM SHALL HAVE SUFFICIENT CAPACITY TO SIMULTANEOUSLY CHARGE ALL DESIGNATED EV SPACE AT THE FULL RATED AMPERAGE OF THE EVSE. PLAN DESIGN SHALL BE BASED UPON A 40-AMPERE MINIMUM BRANCH CIRCUIT. A SEPARATE ELECTRICAL PERMIT IS REQUIRED.
- THE SERVICE PANEL OR SUBPANEL CIRCUIT DIRECTORY SHALL IDENTIFY THE OVERCURRENT PROTECTIVE DEVICE SPACES RESERVED FOR FUTURE EV CHARGING PURPOSES AS EV CAPABLE IN ACCORDANCE WITH THE LOS ANGELES ELECTRICAL CODE (4.106.2, 4.106.4).
11. SWITCHES, OUTLETS AND CONTROLS SHALL COMPLY WITH SECTION 1134.2.
12. REINFORCED WALLS TO ALLOW FOR THE FUTURE INSTALLATION OF GRAB BARS. GRAB BAR SHALL COMPLY WITH SECTION 1134.6 FOR BATHTUBS, 1134.6 FOR SHOWERS AND 1134.7 FOR WATER FOUNTAINS.

GARAGE NOTES

1. STRIPING AT ACCESSIBLE PARKING STALLS, ACCESSIBLE PARKING AISLES AND ACCESSIBLE CROSSWALKS SHALL BE 3-INCH WIDE, BLUE PAINTED TRAFFIC GRADE STRIPING.
2. PROVIDE 4" WIDE WHITE PAINTED STRIPING ADJACENT TO ALL DRIVE AISLES EXCEPT AT PARKING STALLS.
3. PROVIDE 4" WIDE WHITE PAINTED STRIPING ADJACENT TO ALL VERTICAL PLUMBING OR FIRE SPRINKLER LINES LOCATED ADJACENT TO COLUMN OR WALLS AT HEAD LEVEL OF PARKING. REFER TO PLUMBING AND FIRE SPRINKLER DRAWINGS FOR LOCATIONS.
4. ALL GARAGE AREAS TO HAVE A MINIMUM 7'-0" HEAD CLEARANCE HEIGHT.
5. FOR REQUIRED DRIVE AISLE TURNING RADIUS CLEARANCES SEE DIAGRAM PROVIDED.
6. THE SURFACE SLOPE FOR EV SPACES SHALL NOT EXCEED 2.083% IN ANY DIRECTION.
7. 7'-0" MIN. CLEAR HEIGHT IS REQUIRED TO ANY OBSTRUCTION AT ACCESSIBLE PARKING STALLS AND ACCESS AISLES LEADING TO ACCESSIBLE PARKING STALLS.
8. 7'-0" MIN. CLEAR HEIGHT IS REQUIRED TO ANY OBSTRUCTION AT ALL PARKING AREAS, UNLESS NOTED OTHERWISE.
10. PARKING AREAS AS ENCLOSED PARKING GARAGE, PROVIDE MECHANICAL VENTILATION PER CALIFORNIA MECHANICAL CODE.

NOTE

1. ALL FIRE PARTITION WALLS (LABC 708) SHALL BE 1 HOUR RATED STC50.
2. WALLS (FIRE BARRIERS 707.3.1) IN SHAFTS AS ELEVATOR, STAIRS, ETC.
3. FIRE PARTITION CORRIDORS SHALL BE 1 HOUR RATED.
4. ALL BEARING WALLS SHALL BE 1 HOUR RATED.
5. THE FLOOR/CEILING ASSEMBLIES SHALL BE 1 HOUR RATED STC50.
7. NON-COMBUSTIBLE DRAFT STOP SHALL BE PROVIDED.
8. Recycling chutes shall be clearly marked "RECYCLING ONLY" at every point of entry.

NOMINAL WALL THICKNESS / STUD SIZE
(2x 2-1/2" STUDS FOR METAL FRAMED TYPES)
(4x 3-5/8" STUD FOR METAL FRAMED TYPES)
(4x 2x4 STUD FOR WOOD FRAMED TYPES)
(6x 2x6 STUD FOR WOOD FRAMED TYPES)

NOTE

1. ALL FIRE PARTITION WALLS (LABC 708) SHALL BE 1 HOUR RATED STC50.
2. WALLS (FIRE BARRIERS 707.3.1) IN SHAFTS AS ELEVATOR, STAIRS, ETC.
3. FIRE PARTITION CORRIDORS SHALL BE 1 HOUR RATED.
4. ALL BEARING WALLS SHALL BE 1 HOUR RATED.
5. THE FLOOR/CEILING ASSEMBLIES SHALL BE 1 HOUR RATED STC50.
7. NON-COMBUSTIBLE DRAFT STOP SHALL BE PROVIDED.
8. Recycling chutes shall be clearly marked "RECYCLING ONLY" at every point of entry.

SCALE :

DRAWN :


DATE : December 25

JOB NUMBER :

SHEET

A2.1

LADBS APPROVAL STAMP

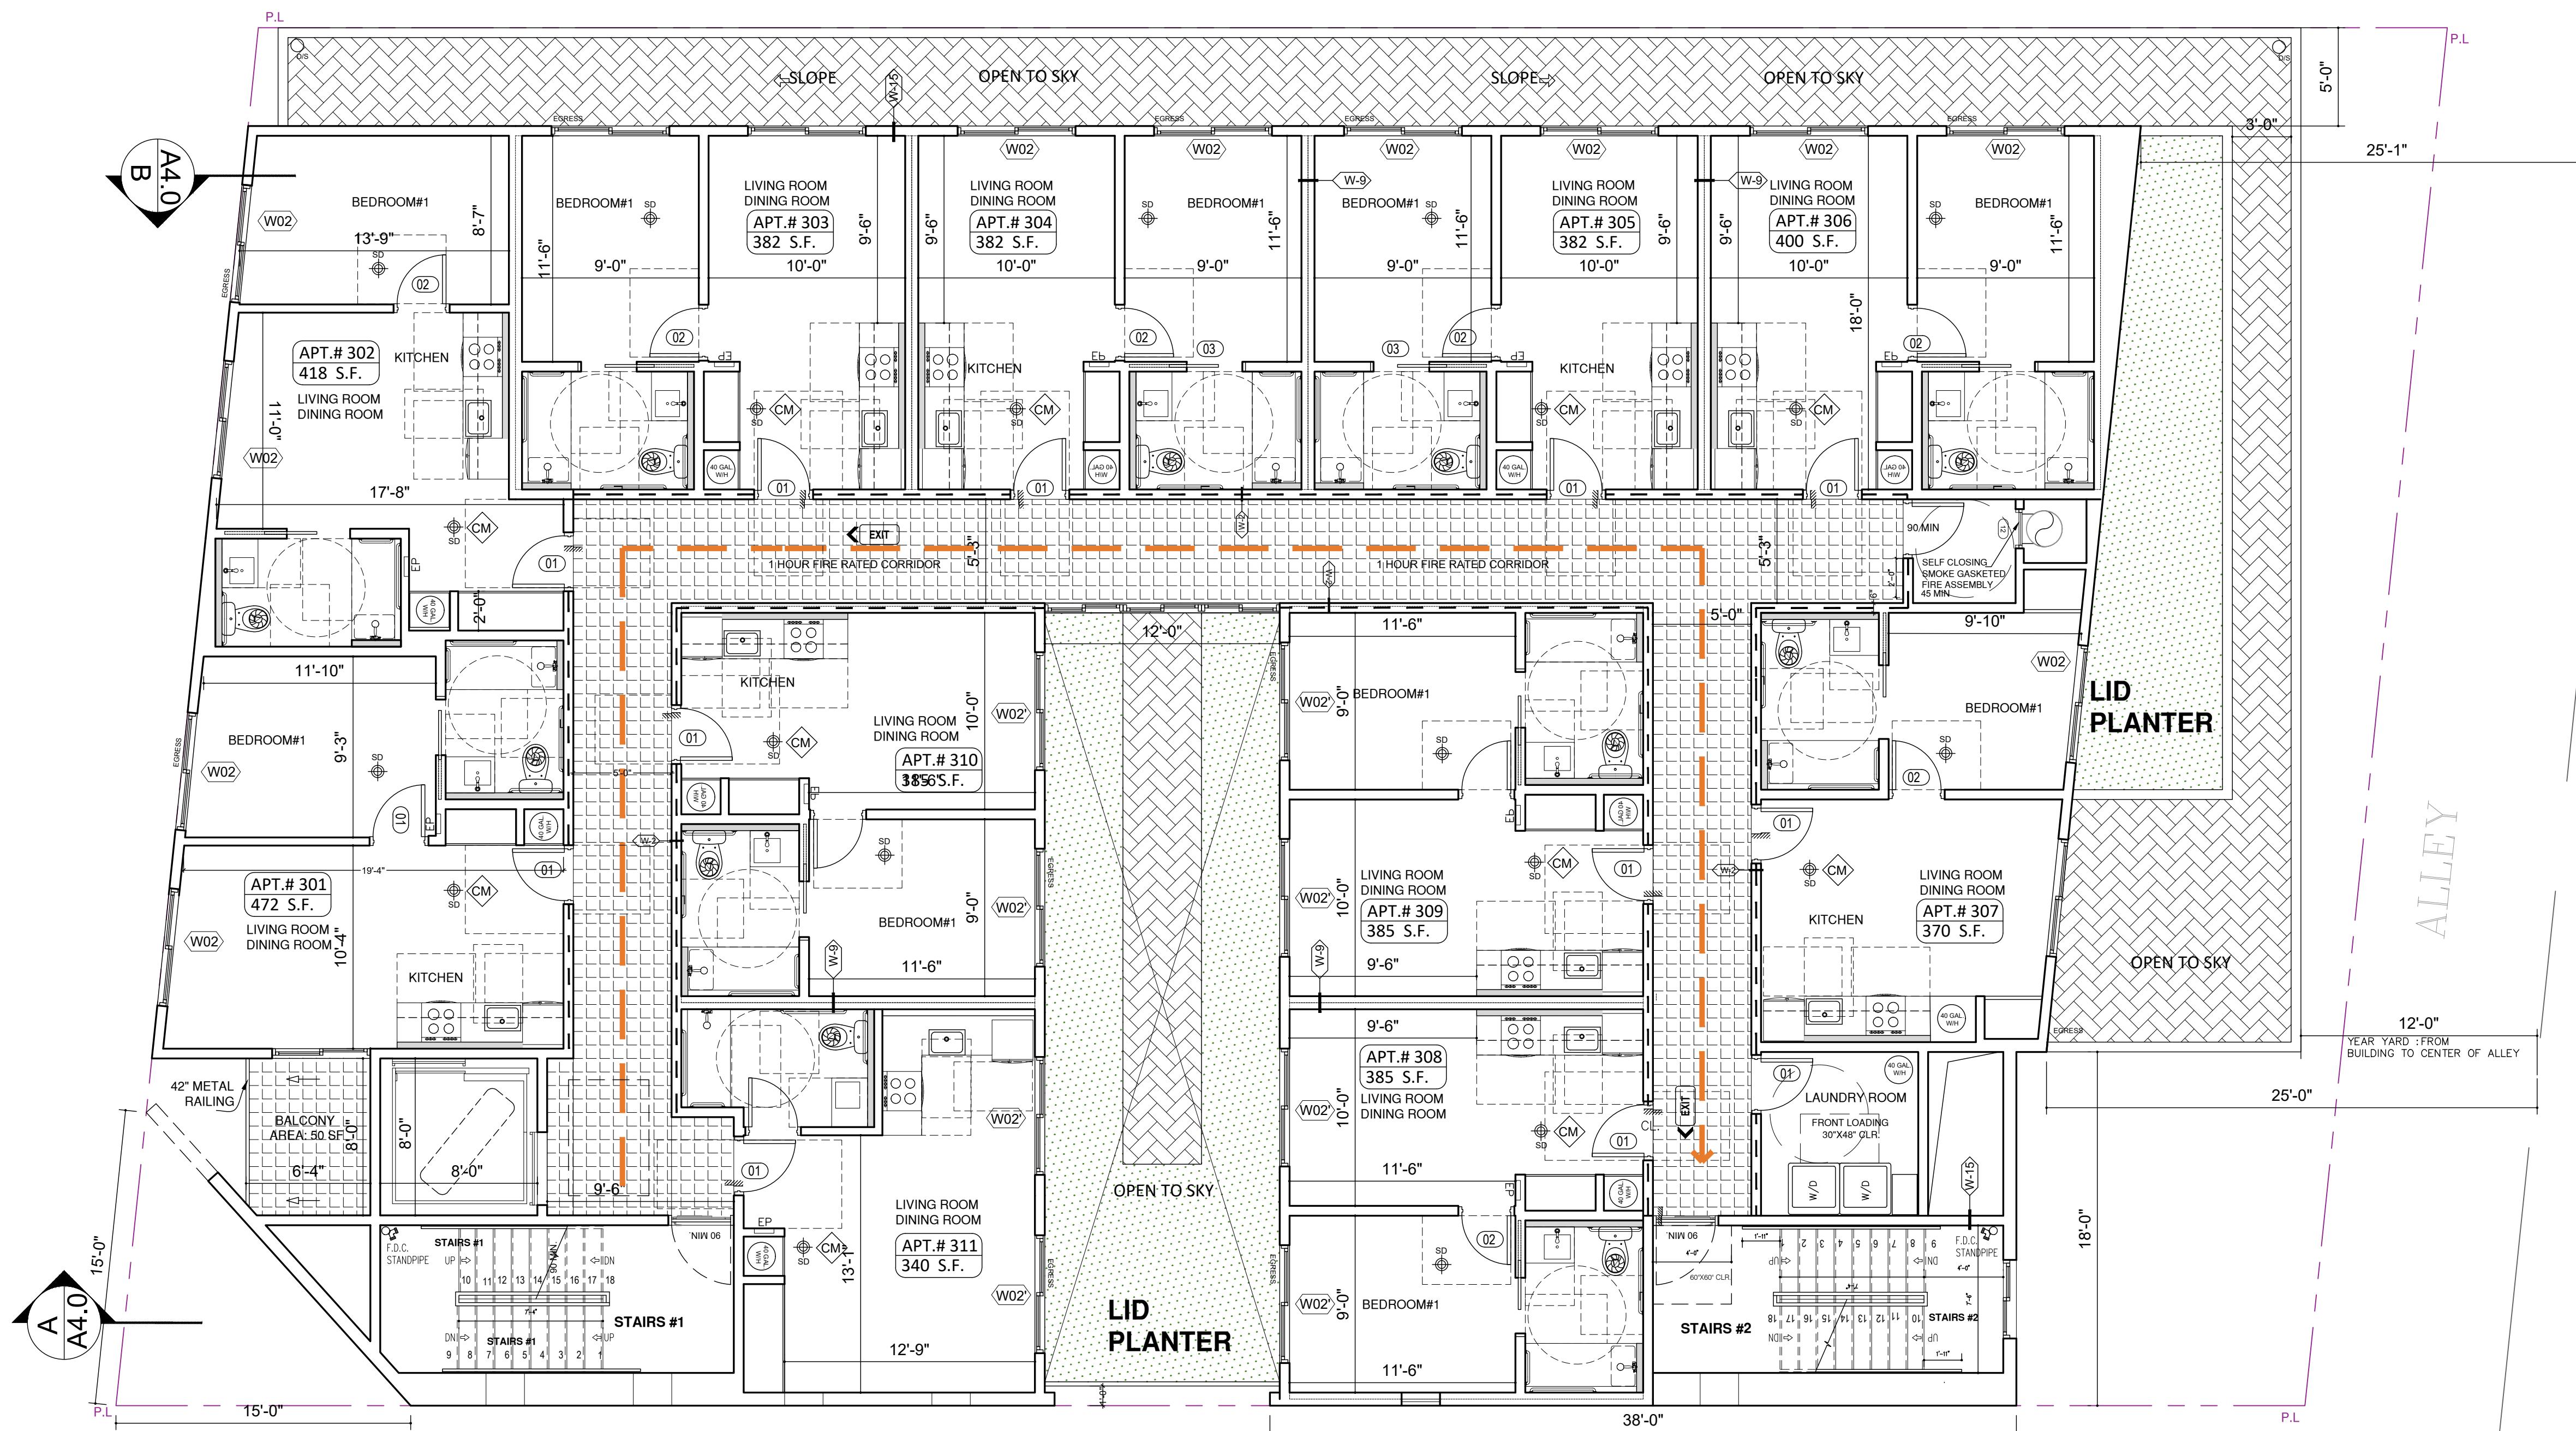

3RD FLOOR PLAN

SCALE: 3/16"=1'-0"

NOTICE:
THE DESIGNS SHOWN AND DESCRIBED
HEREIN, INCLUDING ALL TECHNICAL
DRAWINGS, GRAPHICS AND MODELS
THEREOF, ARE PROPRIETARY AND SHALL NOT
BE COPIED, DUPLICATED, REUSED OR
COMMERCIALY EXPLOITED IN WHOLE OR IN
PART WITHOUT THE WRITTEN PERMISSION OF
BEVERLY DESIGN.
ALL THESE DOCUMENTS HAVE BEEN
PREPARED TO DESCRIBE NEW WORK ONLY
AND DO NOT REFLECT AS-UILT OR
ACCURATE EXISTING CONDITIONS. THE
DESIGNER DOES NOT WARRANT IN ANY WAY
THE ACCURACY OF THE INFORMATION AND
DISCREPANCIES BETWEEN THIS DOCUMENT
AND EXISTING CONDITIONS, THESE PLANS ARE
THE SOLE PROPERTY OF THE DESIGNER AND
ARE AVAILABLE FOR LIMITED REVIEW AND
EVALUATION AS PART OF THE SERVICE OF WORK
BY THE CLIENT CONSULTANTS.
CONTRACTORS, GOVERNING AGENCIES,
VENDORS AND OFFICE PERSONNEL ONLY IN
ACCORDANCE WITH THIS NOTICE, SHALL
SOLELY OWN THESE DRAWINGS. ALL RIGHTS
RESERVED, COPYRIGHT, BEVERLY DESIGN

OWNER :

8688 WEST PICO LLC

PROJECT :

8688 W Pico Blvd,
Los Angeles, CA 90035

SHEET TITLE:

SECOND FLOOR
PLAN

REVISION:

NO. DATE BY

FLOOR PLAN NOTES

- REFER TO ENLARGED UNIT, STAIR AND ELEVATOR CORE PLANS FOR ADDITIONAL INFORMATION.
- ALL DIMENSIONS ARE TO FACE OF MASONRY, CONCRETE, OR STUDS, U.N.O.
- ALL WALLS TO TERMINATE TO UNDERSIDE OF FLOOR/CEILING/ROOF ASSEMBLY ABOVE U.N.O.
- ALL WOOD/METAL INTERIOR WALLS TO RECEIVE A MINIMUM OF (1) LAYER OF 5/8" GYPSUM WALL BOARD, EACH SIDE, U.N.O.
- ALIGN FACE OF WALL FINISH WITH ADJACENT FACE OF COLUMN WHERE OCCURS, U.N.O.
- ALIGN INTERIOR FACE OF SHAFT WALL FINISH WITH SLAB EDGE OF SHAFT OPENING TYP. U.N.O.
- EXTERIOR WALKWAYS INCLUDING BALCONY AND DECK SURFACES TO SLOPE A MAXIMUM OF 10%.
- WHERE DOORS ARE NOT DIMENSIONED DOORS SHALL BE INSTALLED WITH HINGE SIDE AT 4" FROM ADJACENT FRAMED WALL.
- PROVIDE ANTI-GRAFFITI FINISH AT THE FIRST 9 FEET, MEASURED FROM GRADE, AT EXTERIOR WALLS AND DOORS.
- ADMONITION: EX SIGNS SHALL BE PROVIDED IN ALL INTERIOR CORRIDORS OF GROUP A & R-2-1 (C-1013.7)
- NONABSORBENT INTERIOR FLOOR AND WALL FINISHES SHALL BE USED WITHIN AT LEAST 2 FEET AROUND AND PERPENDICULAR TO EXTERIOR ENTRIES AND/OR OPENINGS SUBJECT TO FOOT TRAFFIC.
- WALLS REQUIRED BY NFPA 13 SECTION 8.15.1, PROVIDE FIRE SPRINKLER AT ALL VERTICAL SPACES THAT ARE CONSTRUCTED OF COMBUSTIBLE SPACES, WHERE ALTERNATE METHOD ARE ALLOWED, ONE OF THE FOLLOWING OPTIONS MAYBE USED UNLESS NOTED OTHERWISE:
 - A. NFPA 13 SECTION 8.15.1.2.7 FILL CONCEALED SPACE ENTIRELY WITH NONCOMBUSTIBLE INSULATION.
 - B. NFPA 13 SECTION 8.15.1.2.7 FINISH THE CONCEALED SPACE WITH TYPE 'X' GYP BD. AND NFPA 13 SECTION 8.15.1.2.8.2 COMBUSTIBLE SOFTS, EAVES, OVERHANG AND DECORATIVE ELEMENTS SHALL BE DRAFT STOPPED, VOLUME NOT TO EXCEED 160 CUBIC FT. OR SECTION 8.15.1.2.14 VERTICAL PIPE CHASES UNDER 10 SF WHERE PROVIDED IN MULTIFLOOR BUILDINGS WHERE THE CHASES ARE FIRESTOPPED AT EACH FLOOR USING METAL FIRESTOPPING, THE FLOOR CONSTRUCTION, AND WHERE SUCH FIRE STOP SHALL CONTAIN NO SOURCE OF IGNITION.
 - C. NFPA 13 SECTION 8.15.1.2.18.2 COMBUSTIBLE SOFTS, EAVES, OVERHANG AND DECORATIVE ELEMENTS SHALL BE DRAFT STOPPED, VOLUME NOT TO EXCEED 160 CUBIC FT. OR SECTION 8.15.1.2.14 VERTICAL PIPE CHASES UNDER 10 SF WHERE PROVIDED IN MULTIFLOOR BUILDINGS WHERE THE CHASES ARE FIRESTOPPED AT EACH FLOOR USING METAL FIRESTOPPING, THE FLOOR CONSTRUCTION, AND WHERE SUCH FIRE STOP SHALL CONTAIN NO SOURCE OF IGNITION.
- ASILE AND AISLE ACCESSWAYS SERVING AS A PORTION OF THE EXIT ACCESS IN THE MEANS OF EGRESS SHALL COMPLY WITH CFC SECTION 1018. THE MINIMUM WIDTH OR REQUIRED CAPACITY OF AISLES SHALL BE UNOBSTRUCTED.

NOTES:

- DOUBLE STRIPING OF STALLS SHALL BE PER ZONING CODE SECTION 12.21A5, CHART NO. 5.
- USEBLE ENCLOSED SPACE UNDER ENCLOSED ENTRANCE STEWERS SHALL BE PROVIDED WITH A 2 HR FIRE-RESISTANCE RATED CONSTRUCTION OR THE SAME FIRE RATING OF THE STAIRS ENCLOSURE WHICHEVER IS GREATER. (1009.6.3)
- BASE CABINETS DIRECTLY UNDER THE KITCHEN SINK COUNTER AREA, INCLUDING TOEBOARD AND SHELVING, SHALL BE REMOVABLE WITHOUT THE USE OF TOOLS OR KNOWLEDGE IN ORDER TO PROVIDE SPACES FOR A WHEELCHAIR. THE COUNTER AREA SHALL BE EXTENDED TO THE WALL TYP. (113A.4)
- KITCHEN COUNTER HEIGHT SHALL BE MAX. 36" NAD MATERIAL IS GRANITE STONE. 4" SWING OF THE DOOR AT THE FIRST 9 FEET, MEASURED FROM GRADE, AT EXTERIOR WALLS AND DOORS.
- PROVIDE ANTI-GRAFFITI FINISH AT THE FIRST 9 FEET, MEASURED FROM GRADE, AT EXTERIOR CORRIDORS OF GROUP A & R-2-1 (C-1013.7)
- ALL EXTERIOR WALKWAYS INCLUDING BALCONY AND DECK SURFACES TO SLOPE A MAXIMUM OF 10%.
- WHERE DOORS ARE NOT DIMENSIONED DOORS SHALL BE INSTALLED WITH HINGE SIDE AT 4" FROM ADJACENT FRAMED WALL.
- PROVIDE ANTI-GRAFFITI FINISH AT THE FIRST 9 FEET, MEASURED FROM GRADE, AT EXTERIOR WALLS AND DOORS.
- ADMONITION: EX SIGNS SHALL BE PROVIDED IN ALL INTERIOR CORRIDORS OF GROUP A & R-2-1 (C-1013.7)
- NONABSORBENT INTERIOR FLOOR AND WALL FINISHES SHALL BE USED WITHIN AT LEAST 2 FEET AROUND AND PERPENDICULAR TO EXTERIOR ENTRIES AND/OR OPENINGS SUBJECT TO FOOT TRAFFIC.
- WALLS REQUIRED BY NFPA 13 SECTION 8.15.1, PROVIDE FIRE SPRINKLER AT ALL VERTICAL SPACES THAT ARE CONSTRUCTED OF COMBUSTIBLE SPACES, WHERE ALTERNATE METHOD ARE ALLOWED, ONE OF THE FOLLOWING OPTIONS MAYBE USED UNLESS NOTED OTHERWISE:
 - A. NFPA 13 SECTION 8.15.1.2.7 FILL CONCEALED SPACE ENTIRELY WITH NONCOMBUSTIBLE INSULATION.
 - B. NFPA 13 SECTION 8.15.1.2.7 FINISH THE CONCEALED SPACE WITH TYPE 'X' GYP BD. AND NFPA 13 SECTION 8.15.1.2.8.2 COMBUSTIBLE SOFTS, EAVES, OVERHANG AND DECORATIVE ELEMENTS SHALL BE DRAFT STOPPED, VOLUME NOT TO EXCEED 160 CUBIC FT. OR SECTION 8.15.1.2.14 VERTICAL PIPE CHASES UNDER 10 SF WHERE PROVIDED IN MULTIFLOOR BUILDINGS WHERE THE CHASES ARE FIRESTOPPED AT EACH FLOOR USING METAL FIRESTOPPING, THE FLOOR CONSTRUCTION, AND WHERE SUCH FIRE STOP SHALL CONTAIN NO SOURCE OF IGNITION.
 - C. NFPA 13 SECTION 8.15.1.2.18.2 COMBUSTIBLE SOFTS, EAVES, OVERHANG AND DECORATIVE ELEMENTS SHALL BE DRAFT STOPPED, VOLUME NOT TO EXCEED 160 CUBIC FT. OR SECTION 8.15.1.2.14 VERTICAL PIPE CHASES UNDER 10 SF WHERE PROVIDED IN MULTIFLOOR BUILDINGS WHERE THE CHASES ARE FIRESTOPPED AT EACH FLOOR USING METAL FIRESTOPPING, THE FLOOR CONSTRUCTION, AND WHERE SUCH FIRE STOP SHALL CONTAIN NO SOURCE OF IGNITION.
- ASILE AND AISLE ACCESSWAYS SERVING AS A PORTION OF THE EXIT ACCESS IN THE MEANS OF EGRESS SHALL COMPLY WITH CFC SECTION 1018. THE MINIMUM WIDTH OR REQUIRED CAPACITY OF AISLES SHALL BE UNOBSTRUCTED.

GREEN BUILDING CODE NOTES

- A SEPARATE ELECTRICAL PLAN CHECK IS REQUIRED TO VERIFY THE RACEWAY METHOD(S), WIRING SCHEMATIC(S) AND ELECTRICAL CONNECTIONS FOR THE ELECTRICAL CHARGING SYSTEM. THE ELECTRICAL SYSTEM SHALL HAVE SUFFICIENT CAPACITY TO SIMULTANEOUSLY CHARGE ALL ELECTRIC VEHICLES AT THEIR FULL RATED AMPERAGE.
- THE SERVICE PANEL OR SUBPANEL(S) SHALL HAVE SUFFICIENT CAPACITY TO ACCOMMODATE THE REQUIRED NUMBER OF DEDICATED 40 AMPERE MINIMUM BRANCH CIRCUITS FOR THE PLACEMENT AND INSTALLATION OF THE EVSE.
- THE ELECTRICAL SYSTEM SHALL HAVE SUFFICIENT CAPACITY TO SIMULTANEOUSLY CHARGE ALL DESIGNATED EV SPACES AT THE FULL RATED AMPERAGE OF THE EVSE. PLAN DESIGN SHALL BE BASED UPON A 40-AMPERE MINIMUM BRANCH CIRCUIT. A SEPARATE ELECTRICAL PERMIT IS REQUIRED.
- 4" SERVICE PANEL OR SUBPANEL CIRCUIT DIRECTORY SHALL IDENTIFY THE OVERCURRENT PROTECTIVE DEVICE SPACES RESERVED FOR FUTURE EV CHARGING PURPOSES AS EV CAPABLE IN ACCORDANCE WITH THE LOS ANGELES ELECTRICAL CODE. THE RACEWAY TERMINATION SHALL BE PERMANENTLY AND VISIBLY MARKED AS "EV CAPABLE".
- EXHAUST FAN SHALL BE ENERGY STAR COMPLIANT AND BE DUCTED TO TERMINATE TO THE OUTSIDE OF THE BUILDING.
- EXHAUST FAN NOT FUNCTIONING AS A COMPONENT OF A WHOLE HOUSE VENTILATION SYSTEM, MUST BE CONTROLLED BY A HUMIDITY CONTROL DEVICE. THE EXHAUST FAN AND VENTILATION SYSTEM, WHICH CONTAINS 50 UNITS OR LESS, SHALL INSTALL A SEPARATE METER OR SUBMETER WITHIN COMMON AREA SAND WITHIN EACH INDIVIDUAL DWELLING UNIT.
- THE ELECTRICAL SYSTEM SHALL HAVE SUFFICIENT CAPACITY TO SIMULTANEOUSLY CHARGE ALL DESIGNATED EV SPACE AT THE FULL RATED AMPERAGE OF THE EVSE. PLAN DESIGN SHALL BE BASED UPON A 40-AMPERE MINIMUM BRANCH CIRCUIT. A SEPARATE ELECTRICAL PERMIT IS REQUIRED.
- THE SERVICE PANEL OR SUBPANEL CIRCUIT DIRECTORY SHALL IDENTIFY THE OVERCURRENT PROTECTIVE DEVICE SPACES RESERVED FOR FUTURE EV CHARGING PURPOSES AS EV CAPABLE IN ACCORDANCE WITH THE LOS ANGELES ELECTRICAL CODE (4.106.4.2, 4.106.4.3).
- A COPY OF THE CONSTRUCTION DOCUMENTS OR A COMPARABLE DOCUMENT INDICATING THE INFORMATION FROM ENERGY CODE SECTION 110.10(d) THROUGH 110.10(c) SHALL BE PROVIDED TO THE OCCUPANT. (ENERGY CODE 8110.10(d))

GARAGE NOTES

- STRIPING AT ACCESSIBLE PARKING STALLS, ACCESSIBLE PARKING AISLES AND ACCESSIBLE CROSSWALKS SHALL BE 3-INCH WIDE, BLUE PAINTED TRAFFIC GRADE STRIPING.
- PROVIDE 4" WIDE WHITE PAINTED STRIPING ADJACENT TO ALL DRIVE AISLES EXCEPT AT PARKING STALLS.
- PROVIDE CURB GUARDS AT ALL VERTICAL PLUMBING OR FIRE SPRINKLER LINES LOCATED ADJACENT TO COLUMN OR WALLS AT HEAD LEVEL OF PARKING AND FIRE SPRINKLER DRAWINGS FOR LOCATIONS.
- ALL GARAGE AREAS TO HAVE A MINIMUM 7'-0" HEAD CLEARANCE HEIGHT.
- FOR REQUIRED DRIVE AISLE TURNING RADIUS CLEARANCES, SEE DIAGRAM PROVIDED.
- THE SURFACE SLOPE FOR EV SPACES SHALL NOT EXCEED 2.083% IN ANY DIRECTION.
- 7'-0" MIN. CLEAR HEIGHT IS REQUIRED TO ANY OBSTRUCTION AT ACCESSIBLE PARKING STALLS AND ACCESS AISLES LEADING TO ACCESSIBLE PARKING STALLS.
- 7'-0" MIN. CLEAR HEIGHT IS REQUIRED TO ANY OBSTRUCTION AT ALL PARKING AREAS, UNLESS NOTED OTHERWISE.
- PARKING AREAS AS ENCLOSED PARKING GARAGE, PROVIDE MECHANICAL VENTILATION PER CALIFORNIA MECHANICAL CODE.

NOTE

- ALL FIRE PARTITION WALLS (LABC 708) SHALL BE 1 HOUR RATED STC50.
- WALLS (FIRE BARRIERS 707.3.1) IN SHAFTS AS ELEVATOR, STAIRS, ETC.
- FIRE PARTITION CORRIDORS SHALL BE 1 HOUR RATED.
- ALL BEARING WALLS SHALL BE 1 HOUR RATED.
- THE FLOOR/CEILING ASSEMBLIES SHALL BE 1 HOUR RATED STC50.
- NON-COMBUSTIBLE DRAFT STOP SHALL BE PROVIDED.
- Recycling chutes shall be clearly marked "RECYCLING ONLY" at every point of entry.

NOMINAL WALL THICKNESS / STUD SIZE
(2x1-1/2" STUD FOR METAL FRAMED TYPES)
(4x 3-5/8" STUD FOR METAL FRAMED TYPES)
(4x 2X4 STUD FOR WOOD FRAMED TYPES)
(6x 2X6 STUD FOR WOOD FRAMED TYPES)

MODEL4400R STANDARD RECESSED KEY BOX FOR LOW-RISE BUILDING
TO PROVIDE SIGN THAT INDICATES BICYCLE PARKING LOCATION
PER SECTION 12.21A.16(e)(4)

R TO PROVIDE 100 SQUARE FEET FOR MULTI-FAMILY RESIDENTIAL
USES OF 51 OR MORE DWELLING UNITS

EV ELECTRICAL VEHICLE SUPPLY WIRING FOR FUTURE, REFER TO SHEET
N-1(GB)

THE PANEL OR SUBPANEL SHALL HAVE SUFFICIENT CAPACITY TO
SUPPLY AT LEAST LEVEL 2 EVSE.

THE ELECTRICAL SYSTEM SHALL HAVE SUFFICIENT CAPACITY TO
SIMULTANEOUSLY CHARGE ALL DESIGNED EV SPACES AT FULL RATED
AMPERAGE BASED ON LEVEL 2 EVSE.

A SEPARATE ELECTRICAL PERMIT IS REQUIRED.

A LABEL "EV CAPABLE SHALL BE POSTED IN A CONSPICUOUS PLACE AT
HTE SERVICE PANEL OR SUBPANEL AND EV CHARGING SPACE (4.106.4.2)

1009.8 TWP-WAY COMMUNICATION
A TWO-WAY COMMUNICATION SYSTEM COMPLYING WITH SECTIONS
1009.8.1

AND 1009.8.2 SHALL BE PROVIDED AT THE LANDING SERVING EACH
ELEVATOR OR BANK OF ELEVATORS ON EACH ACCESSIBLE FLOOR
THAT IS ONE OR MORE STORIES ABOVE OR BELOW THE LEVEL OF EXIT
DISCHARGE.

PROVIDE SLIP RESISTANT SURFACES ALONG MEANS OF EGGS
PATH OF TRAVEL PER CODE NO. 1003.4

SCALE :

DRAWN :

DATE : December 25

JOB NUMBER :

SHEET

A2.2

LADBS APPROVAL STAMP

NOTICE
THE DESIGNS SHOWN AND DESCRIBED
HEREIN, INCLUDING ALL TECHNICAL
DRAWINGS, GRAPHICS, AND MODELS
THEREOF, ARE PROPRIETARY AND SHALL NOT
BE COPIED, REPRODUCED, REPROCESSED
COMMERCIALIZED IN WHOLE OR IN
PART WITHOUT THE WRITTEN PERMISSION OF
BEVERLY DESIGN.
ALL THESE DRAWINGS HAVE BEEN
PREPARED TO DESCRIBE NEW WORK ONLY
AND DO NOT REPRESENT AS-BUILT OR
ACCURATE EXISTING CONDITIONS. THE
DESIGNER DOES NOT WARRANT IN ANY WAY
THE ACCURACY OF THE INFORMATION AND
SHALL NOT BE RESPONSIBLE FOR
DISCREPANCIES BETWEEN THIS DOCUMENT
AND EXISTING CONDITIONS. THESE PLANS ARE
THE PROPERTY OF BEVERLY DESIGN.
THESE PLANS ARE
AVAILABLE FOR LIMITED REVIEW AND
EVALUATION AS INSTRUMENTS OF SERVICE
BY THE CLIENT, CONSULTANTS,
CONTRACTORS, AGENTS,
VENDORS AND OTHER PERSONNEL ONLY IN
ACCORDANCE WITH THIS NOTICE. DO NOT
SCALE OFF THESE DRAWINGS. ALL RIGHTS
RESERVED COPYRIGHT, BEVERLY DESIGN

OWNER :

PROJECT :

8688 W Pico Blvd,
Los Angeles, CA 90035

SHEET TITLE:


FIFTH FLOOR
PLAN

REVISION:
NO. DATE BY

SCALE :
DRAWN :
DATE : December 25
JOB NUMBER :

SHEET

A2.4

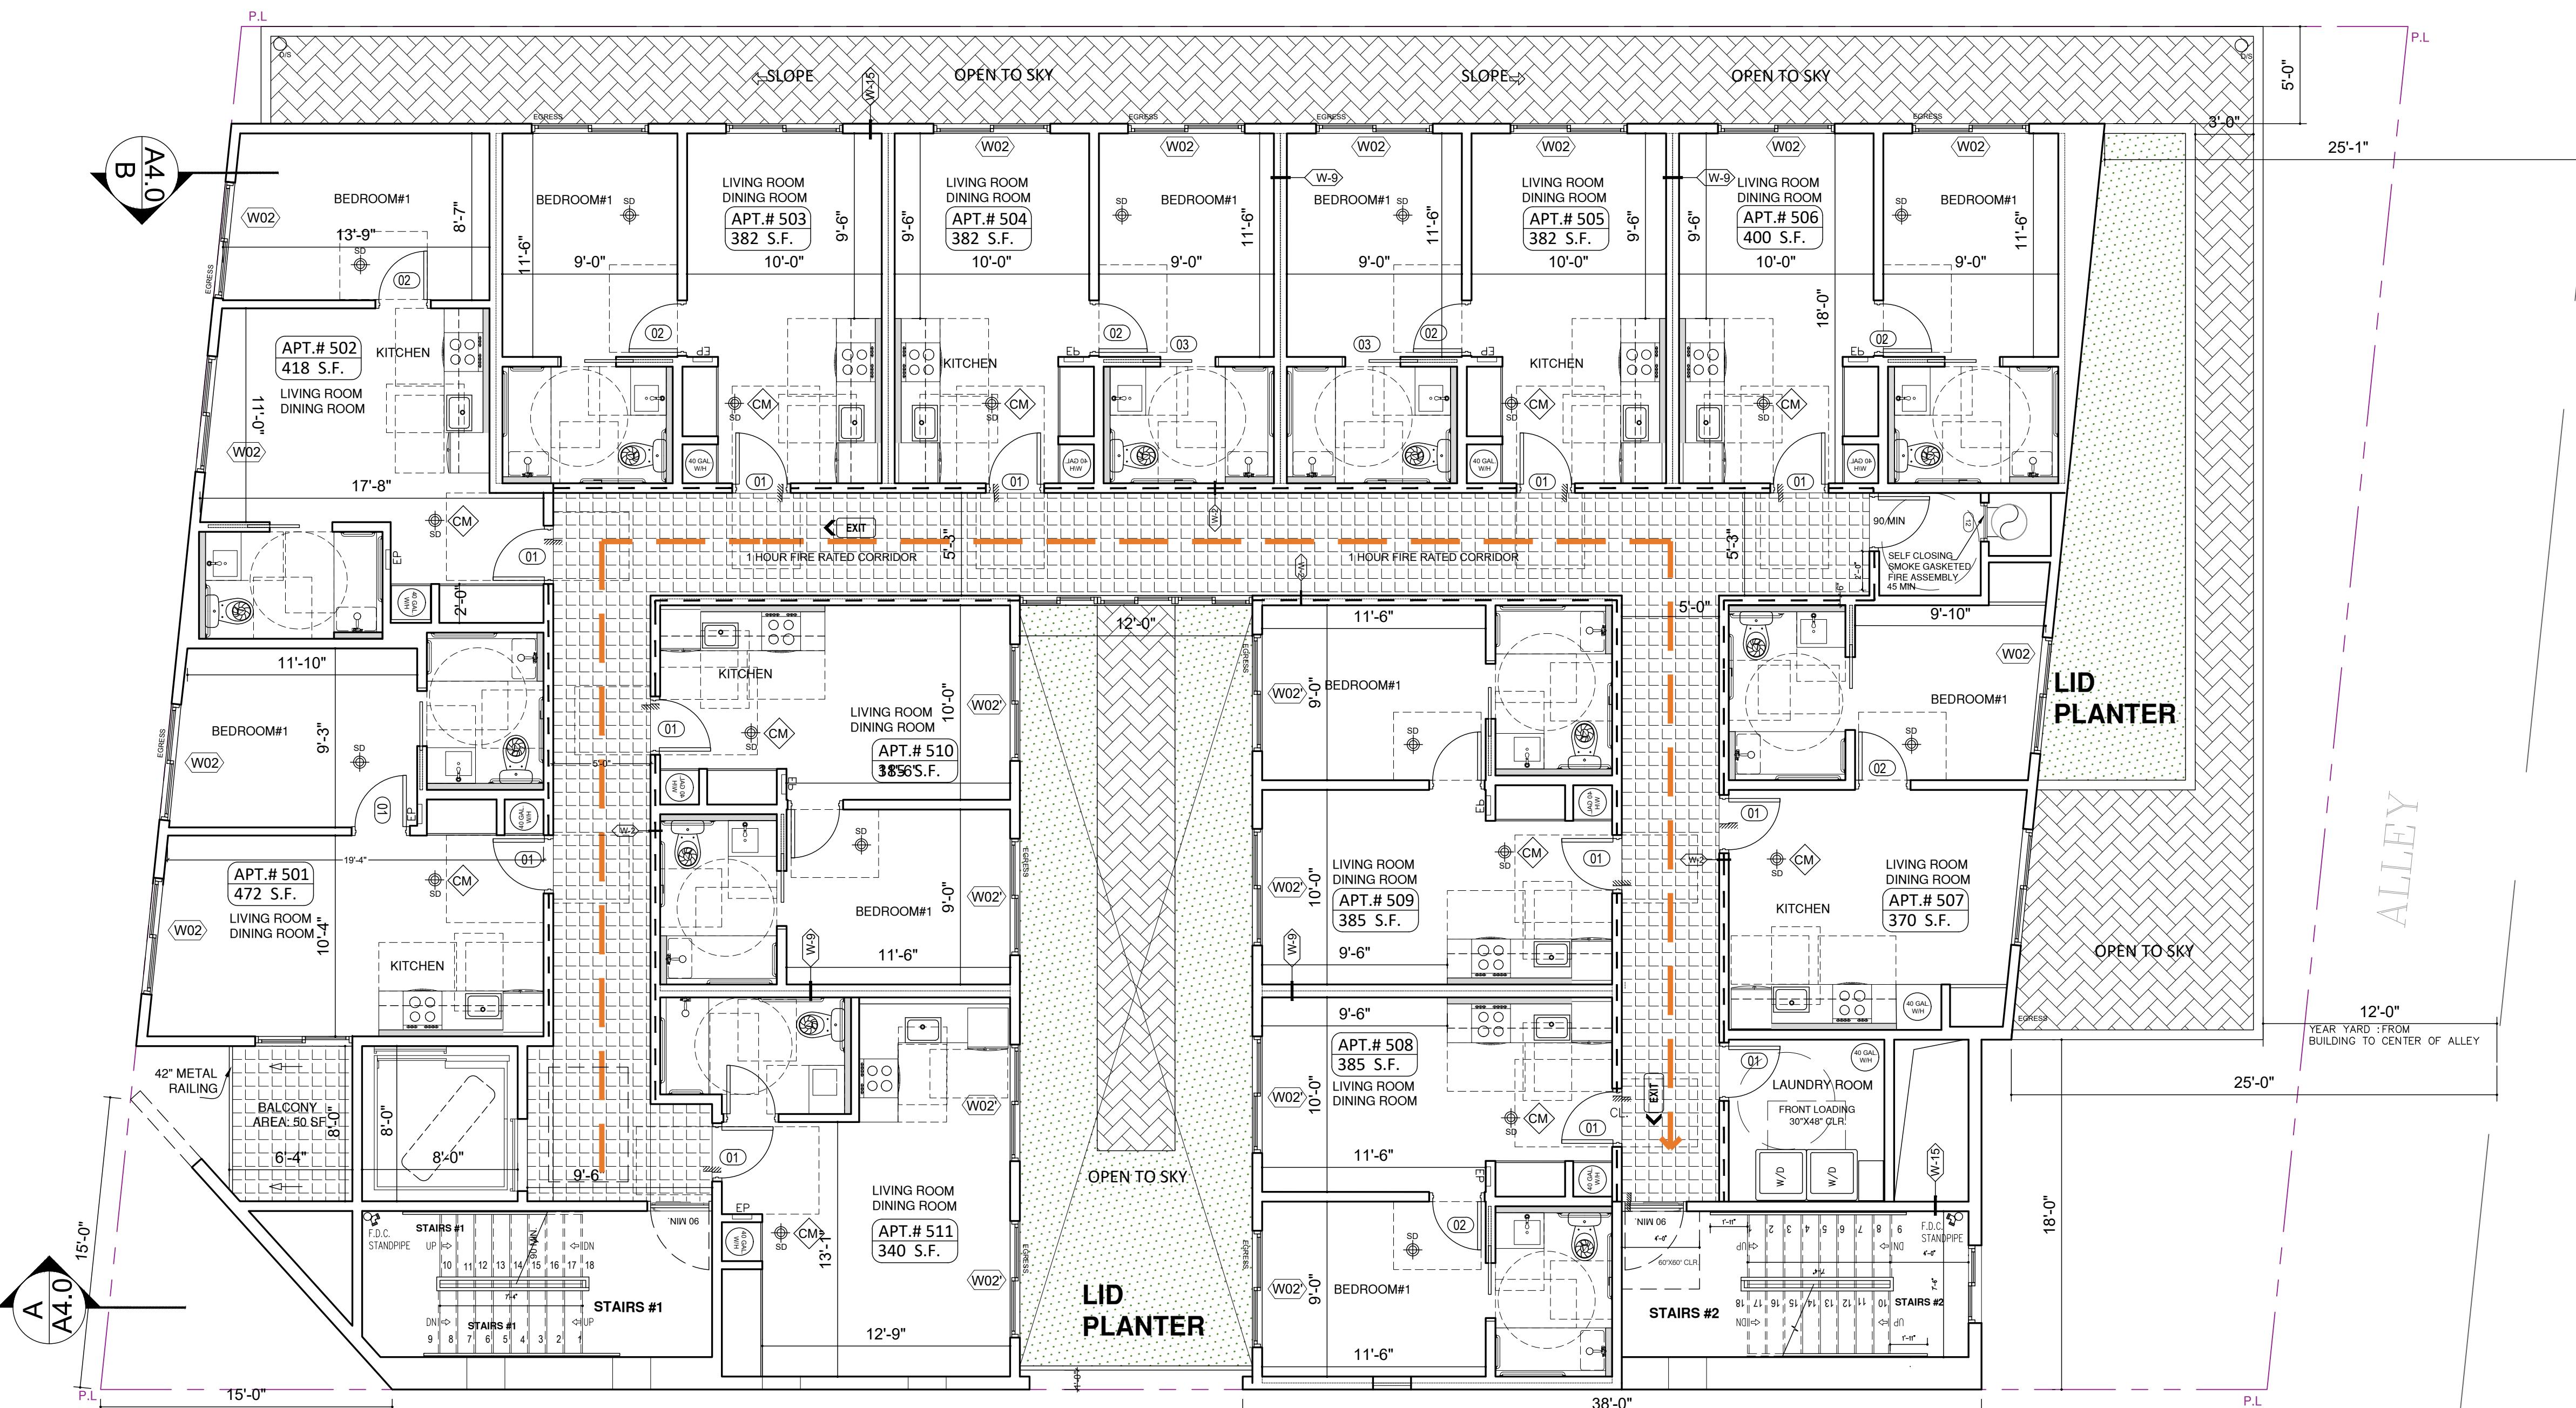

FLOOR PLAN NOTES

- REFER TO ENLARGED UNIT, STAIR AND ELEVATOR CORE PLANS FOR ADDITIONAL INFORMATION.
- ALL DIMENSIONS ARE TO FACE OF MASONRY, CONCRETE, OR STUDS, U.N.O.
- ALL WALLS TO TERMINATE TO UNDERSIDE OF FLOOR/CEILING/ROOF ASSEMBLY ABOVE U.N.O.
- ALL WOOD/METAL INTERIOR WALLS TO RECEIVE A MINIMUM OF (1) LAYER OF 5/8" GYPSUM WALL BOARD, EACH SIDE, U.N.O.
- ALIGN INTERIOR FACE OF SHAFT WALL FINISH WITH SLAB EDGE OF SHAFT OPENING TYPE.
- ALL EXTERIOR WALKWAYS INCLUDING BALCONY AND DECK SURFACES TO SLOPE A MAXIMUM OF 2%.
- WHERE DOORS ARE NOT DIMENSIONED DOORS SHALL BE INSTALLED WITH HINGE SIDE AT 4" FROM ADJACENT FRAMED WALL.
- PROVIDE A 1/4" THICK FINISH AT THE FIRST 9 FEET, MEASURED FROM GRADE, AT EXTERIOR WALLS AND DOORS.
- ADDITIONAL LOW-LEVEL EXIT SIGNS SHALL BE PROVIDED IN ALL INTERIOR CORRIDORS OF GROUP A, E, I, R-2-1 (CBC 1013.7)
- NONABSORBENT INTERIOR FLOOR AND WALL FINISHES SHALL BE USED, WITHIN AT LEAST 2 FEET AROUND AND PERPENDICULAR TO EXTERIOR ENTRIES AND/OR OPENINGS SUBJECT TO NFPA 13.
- WHERE REQUIRED BY NFPA 13 SECTION 8.15.1, PROVIDE FIRE SPRINKLER AT ALL VOID/CONCEALED SPACES THAT ARE CONSTRUCTED OF COMBUSTIBLE SPACES, WHERE ALTERNATE METHOD ARE ALLOWED, ONE OF THE FOLLOWING OPTIONS MAYBE USED UNLESS NOTED OTHERWISE:
 - A. NFPA 13 SECTION 8.15.1.2.7 FILL CONCEALED SPACE ENTIRELY WITH NONCOMBUSTIBLE INSULATION.
 - B. NFPA 13 SECTION 8.15.1.2.10 FINISH THE CONCEALED SPACE WITH TYPE X' GYP BD. AND NO ACCESS IS PROVIDED TO THE SPACE.
 - C. NFPA 13 SECTION 8.15.1.2.12 COMBUSTIBLE SOFFITS, EAVES, OVERHANG AND DECORATIVE ELEMENTS SHALL BE DRAFT STOPPED, VOLUME NOT TO EXCEED 160 CFS, OR 100 CFS FOR 8.15.1.2.14 VERTICAL PIPE CHASES UNDER 10' WHERE PROVIDED. MULTIPLE VERTICAL PIPE CHASES WHERE THE DRAFT IS NOT STOPPED AT EACH FLOOR USING MATERIALS EQUIVALENT TO THE FLOOR CONSTRUCTION, AND WHERE SUCH PIPE CHASE SHALL CONTAIN NO SOURCES OF IGNITION.
- AILLE AND AILSE ACCESSWAYS SERVING AS A PORTION OF THE EXIT ACCESS IN THE MEANS OF EGRESS SYSTEM SHALL COMPLY WITH CBC SECTION 1018. THE MINIMUM WIDTH OR REQUIRED CAPACITY OF AISLES SHALL BE UNOBSTRUCTED.

NOTES:

- DOUBLE STRIPING OF STALLS SHALL BE PER ZONING CODE SECTION 12.21A5, CHART NO. 5."
- USEBLI ENCLOSED SPACE UNDER ENCLOSED OR UNENCLOSED STEIRWAYS SHALL BE PROVIDED WITH A 2 HR FIRE-RESISTANCE RATED CONSTRUCTION AND A 2 HR FIRE-RATING OF THE STAIRS ENCLOSURE WHICH EVER IS GREATER. (1009.8.3)
- BASE CABINETS DIRECTLY UNDER THE KITCHEN SINK COUNTER AREA, INCLUDING TOEBOARD AND SHELVING, SHALL BE REMOVABLE WITHOUT THE USE OF SPECIALIZED TOOLS OR KNOWLEDGE IN ORDER TO PROVIDE KNEE AND TOE SPACE FOR A WHEELCHAIR. THE FONOSH FLOOR BENEATH THE KITCHEN SINK COUNTER AREA SHALL BE EXTENDED TO THE WALL TYP. (1134.3)
- INTERIOR HEIGHT SHALL BE MAX. 36" NAD MATERIAL IS GRANITE STONE. OPTION 2, ONLY ONE BATHROOM WITHIN THE DWELLING UNIT SHALL BE DESIGNED TO COMPLY WITH THE FOLLOWING:

 - 1. TOILET, BATHING AND SHOWER FACILITIES SHALL COMPLY WITH SECTION 1134.5.
 - 2. SHOWER SHALL COMPLY WITH SECTION 1134.5.
 - 3. SHOWER SHALL COMPLY WITH SECTION 1134A.6.
 - 4. WATER CLOSET SHALL COMPLY WITH SECTION 1134A.7.
 - 5. LAVATORIES, VANITIES, MIRRORS AND TOWEL FIXTURES SHALL COMPLY WITH SECTION 1134A.8.
 - 6. WHERE BOTH A SHOWER AND TUB ARE PROVIDED IN THE BATHROOM, AT LEAST ONE SHOWER AND TUB ACCESSIBLE.
 - 7. WHEN TWO OR MORE AVATATES ARE PROVIDED AT LEAST ONE SHALL BE MADE ACCESSIBLE AND COMPLY WITH SECTION 1134A.8.
 - 8. BATHROOM SHALL PROVIDED WITH AN ACCESSIBLE ROUTE INTO AND THROUGH THE BATHROOM.
 - 9. IF A DOOR IS PROVIDED, IT SHALL COMPLY WITH THE REQUIREMENTS OF SECTION 1134.5.
 - 10. A MIN. 18-INCH (457MM) CLEAR MANEUVERING SPACE SHALL BE PROVIDED ON THE SIDE OF THE BATHROOM NOT DRAFT STOPPED. THE CLEAR MANEUVERING SPACE SHALL BE PROVIDED IN ACCORDANCE WITH SECTION 1142A.1. SWITCHES, OUTLETS AND CONDUITS SHALL COMPLY WITH SECTION 1142A.12. REINFORCED BARS AROUND THE TOILET, TUB AND SHOWERS SHALL COMPLY WITH SECTION 1134A.5 FOR BATHTUBS, 1134A.6 FOR SHOWERS AND 1134A.7 FOR WATER CLOSET. GRAB BAR SHALL COMPLY WITH SECTION 1127A.4 AND 1127.2.2. ITEM 4.

GREEN BUILDING CODE NOTES

- A SEPARATE ELECTRICAL PLAN CHECK IS REQUIRED TO VERIFY THE RACEWAY (METHOD) WIRING SCHEMATICS AND ELECTRICAL CALCULATIONS FOR THE ELECTRICAL CHARGING SYSTEM. THE ELECTRICAL SYSTEM SHALL HAVE SUFFICIENT CAPACITY TO SIMULTANEOUSLY CHARGE ALL ELECTRIC VEHICLES AT THEIR FULL RATED AMPERAGE.
- THE SERVICE PANEL OR SUBPANEL(S) SHALL HAVE SUFFICIENT CAPACITY TO ACCOMMODATE THE REQUIRED NUMBER OF DEDICATED 40 AMPERE MINIMUM BRANCH CIRCUITS FOR THE FUTURE INSTALLATION OF THE EVSE.
- THE ELECTRICAL SYSTEM SHALL HAVE SUFFICIENT CAPACITY TO SIMULTANEOUSLY CHARGE ALL DESIGNATED EV.
- EXHAUST FAN SHALL BE ENERGY STAR COMPLIANT AND BE DUCTED TO SPACES AT THE FULL RATED AMPERAGE OF THE EVSE. PLAN DESIGN SHALL BE BASED UPON 40 AMPERE MINIMUM BRANCH CIRCUIT. A SEPARATE ELECTRICAL PERMIT IS REQUIRED.
- THE SERVICE PANEL OR SUBPANEL CIRCUIT DIRECTORY SHALL IDENTIFY THE OVERCURRENT PROTECTIVE DEVICE SPACES RESERVED FOR FUTURE EV CHARGING PURPOSES AS EV CAPABLE IN ACCORDANCE WITH THE LOS ANGELES ELECTRICAL CODE. THE RACEWAY TERMINATION SHALL BE PERMANENTLY AND VISIBLELY MARKED AS "EV CAPABLE".
- EXHAUST FAN SHALL BE ENERGY STAR COMPLIANT AND BE DUCTED TO SPACES AT THE FULL RATED AMPERAGE OF THE EVSE.
- EXHAUST FAN INCORPORATED AS A COMPONENT OF A WHOLE HOME VENTILATION SYSTEM, MUST BE CONTROLLED BY A HUMIDITY CONTROL.
- MULTI-FAMILY DWELLINGS NOT EXCEEDING THREE STORIES AND CONTAINING 50 UNITS OR LESS SHALL INSTALL A SEPARATE METER OR SUBMETER WITHIN COMMON AREA SAND WITH EACH INDIVIDUAL DWELLING UNIT.
- THE ELECTRICAL SYSTEM SHALL HAVE SUFFICIENT CAPACITY TO SIMULTANEOUSLY CHARGE ALL DESIGNATED EV SPACE AT THE FULL RATED AMPERAGE. THE SERVICE PANEL OR SUBPANEL CIRCUIT DIRECTORY SHALL REQUIRE A SEPARATE ELECTRICAL PERMIT & IS REQUIRED.
- THE SERVICE PANEL OR SUBPANEL CIRCUIT DIRECTORY SHALL IDENTIFY THE OVERCURRENT PROTECTIVE DEVICE SPACES RESERVED FOR FUTURE EV CHARGING PURPOSES AS EV CAPABLE IN ACCORDANCE WITH THE LOS ANGELES ELECTRICAL CODE. (4.106.4.2, 4.106.4.3)
- SWITCHES, OUTLETS AND CONDUITS SHALL COMPLY WITH SECTION 1142A.1. SWITCHES, OUTLETS AND CONDUITS SHALL COMPLY WITH SECTION 1142A.12. REINFORCED BARS AROUND THE TOILET, TUB AND SHOWERS SHALL COMPLY WITH SECTION 1134A.5 FOR BATHTUBS, 1134A.6 FOR SHOWERS AND 1134A.7 FOR WATER CLOSET. GRAB BAR SHALL COMPLY WITH SECTION 1127A.4 AND 1127.2.2. ITEM 4.

GARAGE NOTES

- STRIPING AT ACCESSIBLE PARKING STALLS, ACCESSIBLE PARKING AISLES AND ACCESSIBLE CROSSWALKS SHALL BE 3-INCH WIDE, BLUE PAINTED TRAFFIC GRADE STRIPING.
- 2" P.D. 4" WIDE WHITE PAINTED STRIPING ADJACENT TO ALL DRIVE AISLES EXCEPT AT PARKING STALLS.
- PROVIDE PIPE GUARDS AT ALL VERTICAL PLUMBING OR FIRE SPRINKLER LINES LOCATED ADJACENT TO COLUMN OR WALLS AT HEAD END OF PARKING. REFER TO PLUMBING AND FIRE SPRINKLER DRAWINGS FOR LOCATIONS.
4. ALIGN GARAGE AISLES TO HAVE A MINIMUM 8' HEAD CLEARANCE HEIGHT.
5. FOR REAR LOAD DOORS, PROVIDE 8' CLEAR RADIUS CLEARANCES. SEE DIAGRAM PROVIDED.
6. THE SURFACE SLOPE FOR EV SPACES SHALL NOT EXCEED 2.03% IN ANY DIRECTION.
7. NOT USED.
8. 8' 2" MIN. CLEAR HEIGHT IS REQUIRED TO ANY OBSTRUCTION AT ACCESSIBLE PARKING STALLS.
9. 7' 6" CLEAR HEIGHT IS REQUIRED TO ANY OBSTRUCTION AT ALL PARKING AREAS, UNLESS NOTED OTHERWISE.
10. PARKING AREAS AS ENCLOSED PARKING GARAGE, PROVIDE MECHANICAL VENTILATION PER CALIFORNIA MECHANICAL CODE.

NOTE

- ALL FIRE PARTITION WALLS (LABC 708) SHALL BE 1 HOUR RATED STC50
- WALLS (FIRE BARRIERS 707.3.1) IN SHAFTS AS ELEVATOR, STAIRS, ETC.
- FIRE PARTITION CORRIDORS SHALL BE 1 HOUR RATED
- ALL BEARING WALLS SHALL BE 1 HOUR RATED
- THE FLOOR/CEILING ASSEMBLIES SHALL BE 1 HOUR RATED STC50.
- NON-COMBUSTIBLE DRAFT STOES SHALL BE PROVIDED.
- Recycling chutes shall be clearly marked "RECYCLING ONLY" at every point of entry.

NOMINAL WALL THICKNESS / STUD SIZE
(2= 2-1/2" STUDS FOR METAL FRAMED TYPES)
(4= 3-5/8" STUD FOR METAL FRAMED TYPES)
(4= 2X4 STUD FOR WOOD FRAMED TYPES)
(6= 2X6 STUD FOR WOOD FRAMED TYPES)

MODEL 4400R STANDARD RECESSED KEY BOX FOR LOW-RISE BUILDING
TO PROVIDE SIGN THAT INDICATES BICYCLE PARKING LOCATION
PER SECTION 12.21A.16(e4)

BP TO PROVIDE 100 SQUARE FEET FOR MULTI-FAMILY RESIDENTIAL USES OF 51 OR MORE DWELLING UNITS

R ELECTRICAL VEHICLE SUPPLY WIRING FOR FUTURE, REFER TO SHEET N-1(GB)

- * THE PANEL OR SUBPANEL SHALL HAVE SUFFICIENT CAPACITY TO SUPPORT AT LEAST LEVEL 2 EVSE.
- * THE ELECTRICAL SYSTEM SHALL HAVE SUFFICIENT CAPACITY TO SIMULTANEOUSLY CHARGE ALL DESIGNED EV SPACES AT FULL RATED AMPERAGE BASED ON LEVEL 2 EVSE. A SEPARATE ELECTRICAL PERMIT IS REQUIRED.
- * A LABEL "EV CAPABLE" SHALL BE POSTED IN A CONSPICUOUS PLACE AT THE SERVICE PANEL OR SUBPANEL AND EV CHARGING SPACE (4.106.4.2)

EV

TP 100' TWO-WAY COMMUNICATION SYSTEM COMPLYING WITH SECTION 4.109.8.1

AND 1009.8.2 SHALL BE PROVIDED AT THE LANDING SERVING EACH ELEVATOR OR BLDG OF ELEVATORS ON EACH ACCESSIBLE FLOOR THAT IS ONE OR MORE STORIES ABOVE OR BELOW THE LEVEL OF EXIT DISCHARGE.

SR PROVIDE SLIP RESISTANT SURFACES ALONG MEANS OF EGGS PATH OF TRAVEL PER CODE NO. 1003.4

LADBS APPROVAL STAMP

NOTICE
THE DESIGNS SHOWN AND DESCRIBED
HEREIN, INCLUDING ALL TECHNICAL
DRAWINGS, GRAPHICS, AND MODELS
THEREOF, ARE PROPRIETARY AND SHALL NOT
BE COPIED, REPRODUCED, REPROCESSED
COMMERCIALIZED IN WHOLE OR IN
PART WITHOUT THE WRITTEN PERMISSION OF
BEVERLY DESIGN.
ALL THESE DOCUMENTS HAVE BEEN
PREPARED TO DESCRIBE NEW WORK ONLY
AND DO NOT REPRESENT AS-BUILT OR
ACCURATE EXISTING CONDITIONS. THE
DESIGNER DOES NOT WARRANT IN ANY WAY
THE ACCURACY OF THE INFORMATION AND
SHALL NOT BE RESPONSIBLE FOR
DISCREPANCIES BETWEEN THIS DOCUMENT
AND EXISTING CONDITIONS. THESE PLANS ARE
THE PROPERTY OF BEVERLY DESIGN.
THESE PLANS ARE
NOT AVAILABLE FOR LIMITED REVIEW AND
EVALUATION AS INSTRUMENTS OF SERVICE
BY THE CLIENT, CONSULTANTS,
CONTRACTORS, AGENTS, VENDORS AND
OFFICE PERSONNEL ONLY IN
ACCORDANCE WITH THIS NOTICE. DO NOT
SCALE OFF THESE DRAWINGS. ALL RIGHTS
RESERVED COPYRIGHT, BEVERLY DESIGN

OWNER :

PROJECT :

8688 W Pico Blvd,
Los Angeles, CA 90035

SHEET TITLE:


SIXTH FLOOR
PLAN

REVISION:
NO. DATE BY

SCALE :
DRAWN :
DATE : December 25
JOB NUMBER :

SHEET

A2.5

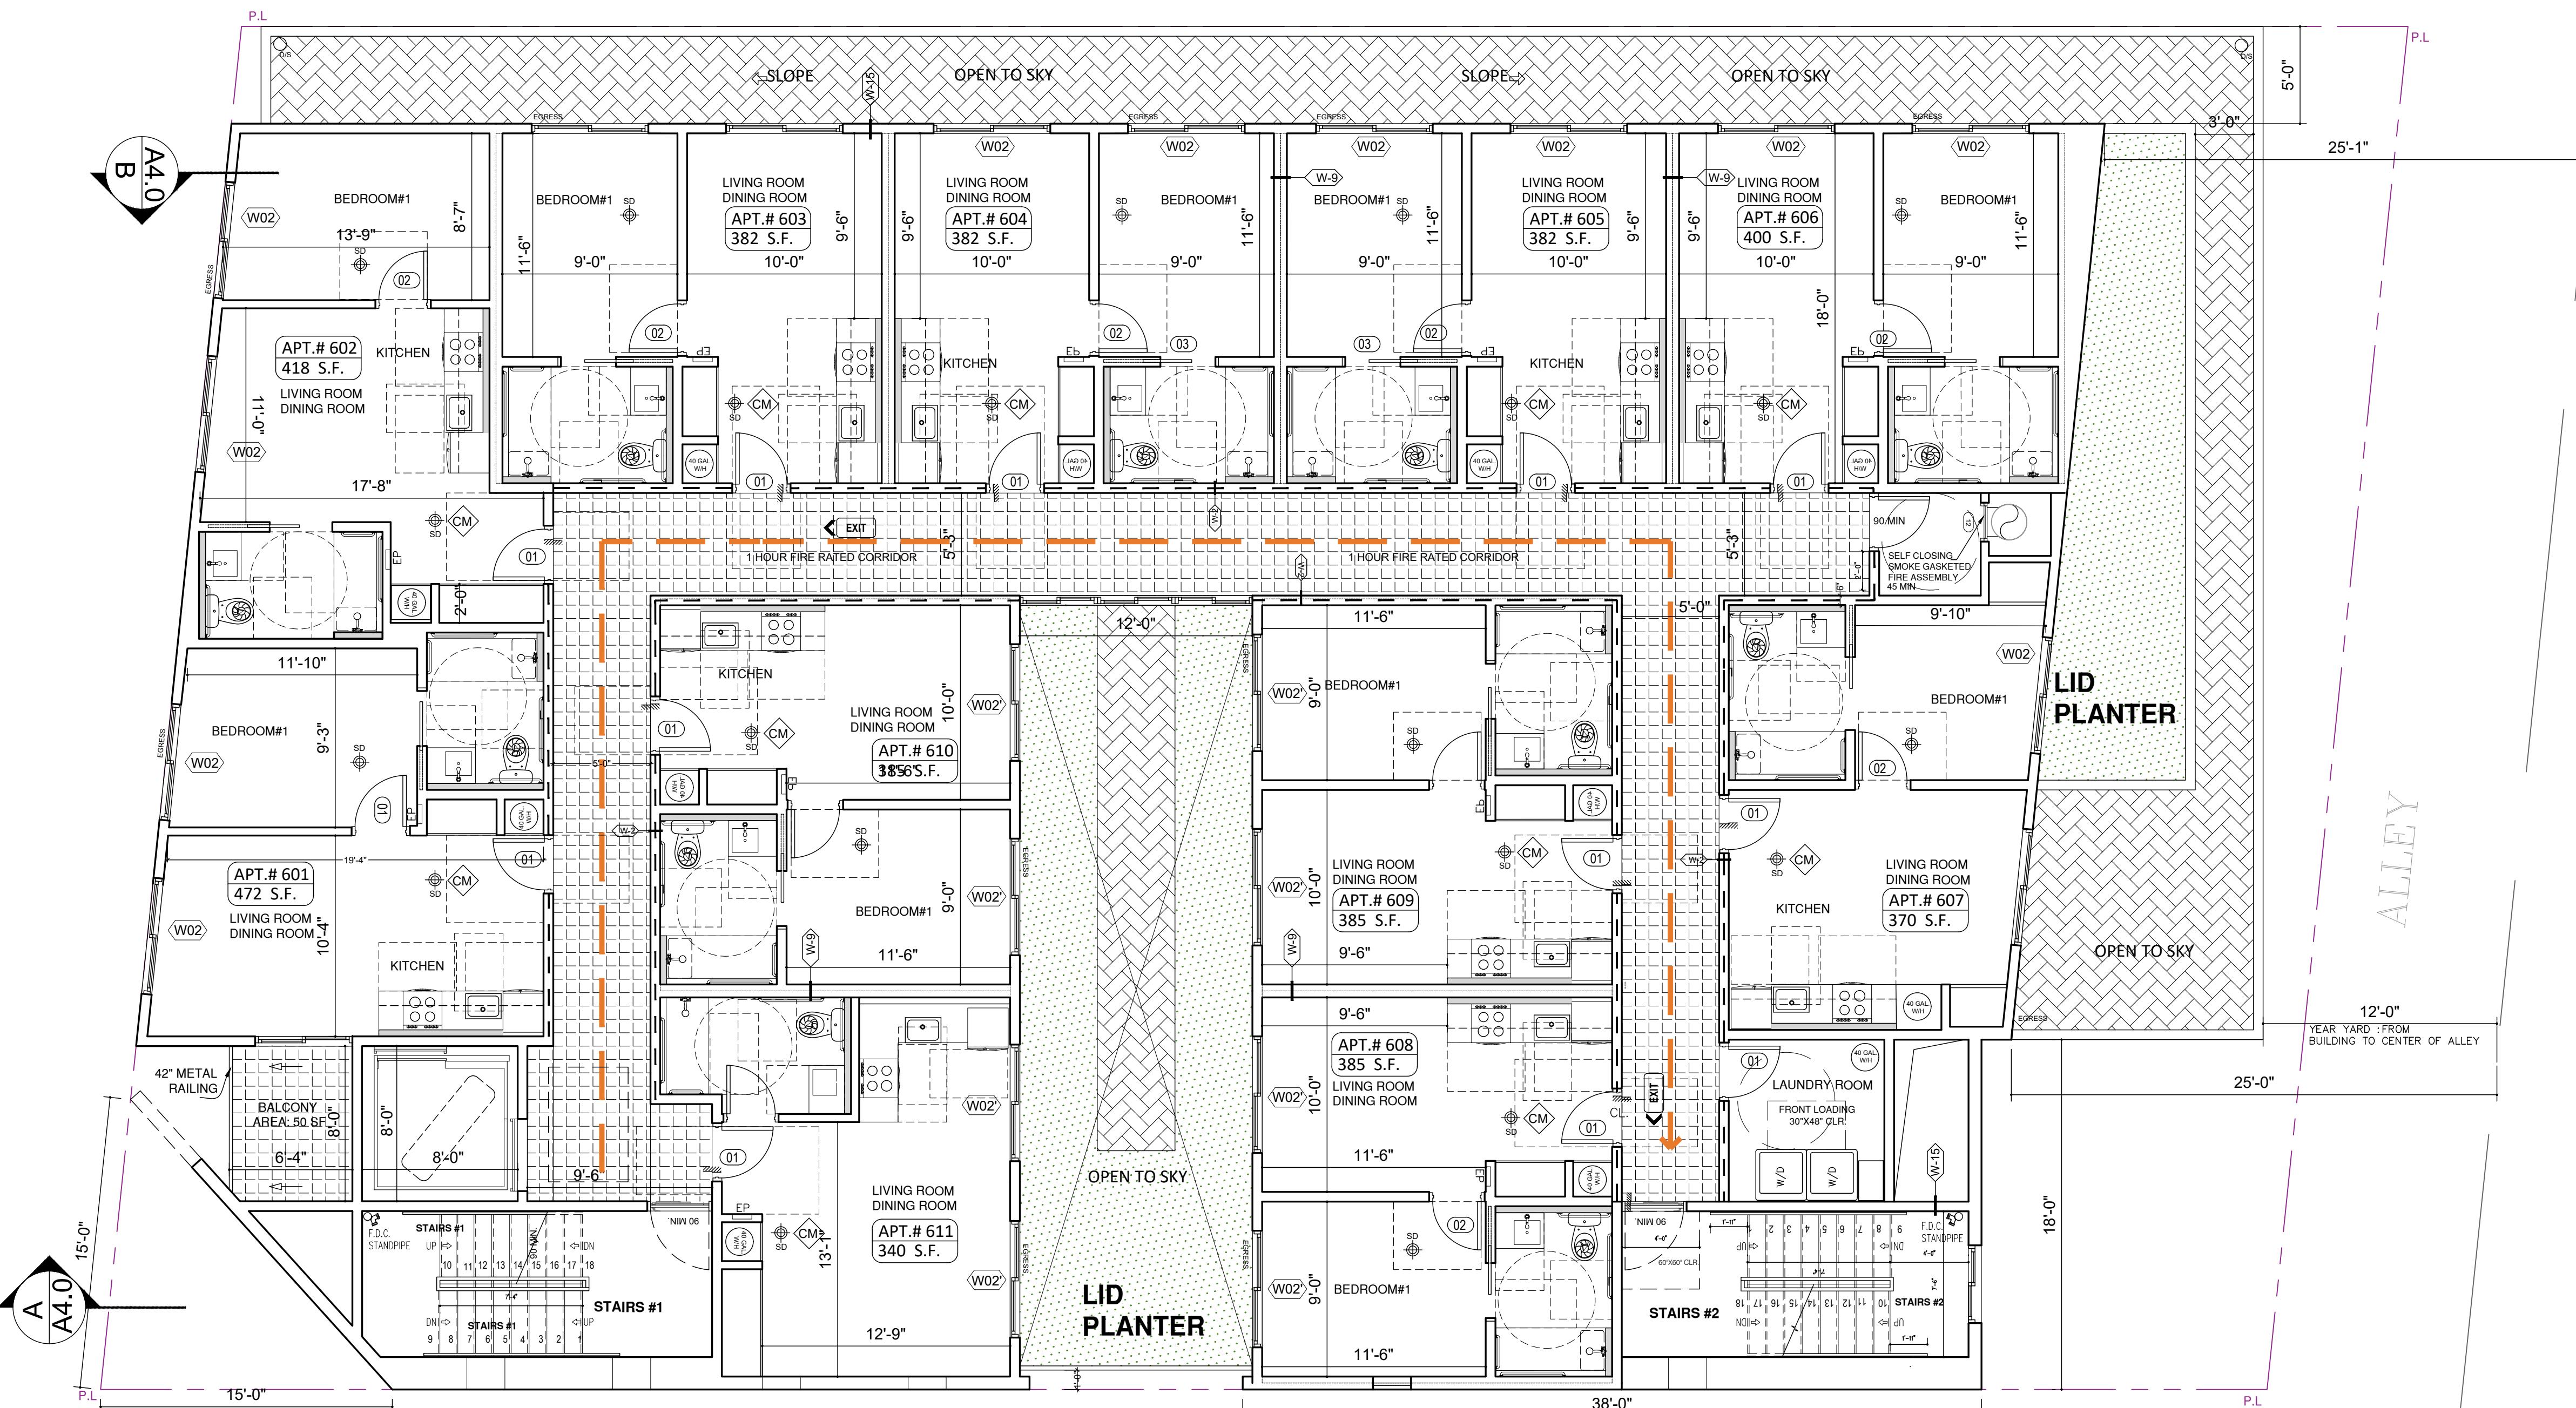

FLOOR PLAN NOTES

- REFER TO ENLARGED UNIT, STAIR AND ELEVATOR CORE PLANS FOR ADDITIONAL INFORMATION.
- ALL DIMENSIONS ARE TO FACE OF MASONRY, CONCRETE, OR STUDS, U.N.O.
- ALL WALLS TO TERMINATE TO UNDERSIDE OF FLOOR/CEILING/ROOF ASSEMBLY ABOVE U.N.O.
- ALL WOOD/METAL INTERIOR WALLS TO RECEIVE A MINIMUM OF (1) LAYER OF 5/8" GYPSUM WALL BOARD, EACH SIDE, U.N.O.
- ALIGN INTERIOR FACE OF SHAFT WALL FINISH WITH SLAB EDGE OF SHAFT OPENING TYPE, U.N.O.
- ALL EXTERIOR WALKWAYS INCLUDING BALCONY AND DECK SURFACES TO SLOPE A MAXIMUM OF 2%.
- WHERE DOORS ARE NOT DIMENSIONED DOORS SHALL BE INSTALLED WITH HINGE SIDE AT 4" FROM ADJACENT FRAMED WALL.
- PROVIDE 1/2" THICK FINISH AT THE FIRST 9 FEET, MEASURED FROM GRADE, AT EXTERIOR WALLS AND DOORS.
- ADDITIONAL LOW-LEVEL EXIT SIGNS SHALL BE PROVIDED IN ALL INTERIOR CORRIDORS OF GROUP A, E, I, R-2-1 (CBC 1013.7)
- NONABSORBENT INTERIOR FLOOR AND WALL FINISHES SHALL BE USED, WITHIN AT LEAST 2 FEET AROUND AND PERPENDICULAR TO EXTERIOR ENTRIES AND/OR OPENINGS SUBJECT TO APPROVAL BY THE LOCAL FIRE DEPARTMENT.
- WHERE REQUIRED BY NFPA 13 SECTION 8.15.1, PROVIDE FIRE SPRINKLER AT ALL VOID/CONCEALED SPACES THAT ARE CONSTRUCTED OF COMBUSTIBLE SPACES, WHERE ALTERNATE METHOD ARE ALLOWED, ONE OF THE FOLLOWING OPTIONS MAYBE USED UNLESS NOTED OTHERWISE:
 - A. NFPA 13 SECTION 8.15.1.27 FILL CONCEALED SPACE ENTIRELY WITH NONCOMBUSTIBLE INSULATION.
 - B. NFPA 13 SECTION 8.15.1.2.10 FINISH THE CONCEALED SPACE WITH TYPE X' GYP BD. AND NO ACCESS IS PROVIDED TO THE SPACE.
- WHERE REQUIRED BY NFPA 13 SECTION 8.15.1.2.10 FINISH THE CONCEALED SPACE WITH TYPE X' GYP BD. AND NO ACCESS IS PROVIDED TO THE SPACE.
- DECORATIVE SPACES SHALL BE DRAFT STOPPED, VOLUME NOT TO EXCEED 160 CFS, OR 100 CFS FOR 8.15.1.2.14 VERTICAL PIPE CHASES UNDER 10' WHERE PROVIDED. MULTIPLE VERTICAL PIPE CHASES WHERE PROVIDED, SHALL BE FIRESTOPPED AT EACH FLOOR USING MATERIALS EQUIVALENT TO THE FLOOR CONSTRUCTION, AND WHERE SUCH PIPE CHASE SHALL CONTAIN NO SOURCES OF IGNITION.
- AILLE AND AILSE ACCESSWAYS SERVING AS A PORTION OF THE EXIT ACCESS IN THE MEANS OF EGRESS SYSTEM SHALL COMPLY WITH CBC SECTION 1018. THE MINIMUM WIDTH OR REQUIRED CAPACITY OF AISLES SHALL BE UNOBSTRUCTED.

NOTES:

- DOUBLE STRIPING OF STALLS SHALL BE PER ZONING CODE SECTION 12.21A5, CHART NO. 5."

USEBLI ENCLOSED SPACE UNDER ENCLOSED OR UNENCLOSED

STEIRWAYS SHALL BE PROVIDED WITH A 2 HR FIRE-RESISTANCE RATED

COMPLIANT WITH THE FULL RATED RATING OF THE STAIRS ENCLOSURE

WHICHEVER IS GREATER. (1009.8.3)

BASE CABINETS DIRECTLY UNDER THE KITCHEN SINK COUNTER AREA,

INCLUDING TOEBOARD AND SHELVING, SHALL BE REMOVABLE WITHOUT

THE USE OF SPECIALIZED TOOLS OR KNOWLEDGE IN ORDER TO PROVIE

KNEE AND TOE SPACE FOR A WHEELCHAIR. THE FONOSH FLOOR BENEATH

THE KITCHEN SINK COUNTER AREA SHALL BE EXTENDED TO THE WALL

TYPE (1134.3)

THE INTER HEIGHT SHALL BE MAX. 36" NAD MATERIAL IS GRANITE STONE

OPTION 2, ONLY ONE BATHROOM WITHIN THE DWELLING UNIT SHALL BE

DESIGNED TO COMPLY WITH THE FOLLOWING:

1. TOILET, BATHING AND SHOWER FACILITIES SHALL COMPLY WITH SECTION

1134.4.

2. SHOWER SHALL COMPLY WITH SECTION 1134.5.

3. SHOWER SHALL COMPLY WITH SECTION 1134.6.

4. WATER CLOSET SHALL COMPLY WITH SECTION 1134.7.

5. LAVATORIES, VANITIES, MIRRORS AND TOWEL FIXTURES SHALL COMPLY WITH SECTION 1134.8.

6. WHERE BOTH A SHOWER AND TUB ARE PROVIDED IN THE BATHROOM, AT

7. WHEN TWO OR MORE AVATATES ARE PROVIDED AT LEAST ONE SHALL BE

MADE ACCESSIBLE AND COMPLY WITH SECTION 1134.8.

8. BATHROOM SHALL PROVIDED WITH AN ACCESSIBLE ROUTE INTO AND

THROUGH THE BATHROOM.

9. IF A DOOR IS PROVIDED, IT SHALL COMPLY WITH THE REQUIREMENTS TO

EXHAUST FAN SHALL BE ENERGY STAR COMPLIANT AND BE DUCTED TO

EXHAUST FAN INCORPORATED AS A COMPONENT OF A WHOLE HOME

VENTILATION SYSTEM, MUST BE CONTROLLED BY A HUMIDITY CONTROL

MULTI-FAMILY DWELLINGS NOT EXCEDING THREE STORIES AND CONTAINING

50 UNITS OR LESS SHALL INSTALL A SEPARATE METER OR SUBMITTER WITHIN

COMMON AREA SAND WITH EACH INDIVIDUAL DWELLING UNIT.

THE ELECTRICAL SYSTEM SHALL HAVE SUFFICIENT CAPACITY TO

SIMULTANEOUSLY CHARGE ALL DESIGNATED EV SPACE AT THE FULL RATED

AMPERAGE AND VOLTAGE. THE DESIGNATED EV SPACE SHALL USE A 40-AMPERE

MINIMUM BRANCH CIRCUIT. A SEPARATE ELECTRICAL PERMIT IS REQUIRED

THE SERVICE PANEL OR SUBPANEL, CIRCUIT DIRECTORY SHALL IDENTIFY THE

OVER CURRENT PROTECTIVE DEVICE (SPCS) RESERVED FOR FUTURE EV

CHARGING PURPOSES AS EV CAPABLE IN ACCORDANCE WITH THE LOS

ANGELES ELECTRICAL CODE, (4.106.4.2, 4.106.4.3)

REINFORCED BARS AROUND THE TOILET, TUB AND SHOWERS SHALL COMPLY WITH SECTION 1127A.5 FOR BATHTUBS, 1134A.6 FOR SHOWERS AND 1134.7 FOR WATER

CLOSET. GRAB BAR SHALL COMPLY WITH SECTION 1127A.4 AND 1127.2.2.

ITEM 4.

GREEN BUILDING CODE NOTES

- A SEPARATE ELECTRICAL PLAN CHECK IS REQUIRED TO VERIFY THE RACEWAY METHOD(S), WIRING SCHEMATIC(S) AND ELECTRICAL CALCULATIONS FOR THE ELECTRICAL CHARGING SYSTEM. THE ELECTRICAL SYSTEM SHALL HAVE SUFFICIENT CAPACITY TO SIMULTANEOUSLY CHARGE ALL ELECTRIC VEHICLES AT THEIR FULL RATED AMPERAGE.
- THE SERVICE PANEL OR SUBPANEL(S) SHALL HAVE SUFFICIENT CAPACITY TO ACCOMMODATE THE REQUIRED NUMBER OF DEDICATED 40 AMPERE MINIMUM BRANCH CIRCUITS FOR THE FUTURE INSTALLATION OF THE EVSE.
- THE ELECTRICAL SYSTEM SHALL HAVE SUFFICIENT CAPACITY TO SIMULTANEOUSLY CHARGE ALL DESIGNATED EV SPACES AT THE FULL RATED AMPERAGE.
- STRIPPING AT ACCESSIBLE PARKING STALLS, ACCESSIBLE PARKING AISLES AND ACCESSIBLE CROSSWALKS SHALL BE 3-INCH WIDE, BLUE PAINTED TRAFFIC GRADE STRIPING.
2. 12'-0" X 4' WIDE WHITE PAINTED STRIPING ADJACENT TO ALL DRIVE AISLES EXCEPT AT PARKING STALLS.
3. PROVIDE PIPE GUARDS AT ALL VERTICAL PLUMBING OR FIRE SPRINKLER LINES LOCATED ADJACENT TO COLUMN OR WALLS AT HEAD END OF PARKING. REFER TO PLUMBING AND FIRE SPRINKLER DRAWINGS FOR LOCATIONS.
4. ALIGN GARAGE AISLES TO HAVE A MINIMUM 8'-0" HEAD CLEARANCE HEIGHT.
5. FOR REQUIRED DRIVE THRU, PROVIDE A 10'-0" RADIUS CLEARANCES. SEE DIAGRAM PROVIDED.
6. THE SURFACE SLOPE FOR EV SPACES SHALL NOT EXCEED 2.03% IN ANY DIRECTION.
7. NOT USED.
8. 8'-2" MIN. CLEAR HEIGHT IS REQUIRED TO ANY OBSTRUCTION AT ACCESSIBLE PARKING STALLS.
9. 7'-0" CLEAR HEIGHT IS REQUIRED TO ANY OBSTRUCTION AT ALL PARKING AREAS, UNLESS NOTED OTHERWISE.
10. PARKING AREAS AS ENCLOSED PARKING GARAGE, PROVIDE MECHANICAL VENTILATION PER CALIFORNIA MECHANICAL CODE.
11. EXHAUST FAN SHALL BE ENERGY STAR COMPLIANT AND BE DUCTED TO EXHAUST FAN INCORPORATED AS A COMPONENT OF A WHOLE HOME VENTILATION SYSTEM, MUST BE CONTROLLED BY A HUMIDITY CONTROL
- MULTI-FAMILY DWELLINGS NOT EXCEDING THREE STORIES AND CONTAINING
- 50 UNITS OR LESS SHALL INSTALL A SEPARATE METER OR SUBMITTER WITHIN
- COMMON AREA SAND WITH EACH INDIVIDUAL DWELLING UNIT.
- THE ELECTRICAL SYSTEM SHALL HAVE SUFFICIENT CAPACITY TO
- SIMULTANEOUSLY CHARGE ALL DESIGNATED EV SPACE AT THE FULL RATED
- AMPERAGE BASED ON LEVEL 2 EVSE. A SEPARATE ELECTRICAL PERMIT IS REQUIRED.
- A LABEL 'EV CAPABLE' SHALL BE POSTED IN A CONSPICUOUS PLACE AT HTE SERVICE PANEL OR SUBPANEL AND EV CHARGING SPACE (4.106.4.2)
12. TWO-WAY COMMUNICATION SYSTEM COMPLYING WITH SECTIONS 1099.8.1 AND 1099.8.2 SHALL BE PROVIDED AT THE LANDING SERVING EACH ELEVATOR OR BALK OF ELEVATORS ON EACH ACCESSIBLE FLOOR THAT IS ONE OR MORE STORIES ABOVE OR BELOW THE LEVEL OF EXIT DISCHARGE.
- PROVIDE SLIP RESISTANT SURFACES ALONG MEANS OF EGGS
- PATH OF TRAVEL PER CODE NO. 1003.4

GARAGE NOTES



1. STRIPPING AT ACCESSIBLE PARKING STALLS, ACCESSIBLE PARKING AISLES AND ACCESSIBLE CROSSWALKS SHALL BE 3-INCH WIDE, BLUE PAINTED TRAFFIC GRADE STRIPING.
2. 12'-0" X 4' WIDE WHITE PAINTED STRIPING ADJACENT TO ALL DRIVE AISLES EXCEPT AT PARKING STALLS.
3. PROVIDE PIPE GUARDS AT ALL VERTICAL PLUMBING OR FIRE SPRINKLER LINES LOCATED ADJACENT TO COLUMN OR WALLS AT HEAD END OF PARKING. REFER TO PLUMBING AND FIRE SPRINKLER DRAWINGS FOR LOCATIONS.
4. ALIGN GARAGE AISLES TO HAVE A MINIMUM 8'-0" HEAD CLEARANCE HEIGHT.
5. FOR REQUIRED DRIVE THRU, PROVIDE A 10'-0" RADIUS CLEARANCES. SEE DIAGRAM PROVIDED.
6. THE SURFACE SLOPE FOR EV SPACES SHALL NOT EXCEED 2.03% IN ANY DIRECTION.
7. NOT USED.
8. 8'-2" MIN. CLEAR HEIGHT IS REQUIRED TO ANY OBSTRUCTION AT ACCESSIBLE PARKING STALLS.
9. 7'-0" CLEAR HEIGHT IS REQUIRED TO ANY OBSTRUCTION AT ALL PARKING AREAS, UNLESS NOTED OTHERWISE.
10. PARKING AREAS AS ENCLOSED PARKING GARAGE, PROVIDE MECHANICAL VENTILATION PER CALIFORNIA MECHANICAL CODE.
11. EXHAUST FAN SHALL BE ENERGY STAR COMPLIANT AND BE DUCTED TO EXHAUST FAN INCORPORATED AS A COMPONENT OF A WHOLE HOME VENTILATION SYSTEM, MUST BE CONTROLLED BY A HUMIDITY CONTROL
- MULTI-FAMILY DWELLINGS NOT EXCEDING THREE STORIES AND CONTAINING
- 50 UNITS OR LESS SHALL INSTALL A SEPARATE METER OR SUBMITTER WITHIN
- COMMON AREA SAND WITH EACH INDIVIDUAL DWELLING UNIT.
- THE ELECTRICAL SYSTEM SHALL HAVE SUFFICIENT CAPACITY TO
- SIMULTANEOUSLY CHARGE ALL DESIGNATED EV SPACE AT THE FULL RATED
- AMPERAGE BASED ON LEVEL 2 EVSE. A SEPARATE ELECTRICAL PERMIT IS REQUIRED.
- A LABEL 'EV CAPABLE' SHALL BE POSTED IN A CONSPICUOUS PLACE AT HTE SERVICE PANEL OR SUBPANEL AND EV CHARGING SPACE (4.106.4.2)
12. TWO-WAY COMMUNICATION SYSTEM COMPLYING WITH SECTIONS 1099.8.1 AND 1099.8.2 SHALL BE PROVIDED AT THE LANDING SERVING EACH ELEVATOR OR BALK OF ELEVATORS ON EACH ACCESSIBLE FLOOR THAT IS ONE OR MORE STORIES ABOVE OR BELOW THE LEVEL OF EXIT DISCHARGE.
- PROVIDE SLIP RESISTANT SURFACES ALONG MEANS OF EGGS
- PATH OF TRAVEL PER CODE NO. 1003.4

NOMINAL WALL THICKNESS / STUD SIZE
(2= 2-1/2" STUDS FOR METAL FRAMED TYPES)
(4= 3-5/8" STUD FOR METAL FRAMED TYPES)
(4= 2X4 STUD FOR WOOD FRAMED TYPES)
(6= 2X6 STUD FOR WOOD FRAMED TYPES)

ITEM 4.

LADBS APPROVAL STAMP

SEVENTH FLOOR
SCALE: 3/16"=1'-0"

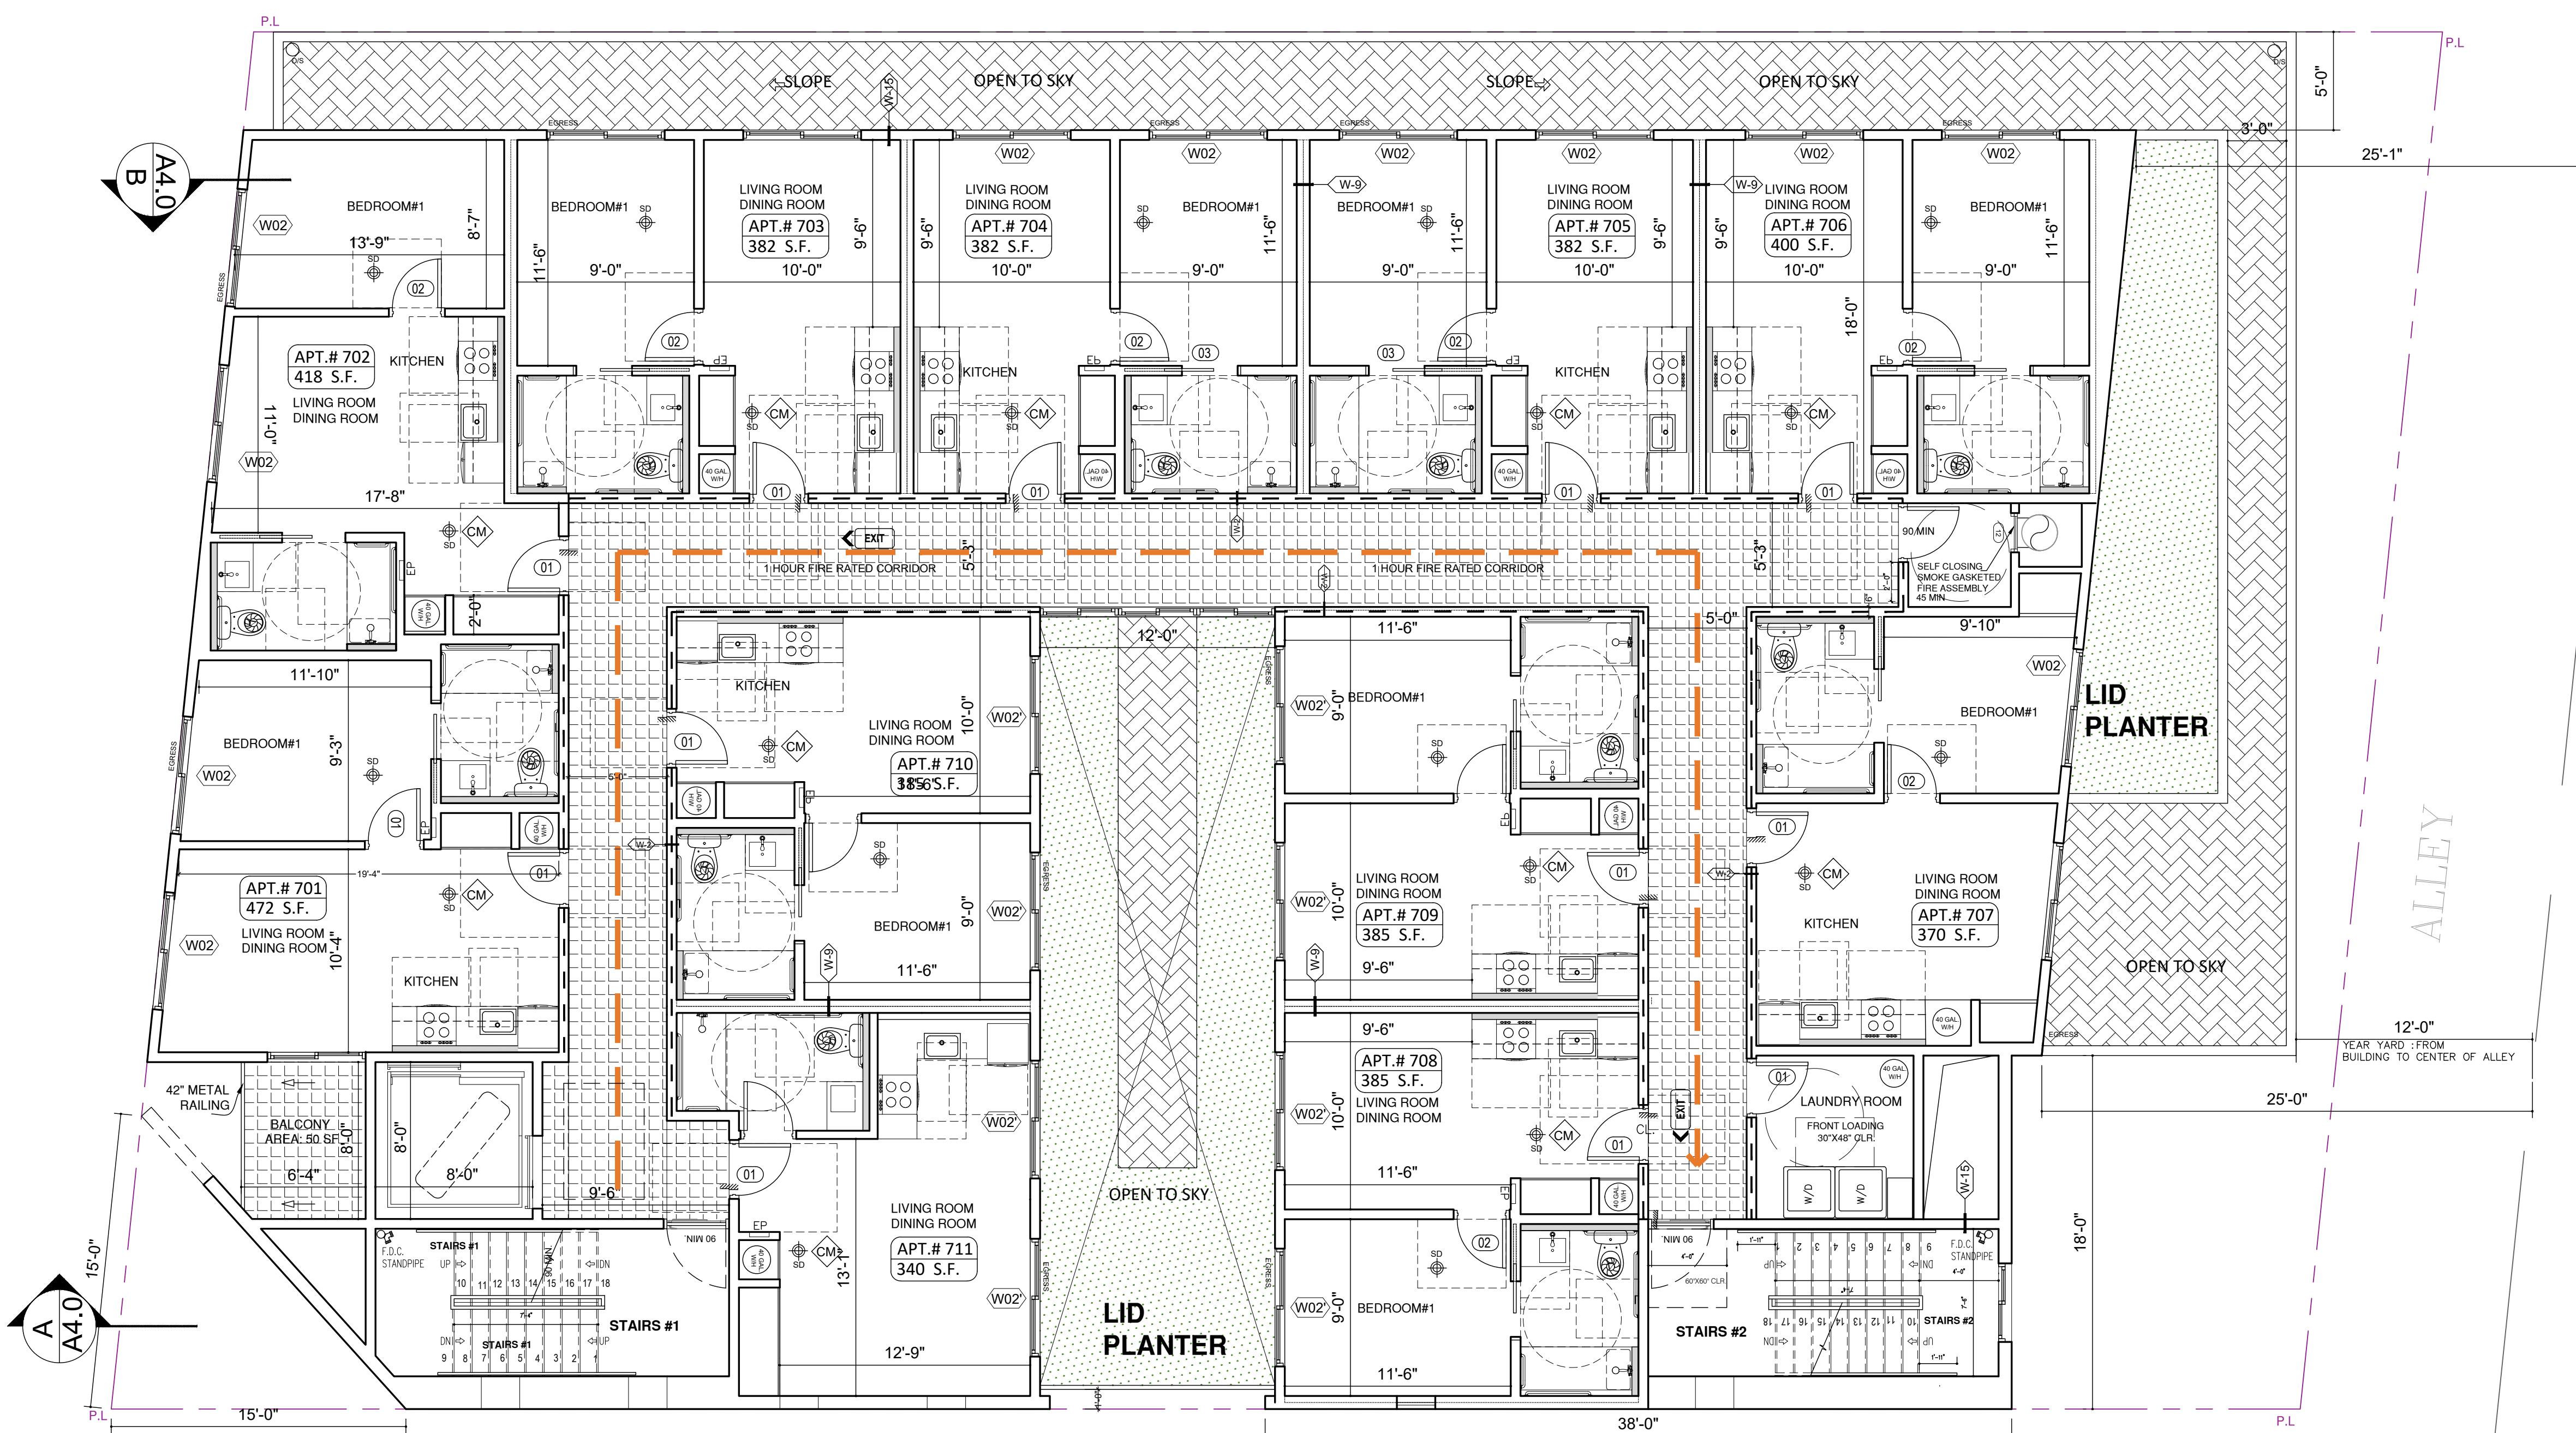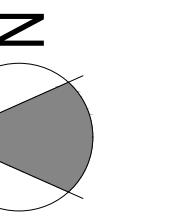

NOTICE
THE DESIGNS SHOWN AND DESCRIBED
HEREIN, INCLUDING ALL TECHNICAL
DRAWINGS, GRAPHICS, AND MODELS
THEREOF, ARE PROPRIETARY AND SHALL NOT
BE COPIED, REPRODUCED, REPROCESSED
COMMERCIALIZED IN WHOLE OR IN
PART WITHOUT THE WRITTEN PERMISSION OF
BEVERLY DESIGN.
ALL THESE DOCUMENTS HAVE BEEN
PREPARED TO DESCRIBE NEW WORK ONLY
AND DO NOT REPRESENT AS-BUILT OR
ACCURATE EXISTING CONDITIONS. THE
DESIGNER DOES NOT WARRANT IN ANY WAY
THE ACCURACY OF THE INFORMATION AND
SHALL NOT BE RESPONSIBLE FOR
DISCREPANCIES BETWEEN THIS DOCUMENT
AND EXISTING CONDITIONS. THESE PLANS ARE
THE PROPERTY OF BEVERLY DESIGN.
THESE PLANS ARE
AVAILABLE FOR LIMITED REVIEW AND
EVALUATION AS INSTRUMENTS OF SERVICE
BY THE CLIENT, CONSULTANTS,
CONTRACTORS, AGENTS, VENDORS AND
OFFICE PERSONNEL ONLY IN
ACCORDANCE WITH THIS NOTICE. DO NOT
SCALE OFF THESE DRAWINGS. ALL RIGHTS
RESERVED COPYRIGHT, BEVERLY DESIGN

OWNER :
8688 WEST PICO LLC
PROJECT :
8688 W Pico Blvd,
Los Angeles, CA 90035
SHEET TITLE:
SEVENTH FLOOR
PLAN

REVISION:
NO. DATE BY

FLOOR PLAN NOTES

- REFER TO ENLARGED UNIT, STAIR AND ELEVATOR CORE PLANS FOR ADDITIONAL INFORMATION.
- ALL DIMENSIONS ARE TO FACE OF MASONRY, CONCRETE, OR STUDS, U.N.O.
- ALL WALLS TO TERMINATE TO UNDERSIDE OF FLOOR/CEILING/ROOF ASSEMBLY ABOVE U.N.O.
- ALL WOOD/METAL INTERIOR WALLS TO RECEIVE A MINIMUM OF (1) LAYER OF 5/8" GYPSUM WALL BOARD, EACH SIDE, U.N.O.
- ALIGN INTERIOR FACE OF SHAFT WALL FINISH WITH SLAB EDGE OF SHAFT OPENING TYP. U.N.O.
- ALL EXTERIOR WALKWAYS INCLUDING BALCONY AND DECK SURFACES TO SLOPE A MAXIMUM OF 2%.
- WHERE DOORS ARE NOT DIMENSIONED DOORS SHALL BE INSTALLED WITH HINGE SIDE AT 4" FROM ADJACENT FRAMED WALL.
- PROVIDE 1/2" THICK FLOOR FINISH AT THE FIRST 9 FEET, MEASURED FROM GRADE, AT EXTERIOR WALLS AND DOORS.
- ADDITIONAL LOW-LEVEL EXIT SIGNS SHALL BE PROVIDED IN ALL INTERIOR CORRIDORS OF GROUP A, E, R-2-1 (CBC 1013.7)
- NONABSORBENT INTERIOR FLOOR AND WALL FINISHES SHALL BE USED, WITHIN AT LEAST 2 FEET AROUND AND PERPENDICULAR TO EXTERIOR ENTRIES AND/OR OPENINGS SUBJECT TO NFPA 13.
- WHERE REQUIRED BY NFPA 13 SECTION 8.15.1, PROVIDE FIRE SPRINKLER AT ALL VOID/CONCEALED SPACES THAT ARE CONSTRUCTED OF COMBUSTIBLE SPACES, WHERE ALTERNATE METHOD ARE ALLOWED, ONE OF THE FOLLOWING OPTIONS MAYBE USED UNLESS NOTED OTHERWISE:
 - A. NFPA 13 SECTION 8.15.1.2.7 FILL CONCEALED SPACE ENTIRELY WITH NONCOMBUSTIBLE INSULATION.
 - B. NFPA 13 SECTION 8.15.1.2.10 FINISH THE CONCEALED SPACE WITH TYPE X' GYP BD. AND NO ACCESS IS PROVIDED TO THE SPACE.
 - C. NFPA 13 SECTION 8.15.1.2.18.2 COMBUSTIBLE SOFFITS, EAVES, OVERHANG AND DECORATIVE ELEMENTS SHALL BE DRAFT STOPPED, VOLUME NOT TO EXCEED 160 CFS, FOR NFPA 13 SECTION 8.15.1.2.14 VERTICAL PIPE CHASES UNDER 10' WHERE PROVIDED, MULTIPLE CHASES WHERE PROVIDED, SHALL BE FIRESTOPPED AT EACH FLOOR USING MATERIALS EQUIVALENT TO THE FLOOR CONSTRUCTION, AND WHERE SUCH PIPE CHASE SHALL CONTAIN NO SOURCES OF IGNITION.
 - D. AISLE AND AISLE ACCESSWAYS SERVING AS A PORTION OF THE EXIT ACCESS IN THE MEANS OF EGRESS SYSTEM SHALL COMPLY WITH CBC SECTION 1018. THE MINIMUM WIDTH OR REQUIRED CAPACITY OF AISLES SHALL BE UNOBSTRUCTED.

NOTES:

- DOUBLE STRIPING OF STALLS SHALL BE PER ZONING CODE SECTION 12.21A.5, CHART NO. 5."
- USEBLU ENCLOSED SPACE UNDER ENCLOSED OR UNENCLOSED STEIRWAYS SHALL BE PROVIDED WITH A 2 HR FIRE-RESISTANCE RATED CONSTRUCTION. THE FULL RATED RATING OF THE STAIRS ENCLOSURE WHICH EVER IS GREATER. (1009.8.3)
- BASE CABINETS DIRECTLY UNDER THE KITCHEN SINK COUNTER AREA, INCLUDING TOEBOARD AND SHELVING, SHALL BE REMOVABLE WITHOUT THE USE OF SPECIALIZED TOOLS OR KNOWLEDGE IN ORDER TO PROVIDE KNEE AND TOE SPACE FOR A WHEELCHAIR. THE FONOSH FLOOR TYPICAL KITCHEN SINK COUNTER AREA SHALL BE EXTENDED TO THE WALL TYP. (1132.3)
- THE INTERIOR HEIGHT SHALL BE MAX. 36" NAD MATERIAL IS GRANITE STONE. OPTION 2, ONLY ONE BATHROOM WITHIN THE DWELLING UNIT SHALL BE DESIGNED TO COMPLY WITH THE FOLLOWING:

 - 1. TOILET, BATHING AND SHOWER FACILITIES SHALL COMPLY WITH SECTION 1134.4.
 - 2. SHOWER SHALL COMPLY WITH SECTION 1134.5.
 - 3. SHOWER SHALL COMPLY WITH SECTION 1134A.6.
 - 4. WATER CLOSET SHALL COMPLY WITH SECTION 1134A.7.

- 5. LAVATORIES, VANITIES, MIRRORS AND TOWEL FIXTURES SHALL COMPLY WITH SECTION 1134A.8.
- 6. WHERE BOTH A SHOWER AND TUB ARE PROVIDED IN THE BATHROOM, AT LEAST ONE OF THE FIXTURES SHALL BE MADE ACCESSIBLE.
- 7. WHEN TWO OR MORE AVATATES ARE PROVIDED AT LEAST ONE SHALL BE MADE ACCESSIBLE AND COMPLY WITH SECTION 1134A.8.
- 8. BATHROOM SHALL PROVIDED WITH AN ACCESSIBLE ROUTE INTO AND THROUGH THE BATHROOM.
- 9. IF A DOOR IS PROVIDED, IT SHALL COMPLY WITH THE REQUIREMENTS OF SECTION 1134.5.
- 10. A MIN. 18-INCH (457MM) CLEAR MANEUVERING SPACE SHALL BE PROVIDED ON THE SIDE OF THE BATHROOM NOT DEDICATED TO THE EXISTING EGRESS. THE SIDE OF THE BATHROOM NOT DEDICATED TO THE EXISTING EGRESS SHALL BE PROVIDED WITH A 24-INCH (610MM) CLEAR MANEUVERING SPACE, WHICH SHALL BE PROVIDED IN ADDITION TO THE 18-INCH (457MM) CLEAR MANEUVERING SPACE PROVIDED ON THE SIDE OF THE BATHROOM DEDICATED TO THE EXISTING EGRESS.
- 11. SWITCHES, OUTLETS AND CONCEALED SHALL COMPLY WITH SECTION 1142A.5 FOR BATHROOMS; 1134A.6 FOR SHOWERS AND 1134A.7 FOR WATER CLOSET. GRAB BAR SHALL COMPLY WITH SECTION 1127A.4 AND 1127.2.2. ITEM 4.

GREEN BUILDING CODE NOTES

- A SEPARATE ELECTRICAL PLAN CHECK IS REQUIRED TO VERIFY THE RACEWAY (METHOD), WIRING SCHEMATICS AND ELECTRICAL CALCULATIONS FOR THE ELECTRICAL CHARGING SYSTEM. THE ELECTRICAL SYSTEM SHALL HAVE SUFFICIENT CAPACITY TO SIMULTANEOUSLY CHARGE ALL ELECTRIC VEHICLES AT THEIR FULL RATED AMPERAGE.
- THE SERVICE PANEL OR SUBPANEL(S) SHALL HAVE SUFFICIENT CAPACITY TO ACCOMMODATE THE REQUIRED NUMBER OF DEDICATED 40 AMPERE MINIMUM BRANCH CIRCUITS FOR THE FUTURE INSTALLATION OF THE EVSE.
- THE ELECTRICAL SYSTEM SHALL HAVE SUFFICIENT CAPACITY TO SIMULTANEOUSLY CHARGE ALL DESIGNATED EV SPACES AT THE FULL RATED AMPERAGE OF THE EVSE. PLAN DESIGN SHALL BE BASED UPON THE FULL RATED AMPERAGE OF THE EVSE.
- THE SERVICE PANEL OR SUBPANEL CIRCUIT DIRECTORY SHALL IDENTIFY THE OVERCURRENT PROTECTIVE DEVICE SPACES RESERVED FOR FUTURE EV CHARGING PURPOSES AS EV CAPABLE IN ACCORDANCE WITH THE LOS ANGELES ELECTRICAL CODE. THE RACEWAY TERMINATION SHALL BE PERMANENTLY AND VISIBLELY MARKED AS "EV CAPABLE".
- EXHAUST FAN SHALL BE ENERGY STAR COMPLIANT AND BE DUCTED TO EXHAUST FAN INQUIRIES, CALL THE MANUFACTURER OF A WHOLE HOME VENTILATION SYSTEM. MUST BE CONTROLLED BY A HUMIDITY CONTROL.
- MULTI-FAMILY DWELLINGS NOT EXCEEDING THREE STORIES AND CONTAINING 50 UNITS OR LESS SHALL INSTALL A SEPARATE METER OR SUBMETER WITHIN COMMON AREA SAND WITH EACH INDIVIDUAL DWELLING UNIT.
- THE SERVICE PANEL OR SUBPANEL CIRCUIT DIRECTORY SHALL IDENTIFY THE OVERCURRENT PROTECTIVE DEVICE SPACES RESERVED FOR FUTURE EV CHARGING PURPOSES AS EV CAPABLE IN ACCORDANCE WITH THE LOS ANGELES ELECTRICAL CODE. (4.106.4.2, 4.106.4.3)

GARAGE NOTES

- STRIPING AT ACCESSIBLE PARKING STALLS, ACCESSIBLE PARKING AISLES AND ACCESSIBLE CROSSWALKS SHALL BE 3-INCH WIDE, BLUE PAINTED TRAFFIC GRADE STRIPING.
- 2" P-4" WIDE WHITE PAINTED STRIPING ADJACENT TO ALL DRIVE AISLES EXCEPT AT PARKING STALLS.
3. PROVIDE PIPE GUARDS AT ALL VERTICAL PLUMBING OR FIRE SPRINKLER LINES LOCATED ADJACENT TO COLUMN OR WALLS AT HEAD END OF PARKING. REFER TO PLUMBING AND FIRE SPRINKLER DRAWINGS FOR LOCATIONS.
4. ALL GARAGE AREAS TO HAVE A MINIMUM 7' HEAD CLEARANCE HEIGHT.
5. FOR REQUIRED DRIVE CLEARANCES, SEE RADIUS CLEARANCES, SEE DIAGRAM PROVIDED.
6. THE SURFACE SLOPE FOR EV SPACES SHALL NOT EXCEED 2.063% IN ANY DIRECTION.
7. NOT USED.
8. 8'2" MIN. CLEAR HEIGHT IS REQUIRED TO ANY OBSTRUCTION AT ACCESSIBLE PARKING STALLS AND ACCESS AISLES LEADING TO ACCESSIBLE PARKING STALLS.
9. 7' MIN. CLEAR HEIGHT IS REQUIRED TO ANY OBSTRUCTION AT ALL PARKING AREAS, UNLESS NOTED OTHERWISE.
10. PARKING AREAS AS ENCLOSED PARKING GARAGE, PROVIDE MECHANICAL VENTILATION PER CALIFORNIA MECHANICAL CODE.

NOTE

- ALL FIRE PARTITION WALLS (LABC 708) SHALL BE 1 HOUR RATED STC50
- WALLS (FIRE BARRIERS 707.3.1) IN SHAFTS AS ELEVATOR, STAIRS, ETC.
- FIRE PARTITION CORRIDORS SHALL BE 1 HOUR RATED
- ALL BEARING WALLS SHALL BE 1 HOUR RATED
- THE FLOOR/CEILING ASSEMBLIES SHALL BE 1 HOUR RATED STC50.
- NON-COMBUSTIBLE DRAFT STOES SHALL BE PROVIDED.
- Recycling chutes shall be clearly marked "RECYCLING ONLY" at every point of entry.

NOMINAL WALL THICKNESS / STUD SIZE
(4= 2-1/2" STUDS FOR METAL FRAMED TYPES)
(4= 3-5/8" STUD FOR METAL FRAMED TYPES)
(4= 2X4 STUD FOR WOOD FRAMED TYPES)
(6= 2X6 STUD FOR WOOD FRAMED TYPES)

MODEL 4400R STANDARD RECESSED KEY BOX FOR LOW-RISE BUILDING

BP TO PROVIDE SIGN THAT INDICATES BICYCLE PARKING LOCATION PER SECTION 12.21A.16(e4)

R TO PROVIDE 100 SQUARE FEET FOR MULTI-FAMILY RESIDENTIAL USES OF 51 OR MORE DWELLING UNITS

EV. ELECTRICAL VEHICLE SUPPLY WIRING FOR FUTURE, REFER TO SHEET N-1(GB)

* THE PANEL OR SUBPANEL SHALL HAVE SUFFICIENT CAPACITY TO SUPPORT AT LEAST LEVEL 2 EVSE.

* THE ELECTRICAL SYSTEM SHALL HAVE SUFFICIENT CAPACITY TO SIMULTANEOUSLY CHARGE ALL DESIGNED EV SPACES AT FULL RATED AMPERAGE BASED ON LEVEL 2 EVSE. A SEPARATE ELECTRICAL PERMIT IS REQUIRED.

* A LABEL 'EV CAPABLE' SHALL BE POSTED IN A CONSPICUOUS PLACE AT HTE SERVICE PANEL OR SUBPANEL AND EV CHARGING SPACE (4.106.4.2)

5. PROVIDE SLIP RESISTANT SURFACES ALONG MEANS OF EGGS

PATH OF TRAVEL PER CODE NO. 1003.4

TW 10. TWO-WAY COMMUNICATION SYSTEM COMPLYING WITH SECTION

1009.8.1

AND 1009.8.2 SHALL BE PROVIDED AT THE LANDING SERVING EACH

ELEVATOR OR BANK OF ELEVATORS ON EACH ACCESSIBLE FLOOR

THAT IS ONE OR MORE STORIES ABOVE OR BELOW THE LEVEL OF EXIT DISCHARGE.

SR PROVIDE SLIP RESISTANT SURFACES ALONG MEANS OF EGGS

PATH OF TRAVEL PER CODE NO. 1003.4

SCALE :
DRAWN :
DATE : December 25
JOB NUMBER :

SHEET :

LADBS APPROVAL STAMP

A2.6

NOTICE
THE DESIGNS SHOWN AND DESCRIBED
HEREIN, INCLUDING ALL TECHNICAL
DRAWINGS, GRAPHICS, AND MODELS
THEREOF, ARE PROPRIETARY AND SHALL NOT
BE REPRODUCED, REPLICATED, OR
COMMERCIALIZED IN WHOLE OR IN
PART WITHOUT THE WRITTEN PERMISSION OF
BEVERLY DESIGN.
ALL THESE DRAWINGS HAVE BEEN
PREPARED TO DESCRIBE NEW WORK ONLY
AND DO NOT REPRESENT AS-BUILT OR
ACCURATE EXISTING CONDITIONS. THE
DESIGNER DOES NOT WARRANT IN ANY WAY
THE ACCURACY OF THE INFORMATION AND
SHALL NOT BE RESPONSIBLE FOR
DISCREPANCIES BETWEEN THIS DOCUMENT
AND EXISTING CONDITIONS. THESE PLANS ARE
THE PROPERTY OF BEVERLY DESIGN AND
ARE AVAILABLE FOR LIMITED REVIEW AND
EVALUATION AS INSTRUMENTS OF SERVICE
BY THE CLIENT, CONSULTANTS,
CONTRACTORS, AGENTS,
VENDORS AND OTHER PERSONNEL ONLY IN
ACCORDANCE WITH THIS NOTICE. DO NOT
SCALE OFF THESE DRAWINGS. ALL RIGHTS
RESERVED COPYRIGHT, BEVERLY DESIGN







ROOF PLAN
SCALE: 3/16"=1'-0"

OWNER :
8688 WEST PICO LLC
PROJECT :
8688 W Pico Blvd,
Los Angeles, CA 90035
SHEET TITLE:
ROOF PLAN

REVISION:
NO. DATE BY
1. 12/03/2023 BY
2. 12/03/2023 BY
3. 12/03/2023 BY
408. 12/03/2023 BY
409. 12

LEGEND:

- GROSS AREA
- LOBBY, TRASH AND RECYCLE ROOM
- STAIRCASE AND ELEVATOR
- VENT SHAFTS, TRASH CHUTE

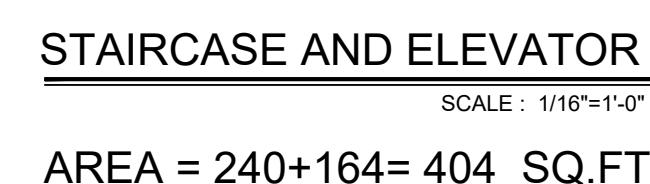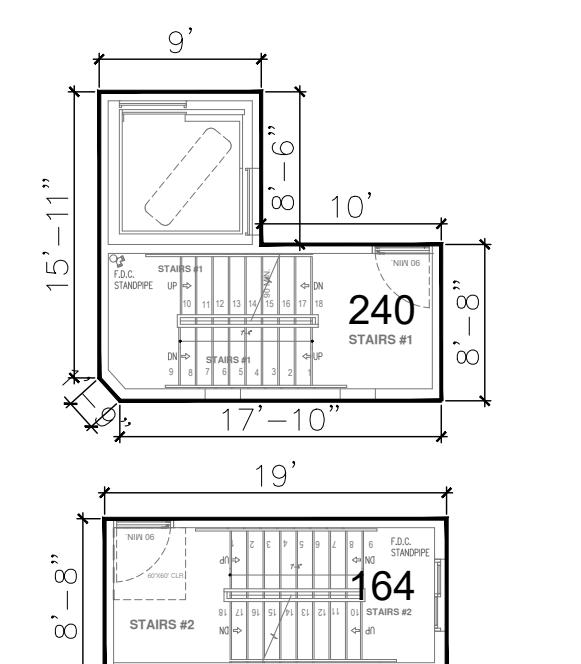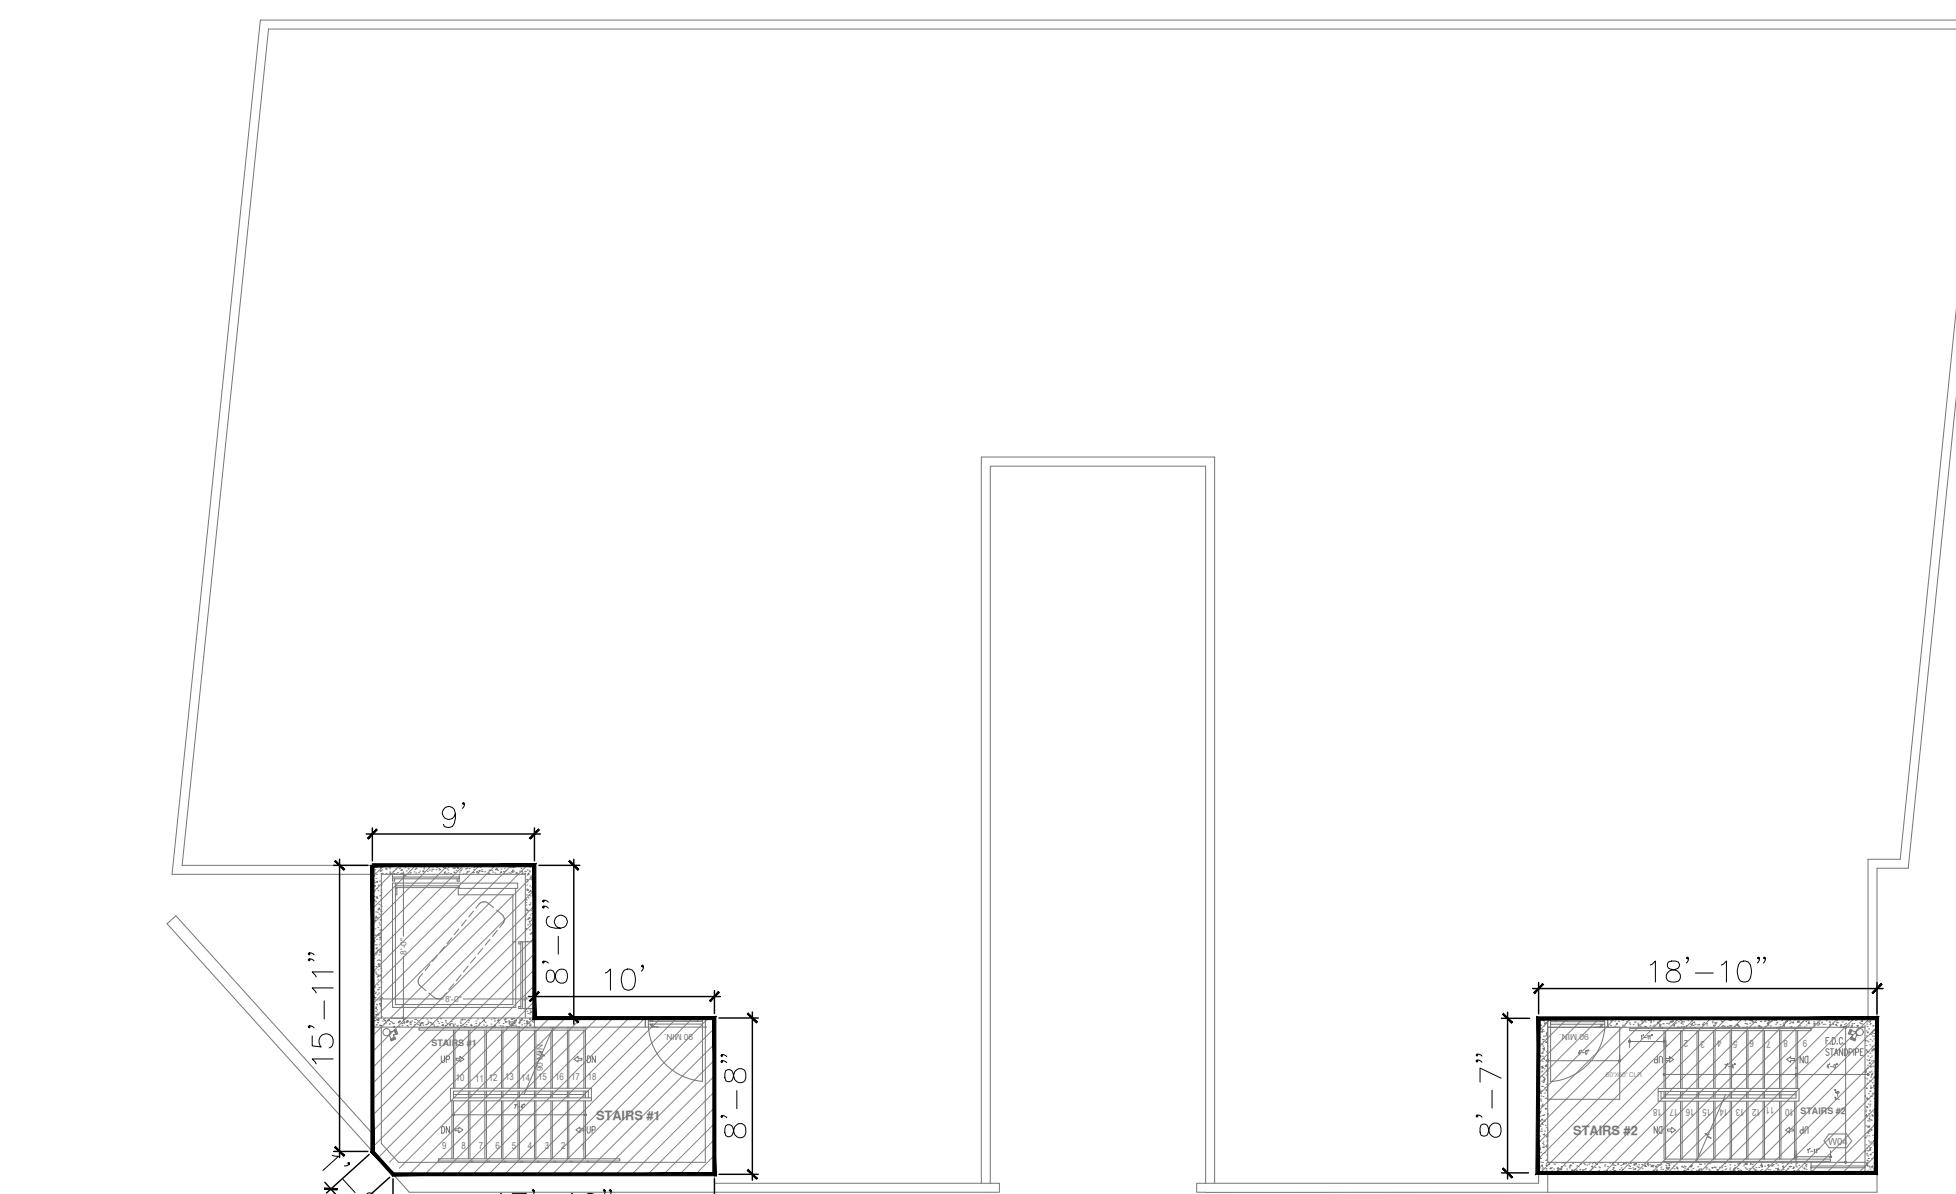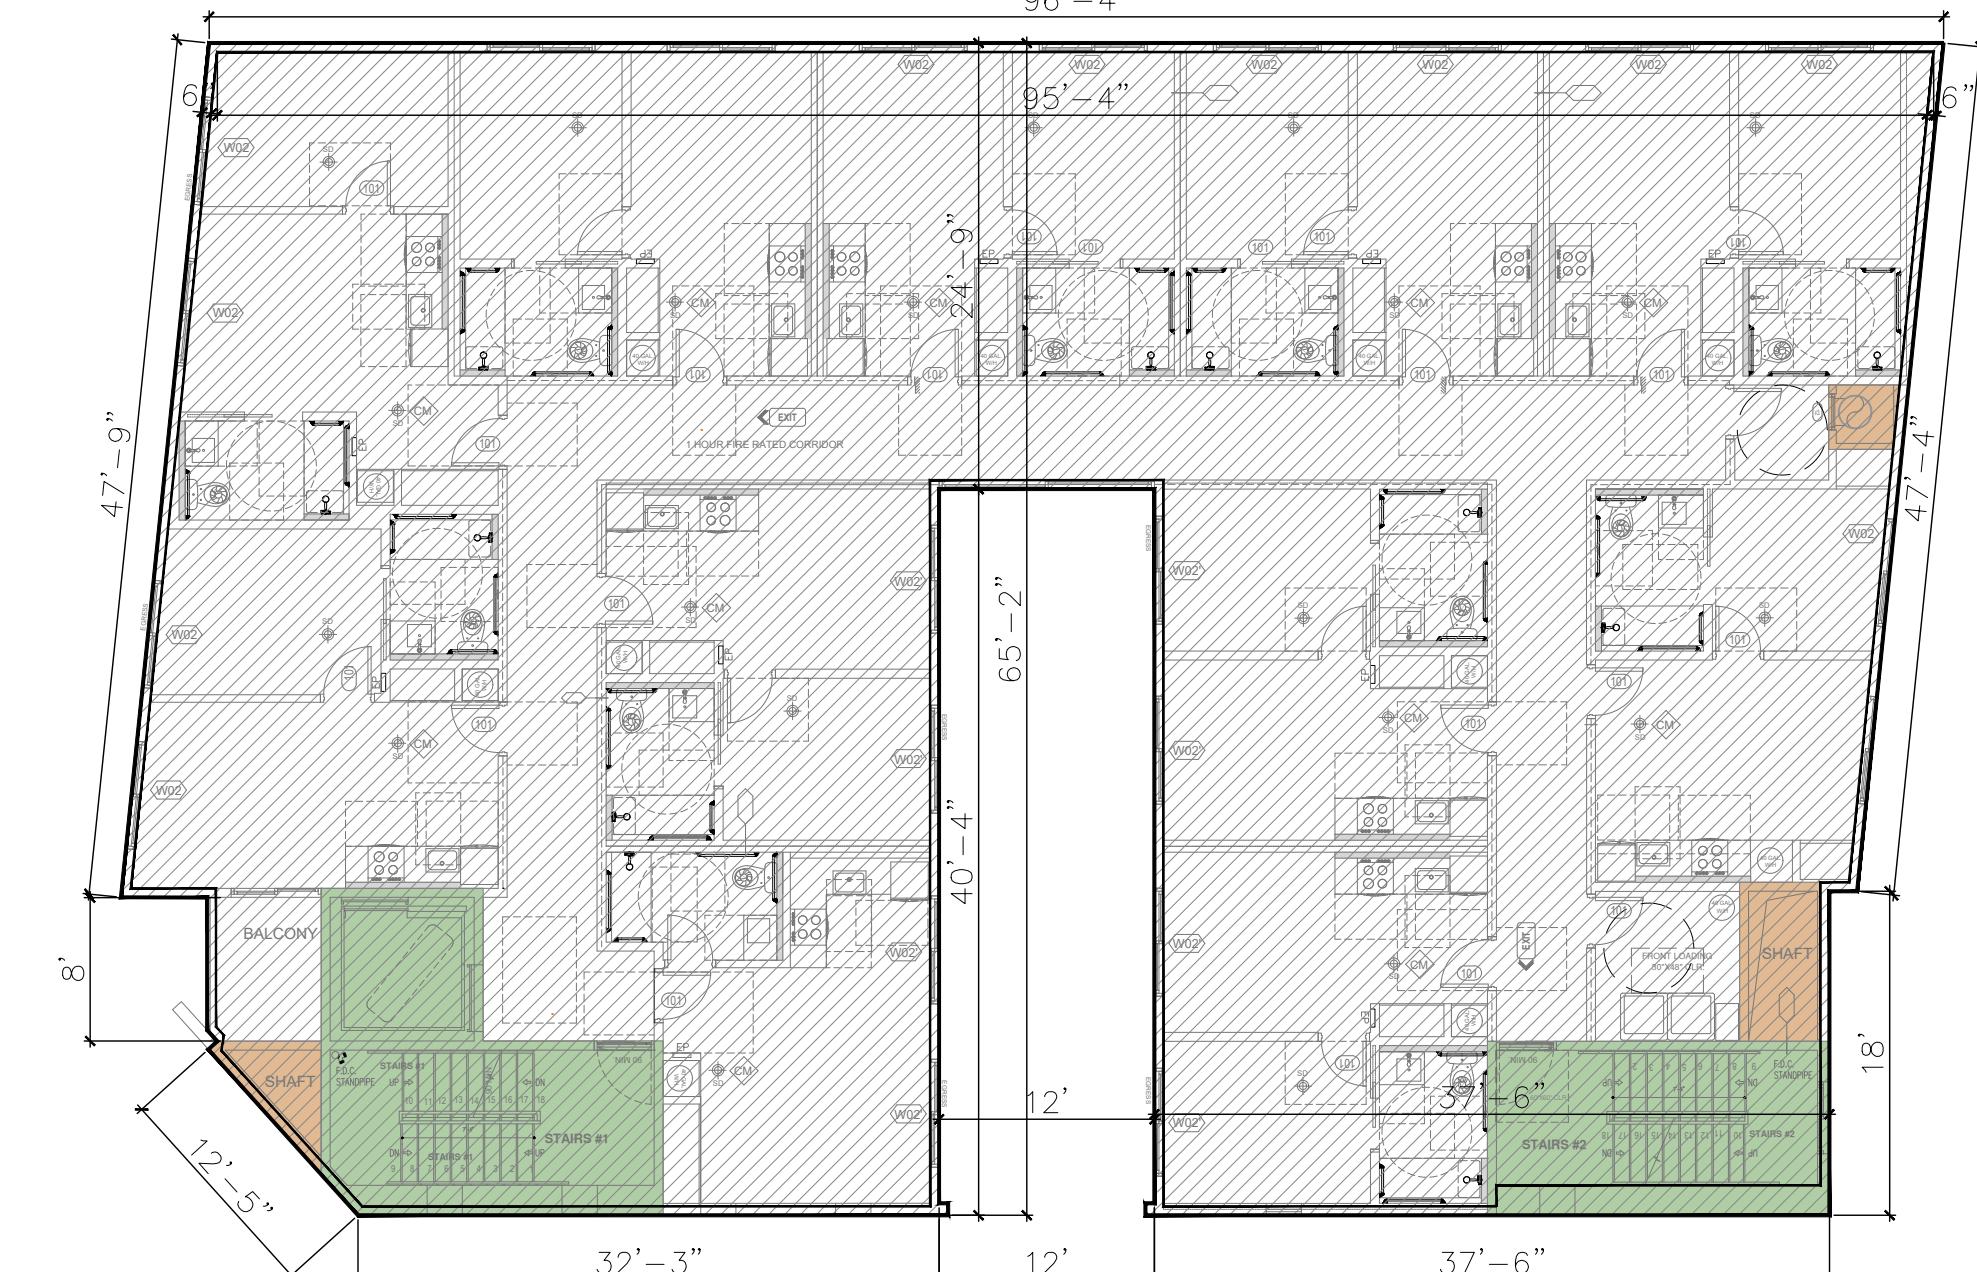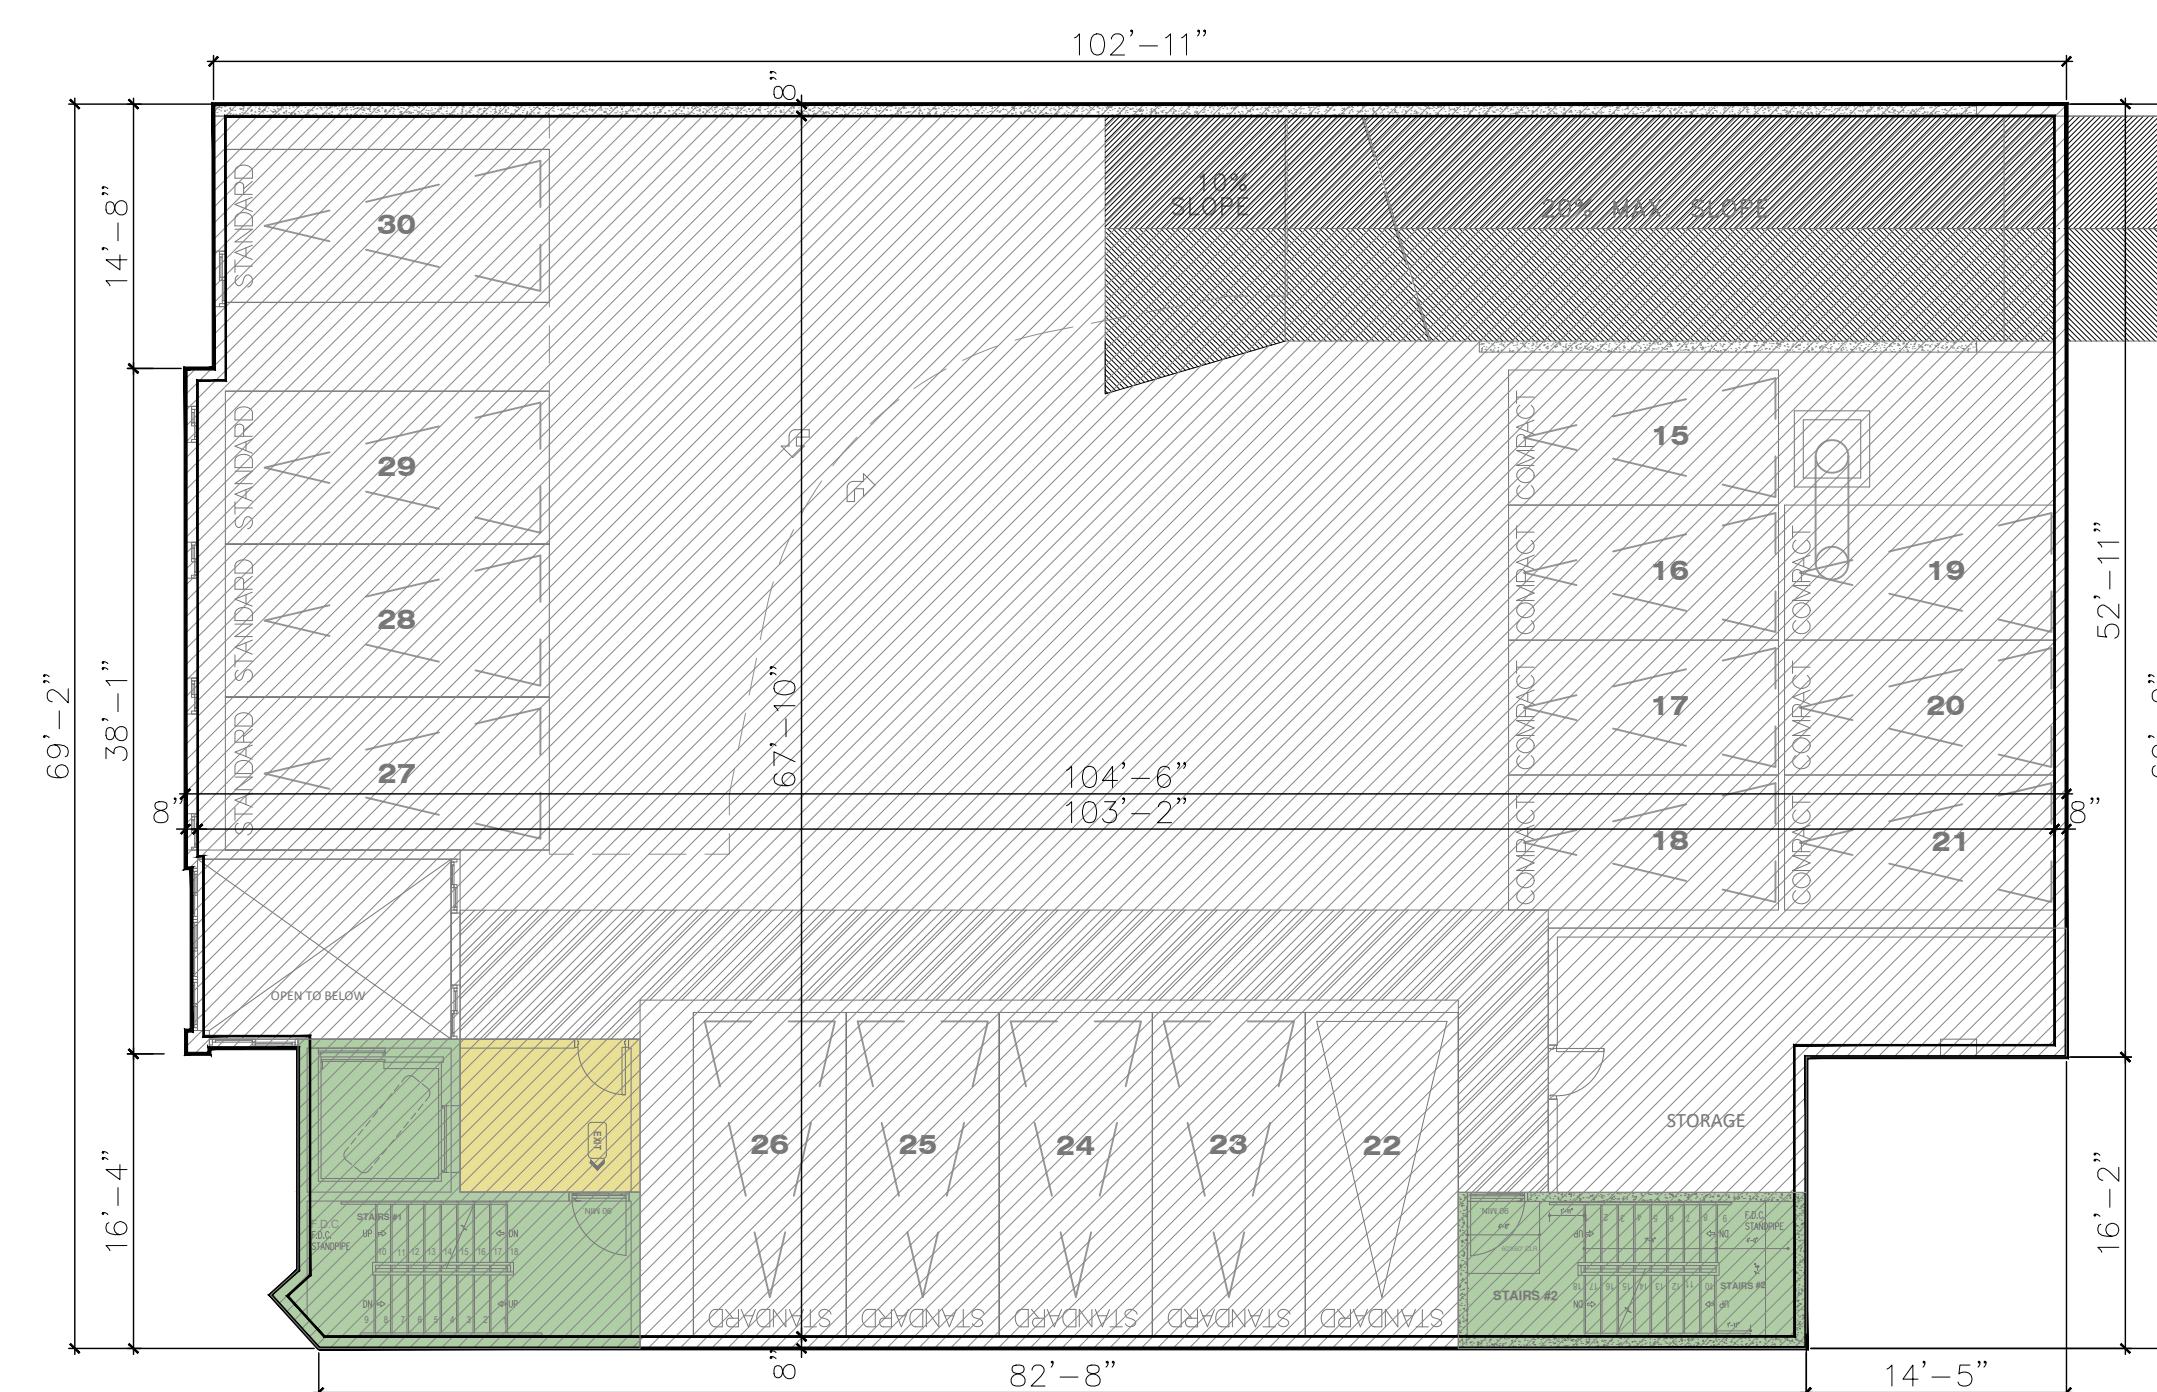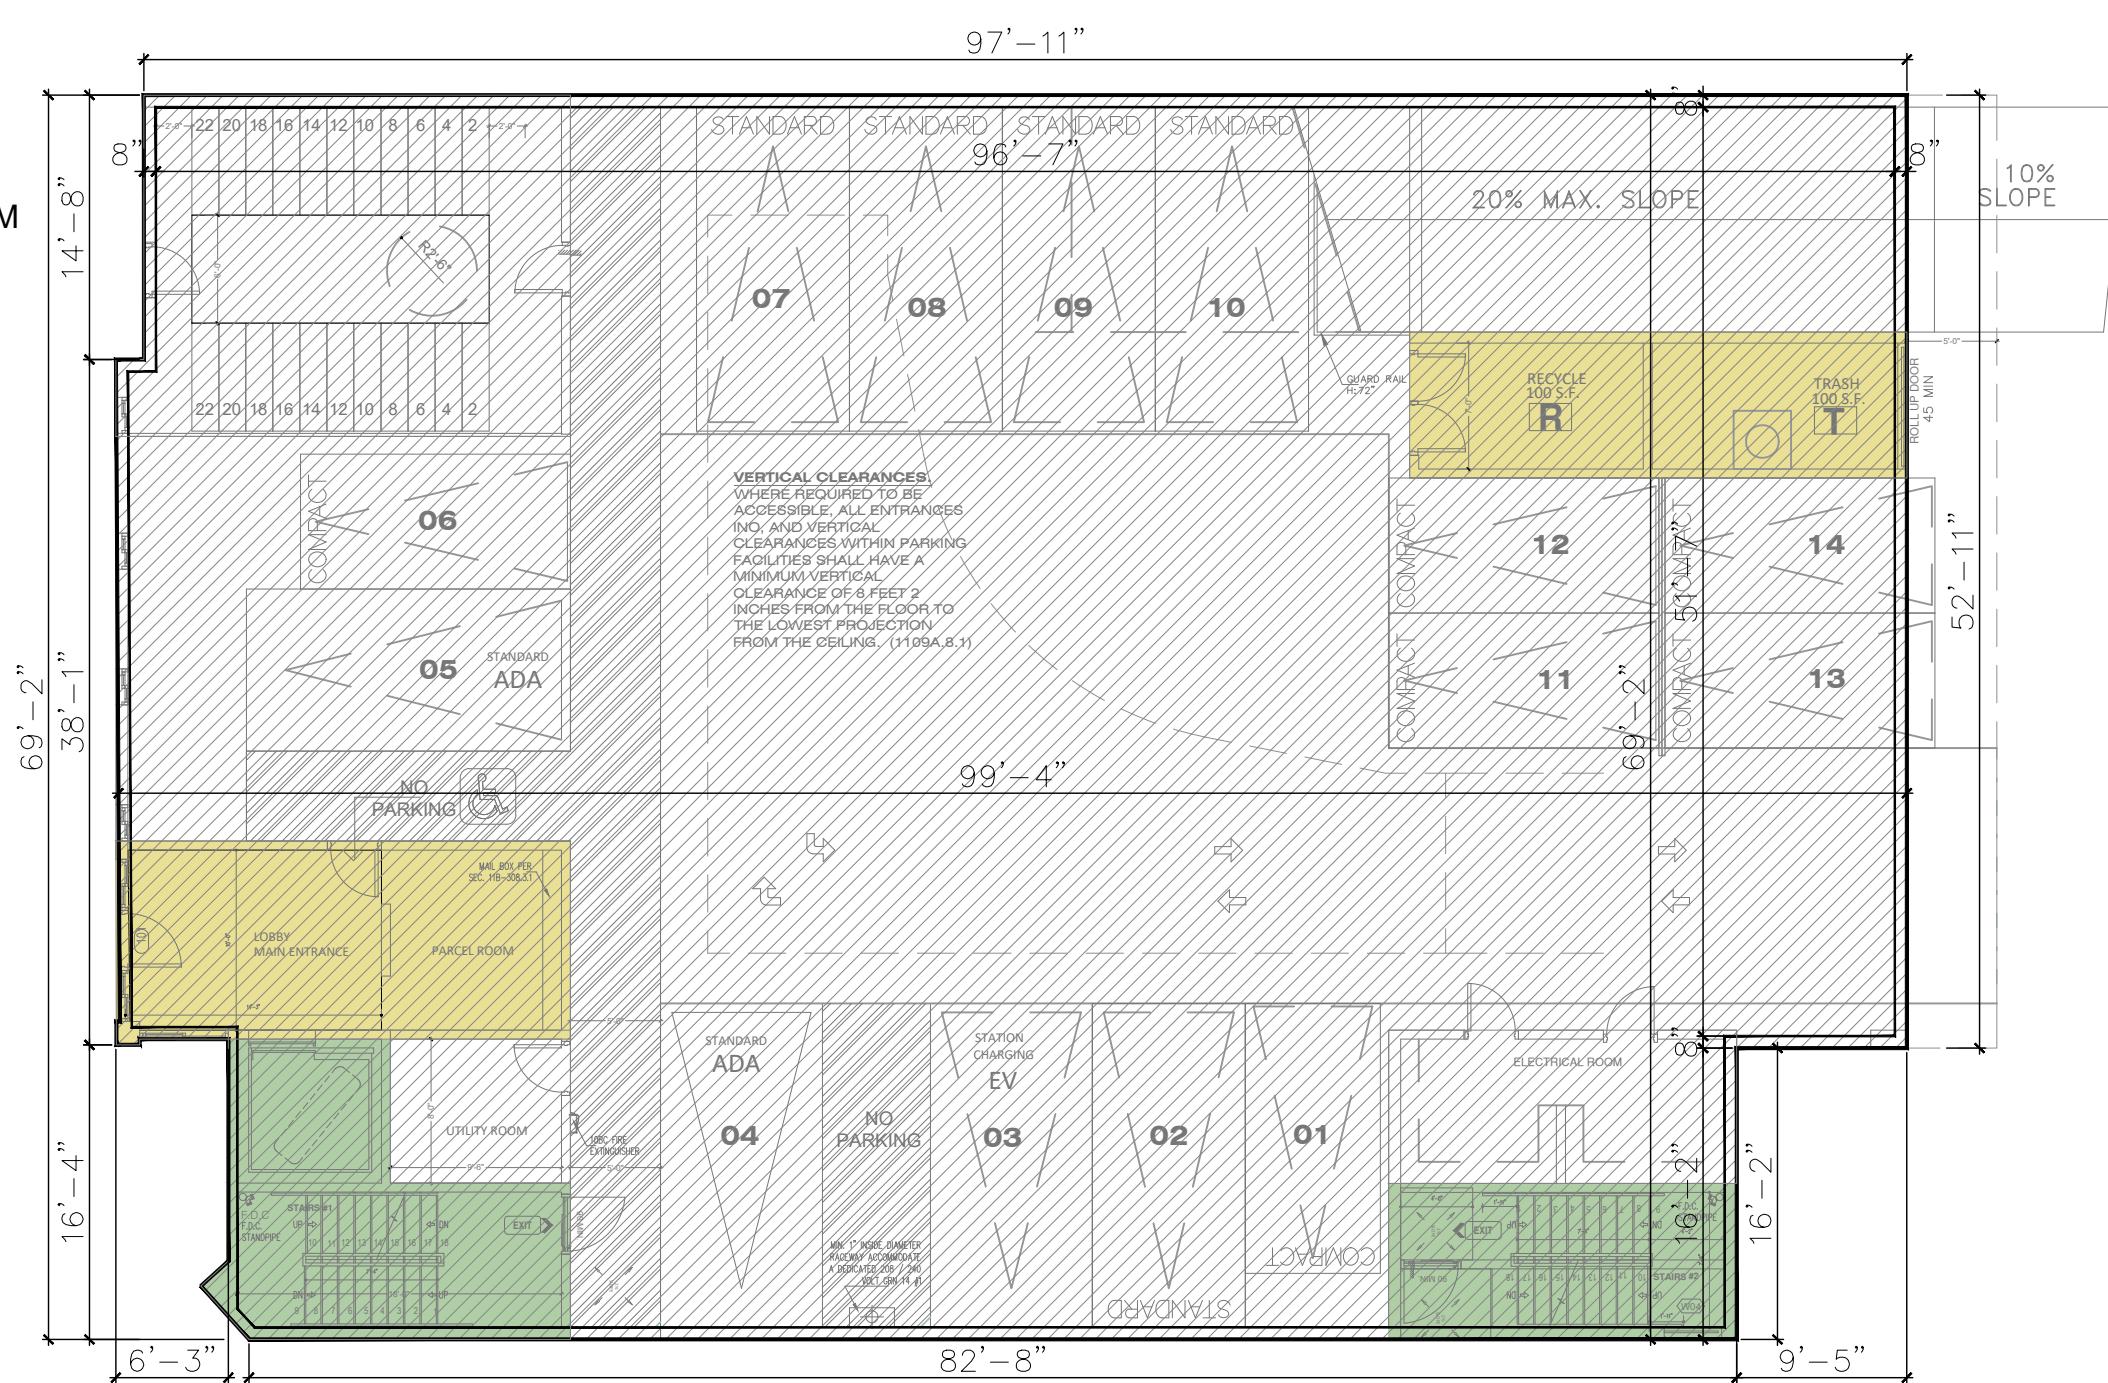

STORY	OCC.	USE	A	B	C	D	A-B-C	A-B-C-D
			GROSS AREA (OUT TO OUT BLDG) SQ.FT.	AREA: EXTERIOR WALLS SQ.FT.	AREA: VENT SHAFTS SQ.FT.	AREA: STAIRWAYS ELEVATOR SQ.FT.	BUILDING CODE FLOOR AREA SQ.FT.	ZONING CODE FLOOR AREA SQ.FT.
FIRST	S-2	PARKING	6,094					
	R-2	LOBBY,TRASH,RECYCLE	501	77			424	424
SECOND	S-2	PARKING	6,607					
	R-2	LOBBY(DOUBLE HEIGHT) ELEV. LOBBY	254	42			212	212
THIRD	R-2	RESIDENTIAL	5,645	221	82	404	5,342	4,938
FOURTH	R-2	RESIDENTIAL	5,645	221	82	404	5,342	4,938
FIFTH	R-2	RESIDENTIAL	5,645	221	82	404	5,342	4,938
SIXTH	R-2	RESIDENTIAL	5,645	221	82	404	5,342	4,938
SEVENTH	R-2	RESIDENTIAL	5,645	221	82	404	5,342	4,938
ROOF	R-2		404			404		
TOTAL	S-2		12,701					
	R-2		29,384				27,346	25,326

LADBS APPROVAL STAMP

NOTICE:
 THE DESIGNS SHOWN AND DESCRIBED HEREIN, INCLUDING ALL TECHNICAL DRAWINGS, GRAPHICS, AND MODELS THEREIN, ARE THE PROPERTY OF BEVERLY DESIGN. THEY ARE TO BE USED IN WHOLE OR IN PART WITHOUT THE WRITTEN PERMISSION OF BEVERLY DESIGN.
 ALL THESE DRAWINGS HAVE BEEN PREPARED TO DESCRIBE NEW WORK ONLY AND DO NOT REPRESENT AS-BUILT OR ACCURATE EXISTING CONDITIONS. THE DESIGNER IS NOT RESPONSIBLE IN ANY WAY THE ACCURACY OF THIS INFORMATION AND SHALL NOT BE RESPONSIBLE FOR DISCREPANCIES BETWEEN THIS DOCUMENT AND EXISTING CONDITIONS. THESE PLANS ARE THE PROPERTY OF BEVERLY DESIGN AND ARE AVAILABLE FOR LIMITED REVIEW AND EVALUATION AS 'INSTRUMENTS OF SERVICE' BY THE CLIENT, CONSULTANTS, CONTRACTORS, GOVERNMENT AGENCIES, VENDORS AND OFFICE PERSONNEL ONLY IN ACCORDANCE WITH THIS NOTICE. DO NOT SCALE OFF THESE DRAWINGS. ALL RIGHTS RESERVED COPYRIGHT, BEVERLY DESIGN

OWNER :
 8688 WEST PICO LLC
 PROJECT :
 8688 W Pico Blvd,
 Los Angeles, CA 90035

**FLOOR AREA
 CALCULATION**

REVISION:
 NO. _____ DATE _____ BY _____

SCALE :
 DRAWN : _____


DATE : December 25
 JOB NUMBER : _____

SHEET _____

A2.8

NOTICE:
THE DESIGNS SHOWN AND DESCRIBED
HEREIN, INCLUDING ALL TECHNICAL
DRAWINGS, GRAPHICS, AND MODELS
THESE ARE THE PROPERTY OF BEBERLY DESIGN
NOT BE COPIED, DUPLICATED, REUSED, OR
COMMERCIAL EXPLOITED IN WHOLE OR IN
PART WITHOUT THE WRITTEN PERMISSION OF
BEVERLY DESIGN.

ALL THESE DRAWINGS HAVE BEEN
PREPARED TO DESCRIBE NEW WORK ONLY
AND DO NOT REPRESENT AS-BUILT OR
ACCURATE EXISTING CONDITIONS. THE
DESIGNS ARE PROVIDED IN THIS WAY
THE ACCURACY OF THIS INFORMATION AND
SHALL NOT BE RESPONSIBLE FOR
DISCREPANCIES BETWEEN THIS DOCUMENT
AND EXISTING CONDITIONS. THESE PLANS ARE
NOT TO BE PROVIDED TO THE PUBLIC
ARE AVAILABLE FOR LIMITED REVIEW AND
EVALUATION AS 'INSTRUMENTS OF SERVICE'
BY THE CLIENT, CONSULTANTS,
CONTRACTORS, GOVERNMENT AGENCIES,
VENDORS AND OFFICE PERSONNEL ONLY IN
ACCORDANCE WITH THIS NOTICE. DO NOT
SCALE OFF THESE DRAWINGS. ALL RIGHTS
RESERVED COPYRIGHT, BEVERLY DESIGN

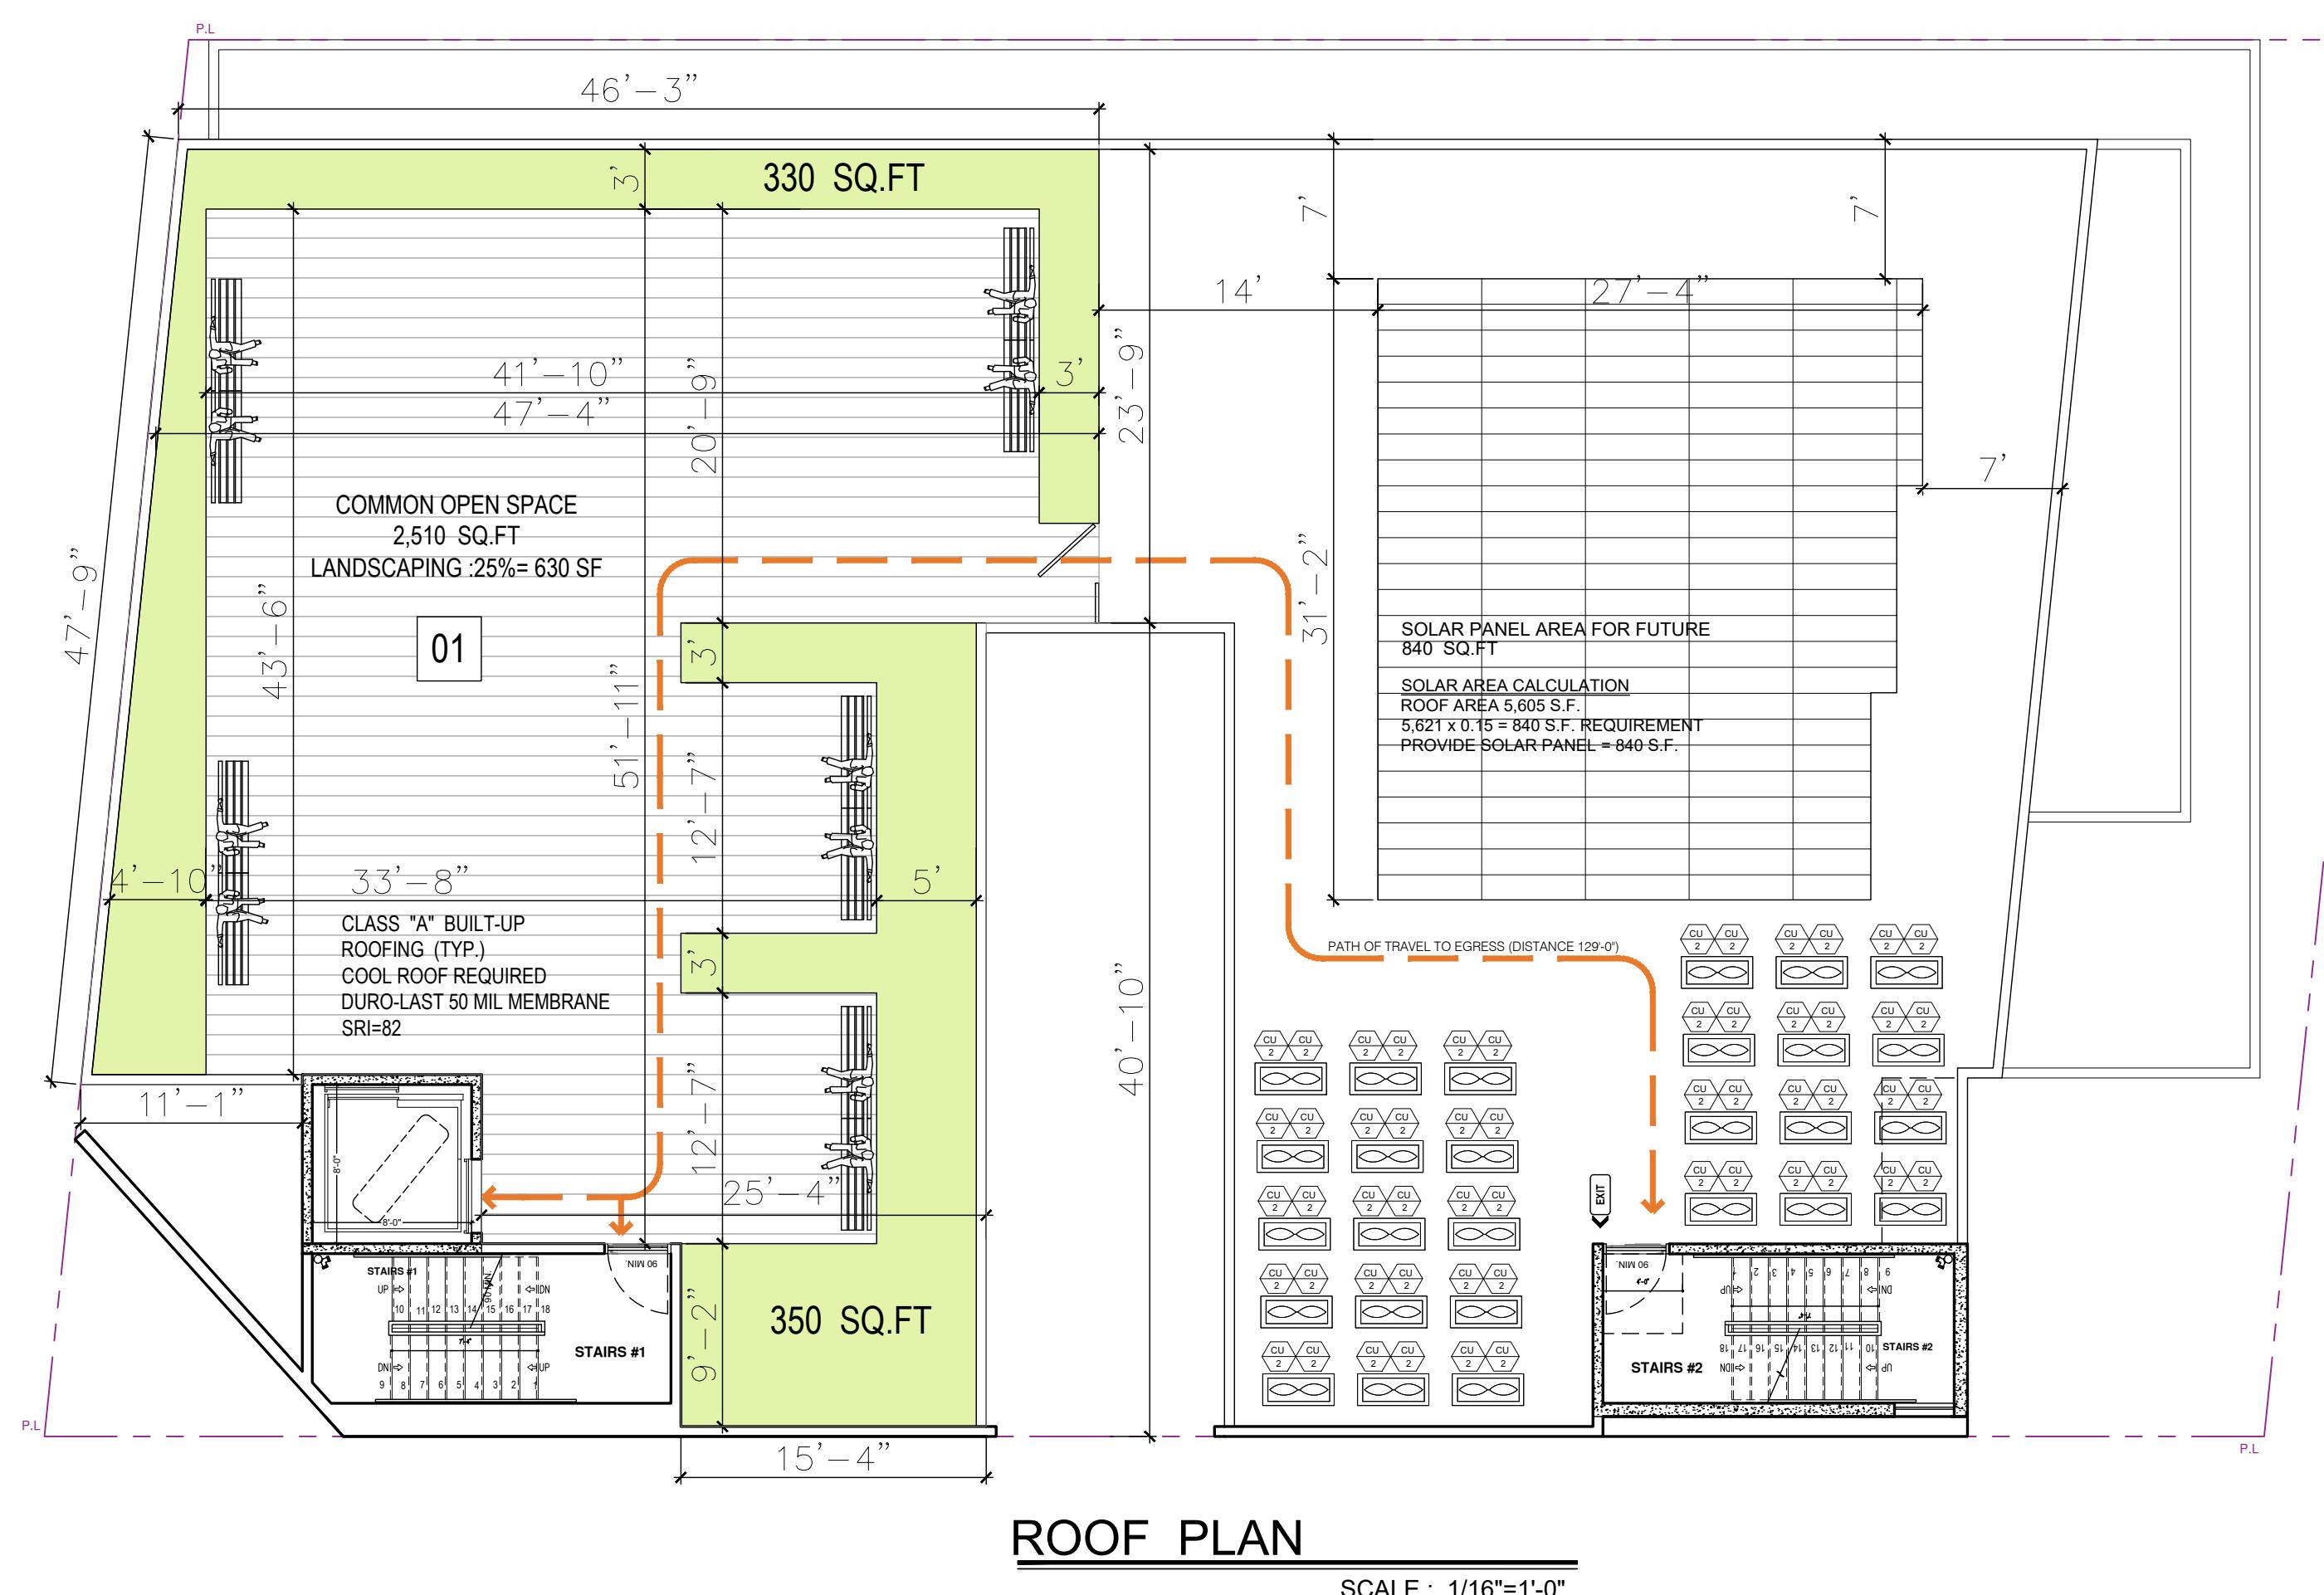

REQUIRED

NO. OF BEDROOMS	NO. OF HABITABLE ROOMS	QUANT.	OPEN SPACE
STUDIO	1	5	5 X 100 = 5,00
1	2	50	50 X 100 = 5,000
TOTAL			5,500 SQ.FT.

REQUESTED REDUCTION OF 50% IN THE OPEN SPACE

$$5,500 \times 50\% = 2,750 \text{ SQ.FT}$$

PROVIDED: 2,760 SQ.FT

PROVIDED

AREA DESCRIPTION	OPEN SPACE
BALCONY(5X50)	250 SQ.FT
ROOF DECK	2,510 SQ.FT
TOTAL	2,760 SQ.FT

OWNER :

8688 WEST PICO LLC

PROJECT :

8688 W Pico Blvd,
Los Angeles, CA 90035

SHEET TITLE:

**OPEN SPACE
DIAGRAM**

REVISION:
NO. DATE BY

SCALE :
DRAWN :

DATE : December 25
JOB NUMBER :

SHEET



01 AREA = 2,760 SQ.FT LANDSCAPING = 680 SQ.FT > 630 SQ.FT (25% MIN OF OPEN SPACE SHOULD BE LANDSCAPING *)

CALCULATION OF OCCUPANT LOAD ON ROOF:

01 AREA = 2,760 SQ.FT LANDSCAPING = 680 SQ.FT $2,760 - 680 = 2,080 / 15 = 139$

TOTAL OCCUPANT LOAD ON THE ROOF = 139

70 OCCUPANTS PER EXIT

$70 \times 0.3 = 21" \rightarrow \text{PROVIDE } 42" \text{ WIDTH} > 21" \text{ MINIMUM PER OCCUPANTS}$



A2.8'

NOTICE:
 THE DESIGNS SHOWN AND DESCRIBED
 HEREIN, INCLUDING ALL TECHNICAL
 DRAWINGS, GRAPHICS, AND MODELS
 THEREOF, ARE PROPRIETARY AND SHALL NOT
 BE COPIED, REPRODUCED, USED OR
 COMMERCIALIZED, EXPLOITED IN WHOLE OR IN
 PART WITHOUT THE WRITTEN PERMISSION OF
 BEVERLY DESIGN.

THE DOCUMENTS
 PREPARED TO DESCRIBE NEW WORK ONLY
 AND DO NOT REPRESENT AS-BUILT OR
 ACCURATE EXISTING CONDITIONS. THE
 DESIGNER DOES NOT WARRANT IN ANY WAY
 THE ACCURACY OF THE INFORMATION AND
 SHALL NOT BE RESPONSIBLE FOR
 DISCREPANCIES BETWEEN THIS DOCUMENT
 AND EXISTING CONDITIONS. THESE PLANS ARE
 THE PROPERTY OF BEVERLY DESIGN AND
 ARE AVAILABLE FOR LIMITED REVIEW AND
 EVALUATION AS INSTRUMENTS OF SERVICE
 BY THE CLIENT, CONSULTANTS,
 CONTRACTORS, GOVERNMENT AGENCIES,
 VENDORS, OR OFFICE PERSONNEL ONLY IN
 ACCORDANCE WITH THIS NOTICE. DO NOT
 SCALE OFF THESE DRAWINGS. ALL RIGHTS
 RESERVED COPYRIGHT, BEVERLY DESIGN

GLAZING CALCULATION

FLOOR	TOTAL SQ.FT	GLAZING REQUIRED PERCENT	GLAZING REQUIRED	GLAZING PROPOSED	TOTAL GLAZING
FIRST FLOOR	527 SQ.FT	30%	158 SQ.FT	169 SQ.FT	GLASS: (18'X4)+97'=169'
2ND FLOOR	527 SQ.FT	20%	106 SQ.FT	108 SQ.FT	GLASS: (12'X4)+60'=108'
3RD FLOOR	475 SQ.FT	20%	95 SQ.FT	168 SQ.FT	GLASS: (42'X4)=168'
4TH FLOOR	475 SQ.FT	20%	95 SQ.FT	168 SQ.FT	GLASS: (42'X4)=168'
5TH FLOOR	475 SQ.FT	20%	95 SQ.FT	168 SQ.FT	GLASS: (42'X4)=168'
6TH FLOOR	475 SQ.FT	20%	95 SQ.FT	168 SQ.FT	GLASS: (42'X4)=168'
7TH FLOOR	475 SQ.FT	20%	95 SQ.FT	168 SQ.FT	GLASS: (42'X4)=168'

ALLOWABLE HEIGHT : UNLIMITED


1 NORTH ELEVATION

SCALE: 1/8"=1'-0"

NOTES

- 7/8" STUCCO OVER PAPER BACK WIRE MESH PROVIDE 2-LAYERS OF GRADE "D" PAPER OVER PLYWD.
- RECESSED ALL DOORS AND WINDOWS NO LESS THAN 3".
- EXTERIOR LIGHTING TO BE SHIELDED.
- WINDOWS AND BALCONY DOORS TO BE VINYL MATERIAL GRAY COLOR.
- PROVIDE GRAFFITI-MELT ANTI-GRAFFITI COATING BY GENESIS AT THE FIRST 9FT, MEASURED FROM GRADE AT EXTERIOR WALLS AND DOORS. LARR # RR25042-T
- ALL PLASTER FINISH SHALL BE 7/8" THK. SMOOTH TROWELL UNLESS NOTED OTHERWISE.
- 30" PARAPETS SHALL BE PROVIDED ON EXTERIOR WALLS.(CBC 705.11)

NOTE :
 All downspouts to drain into planter. See civil plans for continuation
 All roof runoff to drain to planter.


LEGEND

- 1 CORRUGATED METAL HORIZONTAL (DARK GRAY)
- 2 COMPOSITE WOOD
- 3 SMOOTH STUCCO (WHITE)
- 4 SMOOTH STUCCO (GRAY)
- 5 PORCELAIN TILE
- 6 METAL AWNING
- 7 LIGHTING TO BE SHIELDED
- 8 REVEAL
- 9 PROPERTY LINE (PL)

GLAZING CALCULATION

FLOOR	TOTAL SQ.FT	GLAZING REQUIRED PERCENT	GLAZING REQUIRED	GLAZING PROPOSED	TOTAL GLAZING
FIRST FLOOR	826 SQ.FT	30%	248 SQ.FT	260 SQ.FT	GLASS: (65'X4)=260'
2ND FLOOR	826 SQ.FT	20%	166 SQ.FT	180 SQ.FT	GLASS: (45'X4)=180'
3RD FLOOR	826 SQ.FT	20%	166 SQ.FT	180 SQ.FT	GLASS: (20'X4)+100'=180'
4TH FLOOR	826 SQ.FT	20%	166 SQ.FT	180 SQ.FT	GLASS: (20'X4)+100'=180'
5TH FLOOR	826 SQ.FT	20%	166 SQ.FT	180 SQ.FT	GLASS: (20'X4)+100'=180'
6TH FLOOR	826 SQ.FT	20%	166 SQ.FT	180 SQ.FT	GLASS: (20'X4)+100'=180'
7TH FLOOR	826 SQ.FT	20%	166 SQ.FT	180 SQ.FT	GLASS: (20'X4)+100'=180'

ALLOWABLE HEIGHT : UNLIMITED

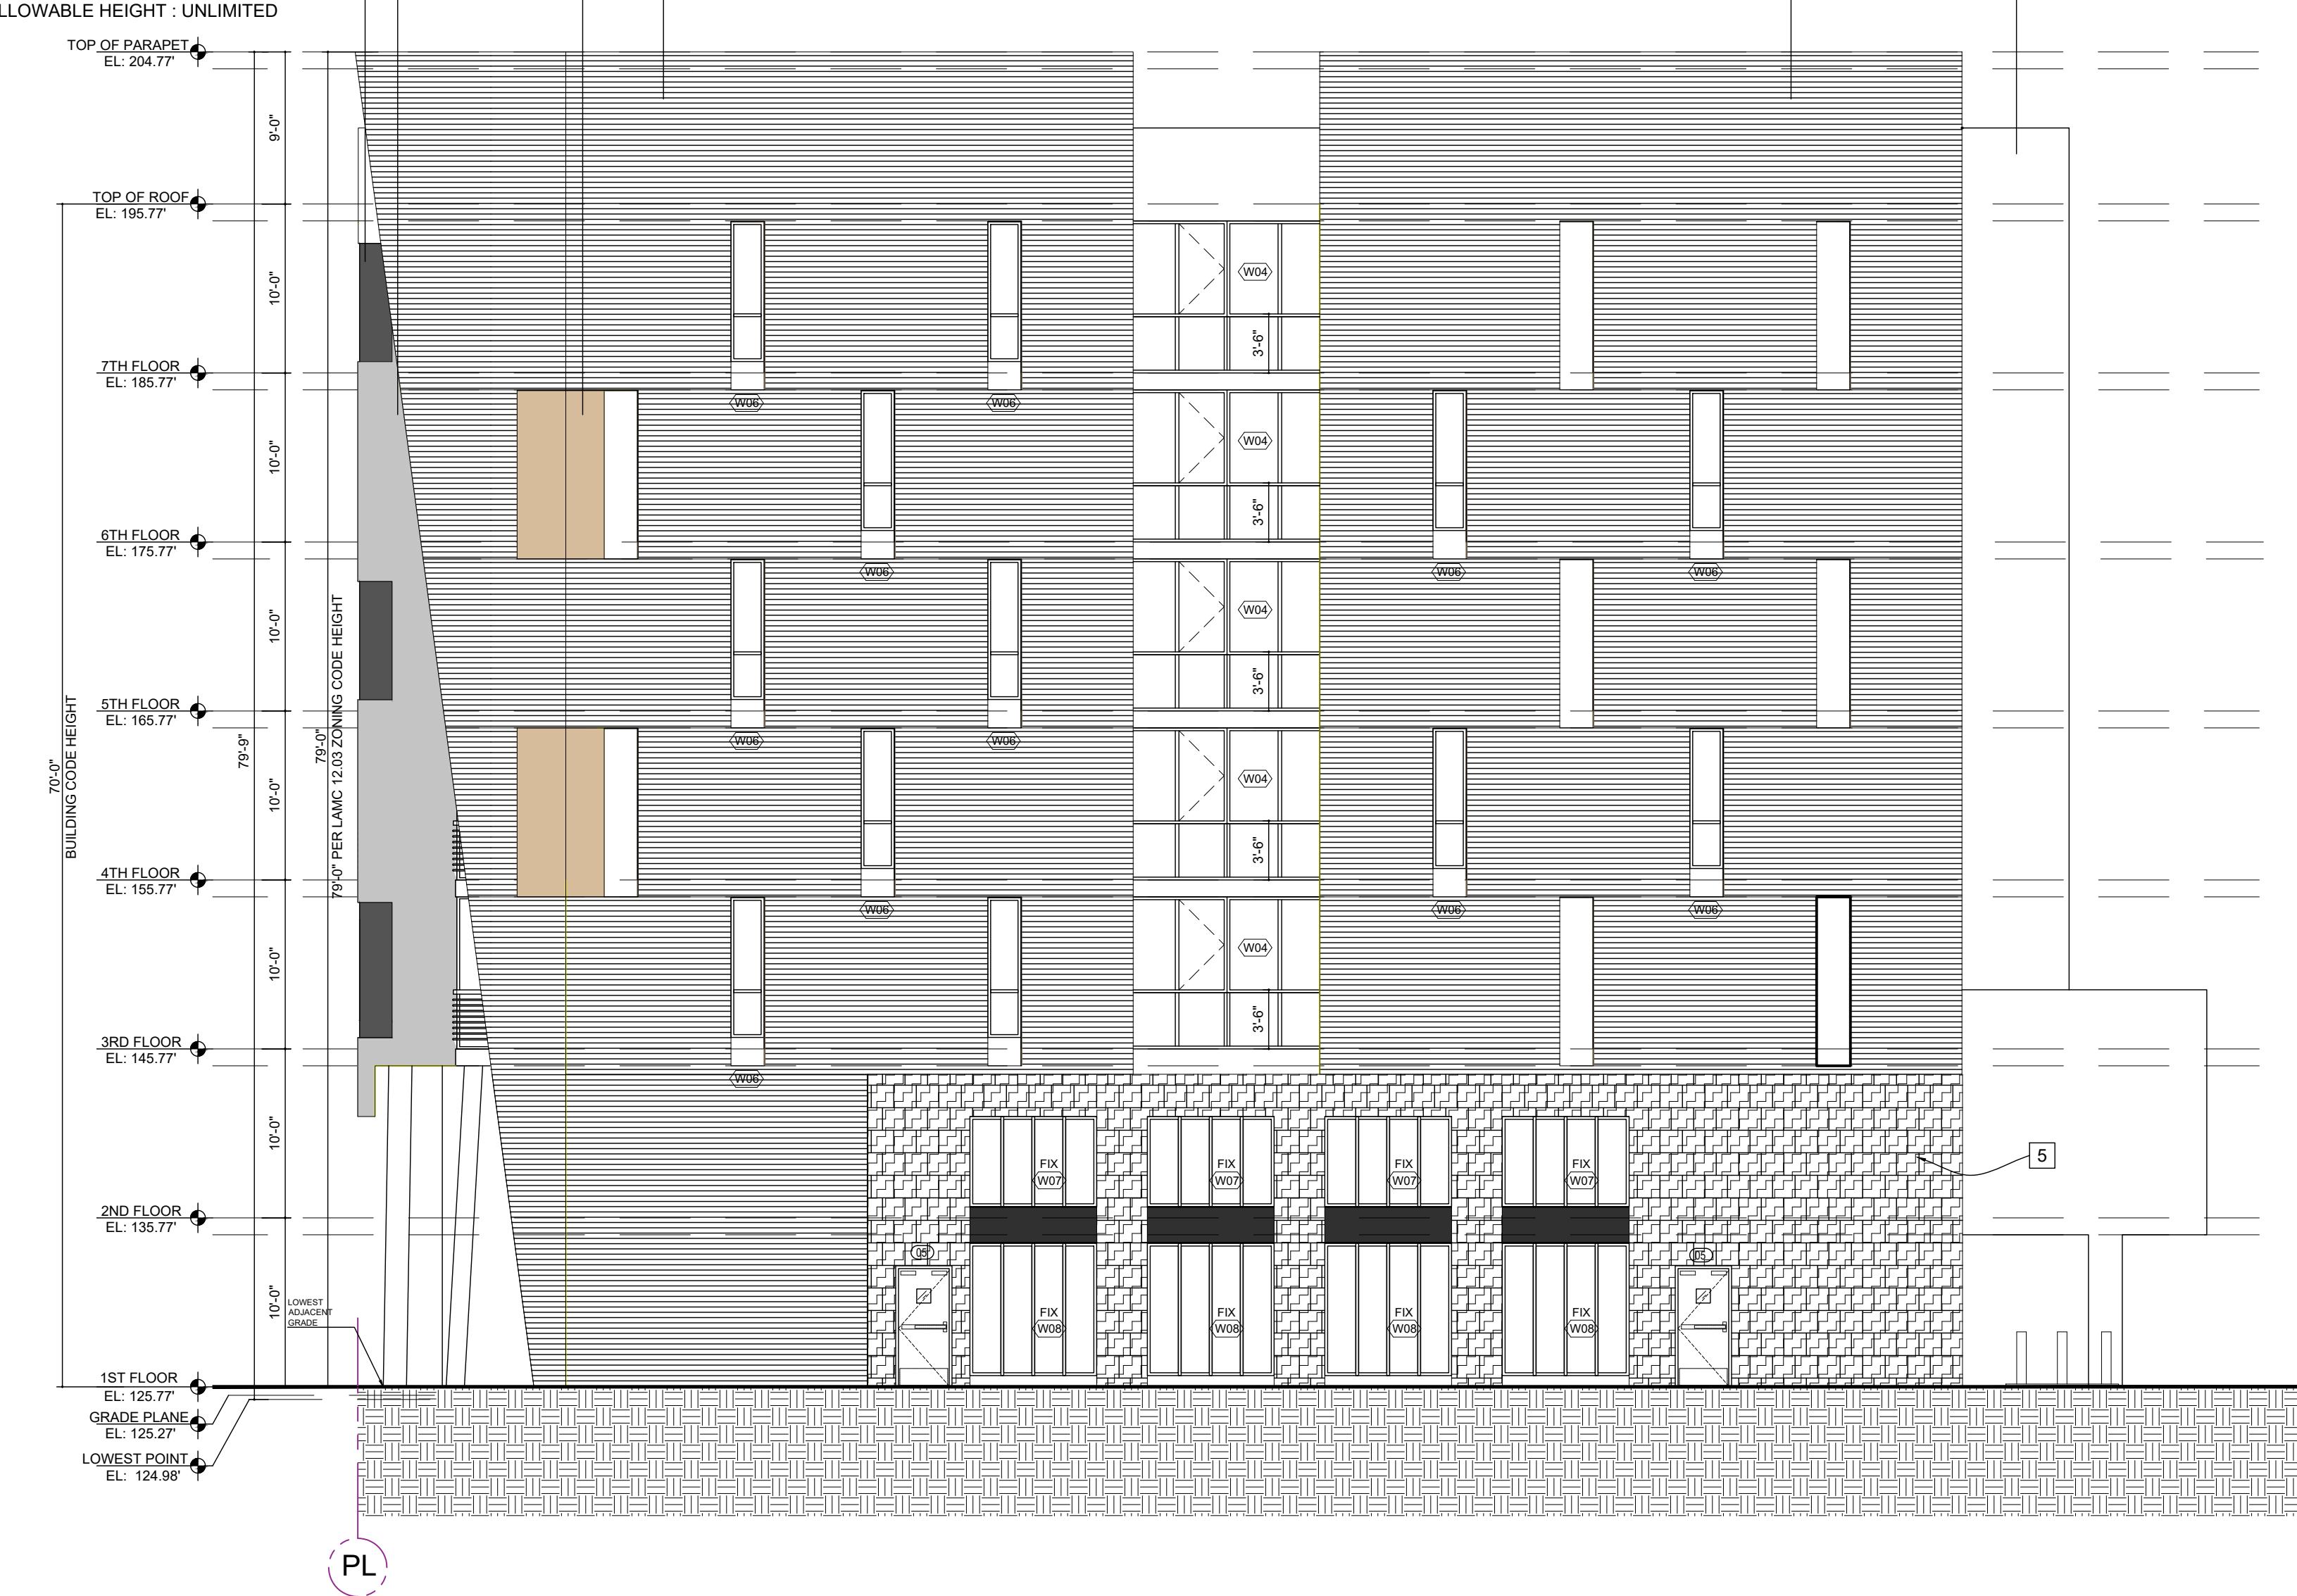
1 WEST ELEVATION

SCALE: 1/8"=1'-0"

OWNER :

8688 WEST PICO LLC

PROJECT :

 8688 W Pico Blvd,
 Los Angeles, CA 90035

SHEET TITLE:

ELEVATION

REVISION:

NO. - DATE - BY -


SCALE : DRAWN :

 DATE : December 25
 JOB NUMBER :

SHEET

A3.0

ALLOWABLE HEIGHT : UNLIMITED

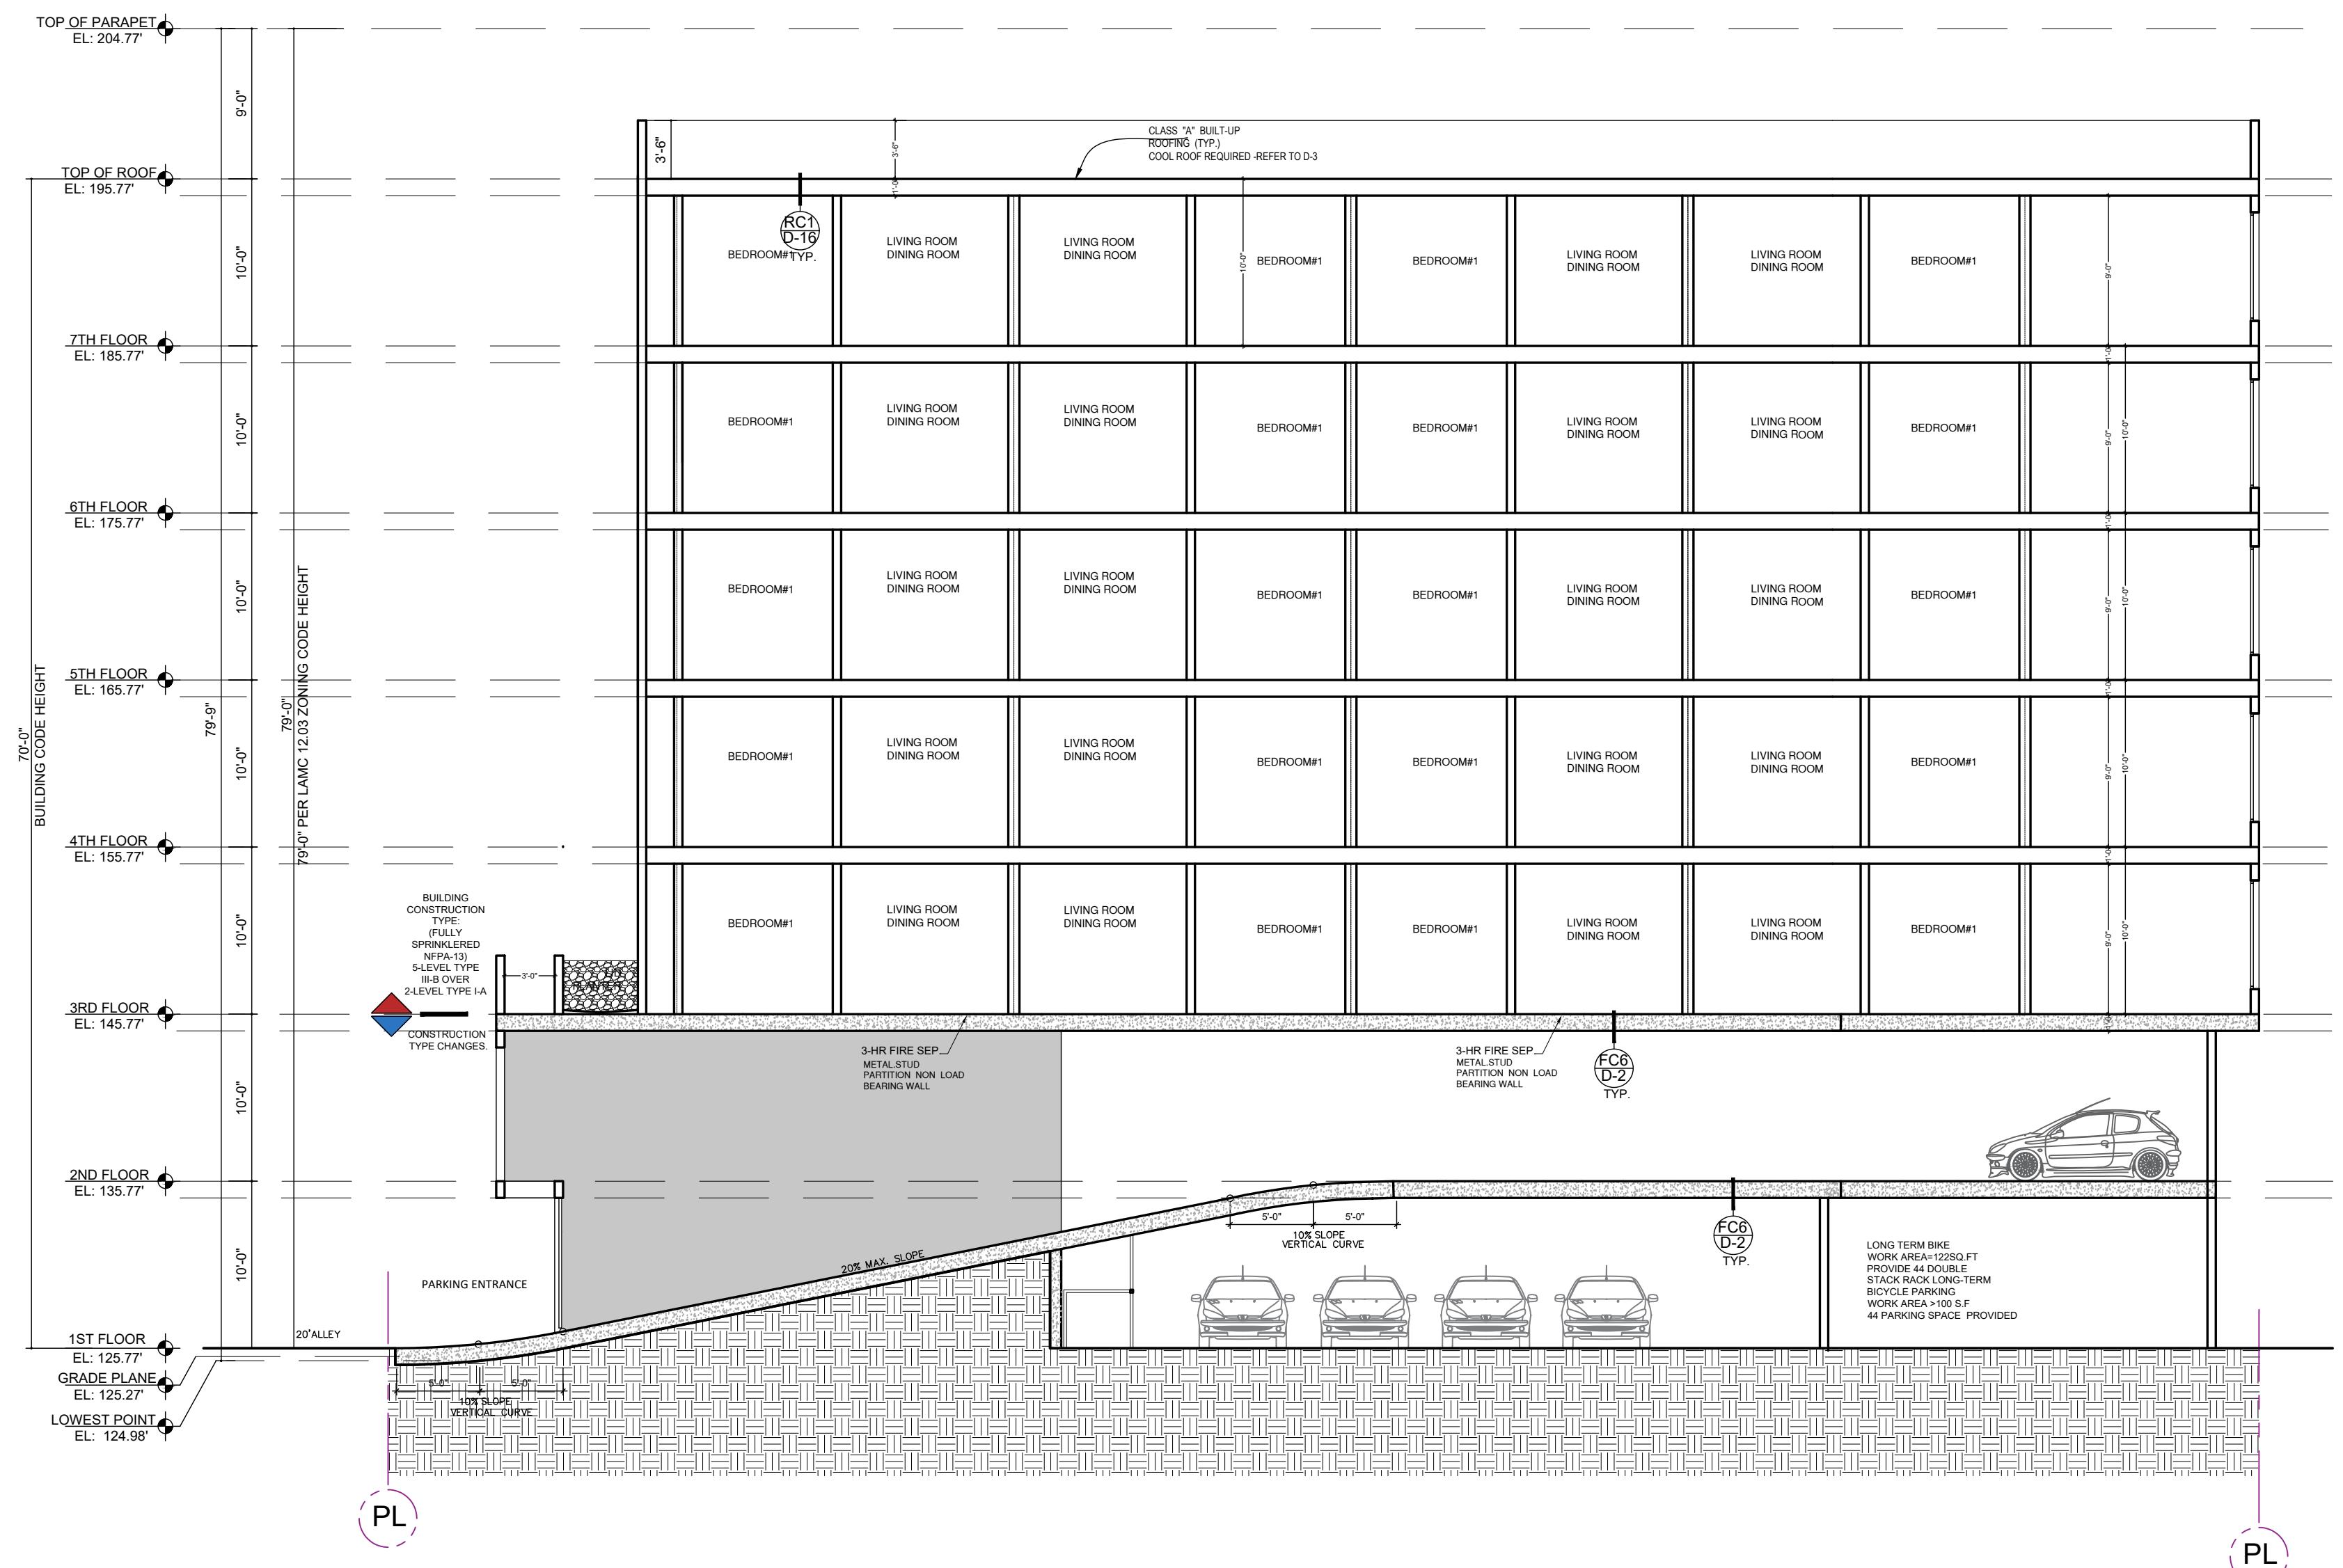

1 SECTION - A

SCALE: 1/8"=1'-0"

BUILDING SECTION GENERAL NOTES

1. THESE BUILDING SECTIONS ARE PROVIDED TO ILLUSTRATE THE DESIGNERURAL RELATIONSHIPS BETWEEN STRUCTURAL ELEMENTS, INTERIOR VOLUME CONFIGURATIONS AND BUILDING PROFILES. REFER TO THE STRUCTURAL PLANS AND TRUSS MANUFACTURER'S PLANS AND CALCULATIONS FOR ALL FRAMING AND TRUSS INFORMATION.
2. FIRE-RATED WALLS, FLOOR/CEILING AND ROOF/CEILING ASSEMBLIES MAY VARY BASED ON THE ACTUAL LOCATION OF A UNIT WITHIN THE BUILDING. SEE COMPOSITE BUILDING PLANS AND CONSTRUCTION NOTES FOR ADDITIONAL INFORMATION.
3. ALL SHAFTS AND VERTICAL OPENINGS SHALL BE PROTECTED PER CBC SECTION 710.8, 711 AND DETAILS ON SHEETS A8.60, A8.61 AND A8.62.
4. REFER TO SHEETS A0.10 FOR RATED WALL SUMMARY AND FIRE RESISTANCE DESIGN SCHEDULE.
5. 30' PARAPETS SHALL BE PROVIDED ON EXTERIOR WALLS TYP. (CBC 705.11)

NOTICE:
THE DESIGNS SHOWN AND DESCRIBED
HEREIN, INCLUDING ALL TECHNICAL
DRAWINGS, GRAPHICS, AND MODELS
HEREIN, ARE THE PROPERTY AND SHALL
NOT BE COPIED, DUPLICATED, REPRODUCED
OR
COMMERCIAL EXPLOITED IN WHOLE OR IN
PART WITHOUT THE WRITTEN PERMISSION OF
BEVERLY DESIGN
ALL THESE DOCUMENTS HAVE BEEN
PREPARED TO DESCRIBE NEW WORK ONLY
AND DO NOT REPRESENT AS-BUILT OR
ACCURATE EXISTING CONDITIONS. THE
DESIGNER IS NOT RESPONSIBLE FOR THE
ACCURACY OF THIS INFORMATION AND
SHALL NOT BE RESPONSIBLE FOR
DISCREPANCIES BETWEEN THIS DOCUMENT
AND EXISTING CONDITIONS. THESE PLANS ARE
THE PROPERTY OF THE DESIGNER AND
ARE AVAILABLE FOR LIMITED REVIEW AND
EVALUATION AS 'INSTRUMENTS OF SERVICE'
BY THE CLIENT, CONSULTANTS,
CONTRACTORS, SUBCONTRACTORS, VENDORS
AND OFFICE PERSONNEL ONLY IN
ACCORDANCE WITH THIS NOTICE. DO NOT
SCALE OFF THESE DRAWINGS. ALL RIGHTS
RESERVED COPYRIGHT, BEVERLY DESIGN

OWNER :

8688 WEST PICO LLC

PROJECT :

8688 W Pico Blvd,
Los Angeles, CA 90035

SHEET TITLE:

SECTION - A

REVISION:		
NO.	DATE	BY

SCALE :
DRAWN :
DATE : December 25
JOB NUMBER :

SHEET

A4.0

NOTICE:
THE DESIGNS SHOWN AND DESCRIBED
HEREIN, INCLUDING ALL TECHNICAL
DRAWINGS, GRAPHICS, AND MODELS
HEREOF, ARE PROPRIETARY AND SHALL NOT
BE COPIED, DUPLICATED, REUSED OR
COMMERCIALY EXPLOITED IN WHOLE OR IN
PART WITHOUT THE WRITTEN PERMISSION OF
BEVERLY DESIGN.
ALL THESE DOCUMENTS HAVE BEEN
PREPARED TO DESCRIBE NEW WORK ONLY
AND DO NOT REPRESENT AS-BUILT OR
ACCURATE EXISTING CONDITIONS. THE
DESIGNER DOES NOT WARRANT IN ANY WAY
THE ACCURACY OF THIS INFORMATION AND
SHALL NOT BE RESPONSIBLE FOR
DISCREPANCIES BETWEEN THIS DOCUMENT
AND EXISTING CONDITIONS. THESE PLANS ARE
THE SOLE PROPERTY OF THE DESIGNER AND
ARE AVAILABLE FOR LIMITED REVIEW AND
EVALUATION AS 'INSTRUMENTS OF SERVICE'
BY THE CLIENT, CONSULTANTS,
CONTRACTORS, GOVERNING AGENCIES,
DRAFTERS AND OFFICE PERSONNEL ONLY IN
ACCORDANCE WITH THIS NOTICE. DO NOT
SELL OFF THESE DRAWINGS. ALL RIGHTS
SERVED COPYRIGHT, BEVERLY DESIGN

OWNER :

8688 WEST PICO LLC

8688 W Pico Blvd,
Los Angeles, CA 90035

SHEET TITLE:

SECTION - B


REVISION:
NO. DATE BY

SCALE :
DRAWN :

DATE : December 25
JOB NUMBER :

SHEET

A4.1

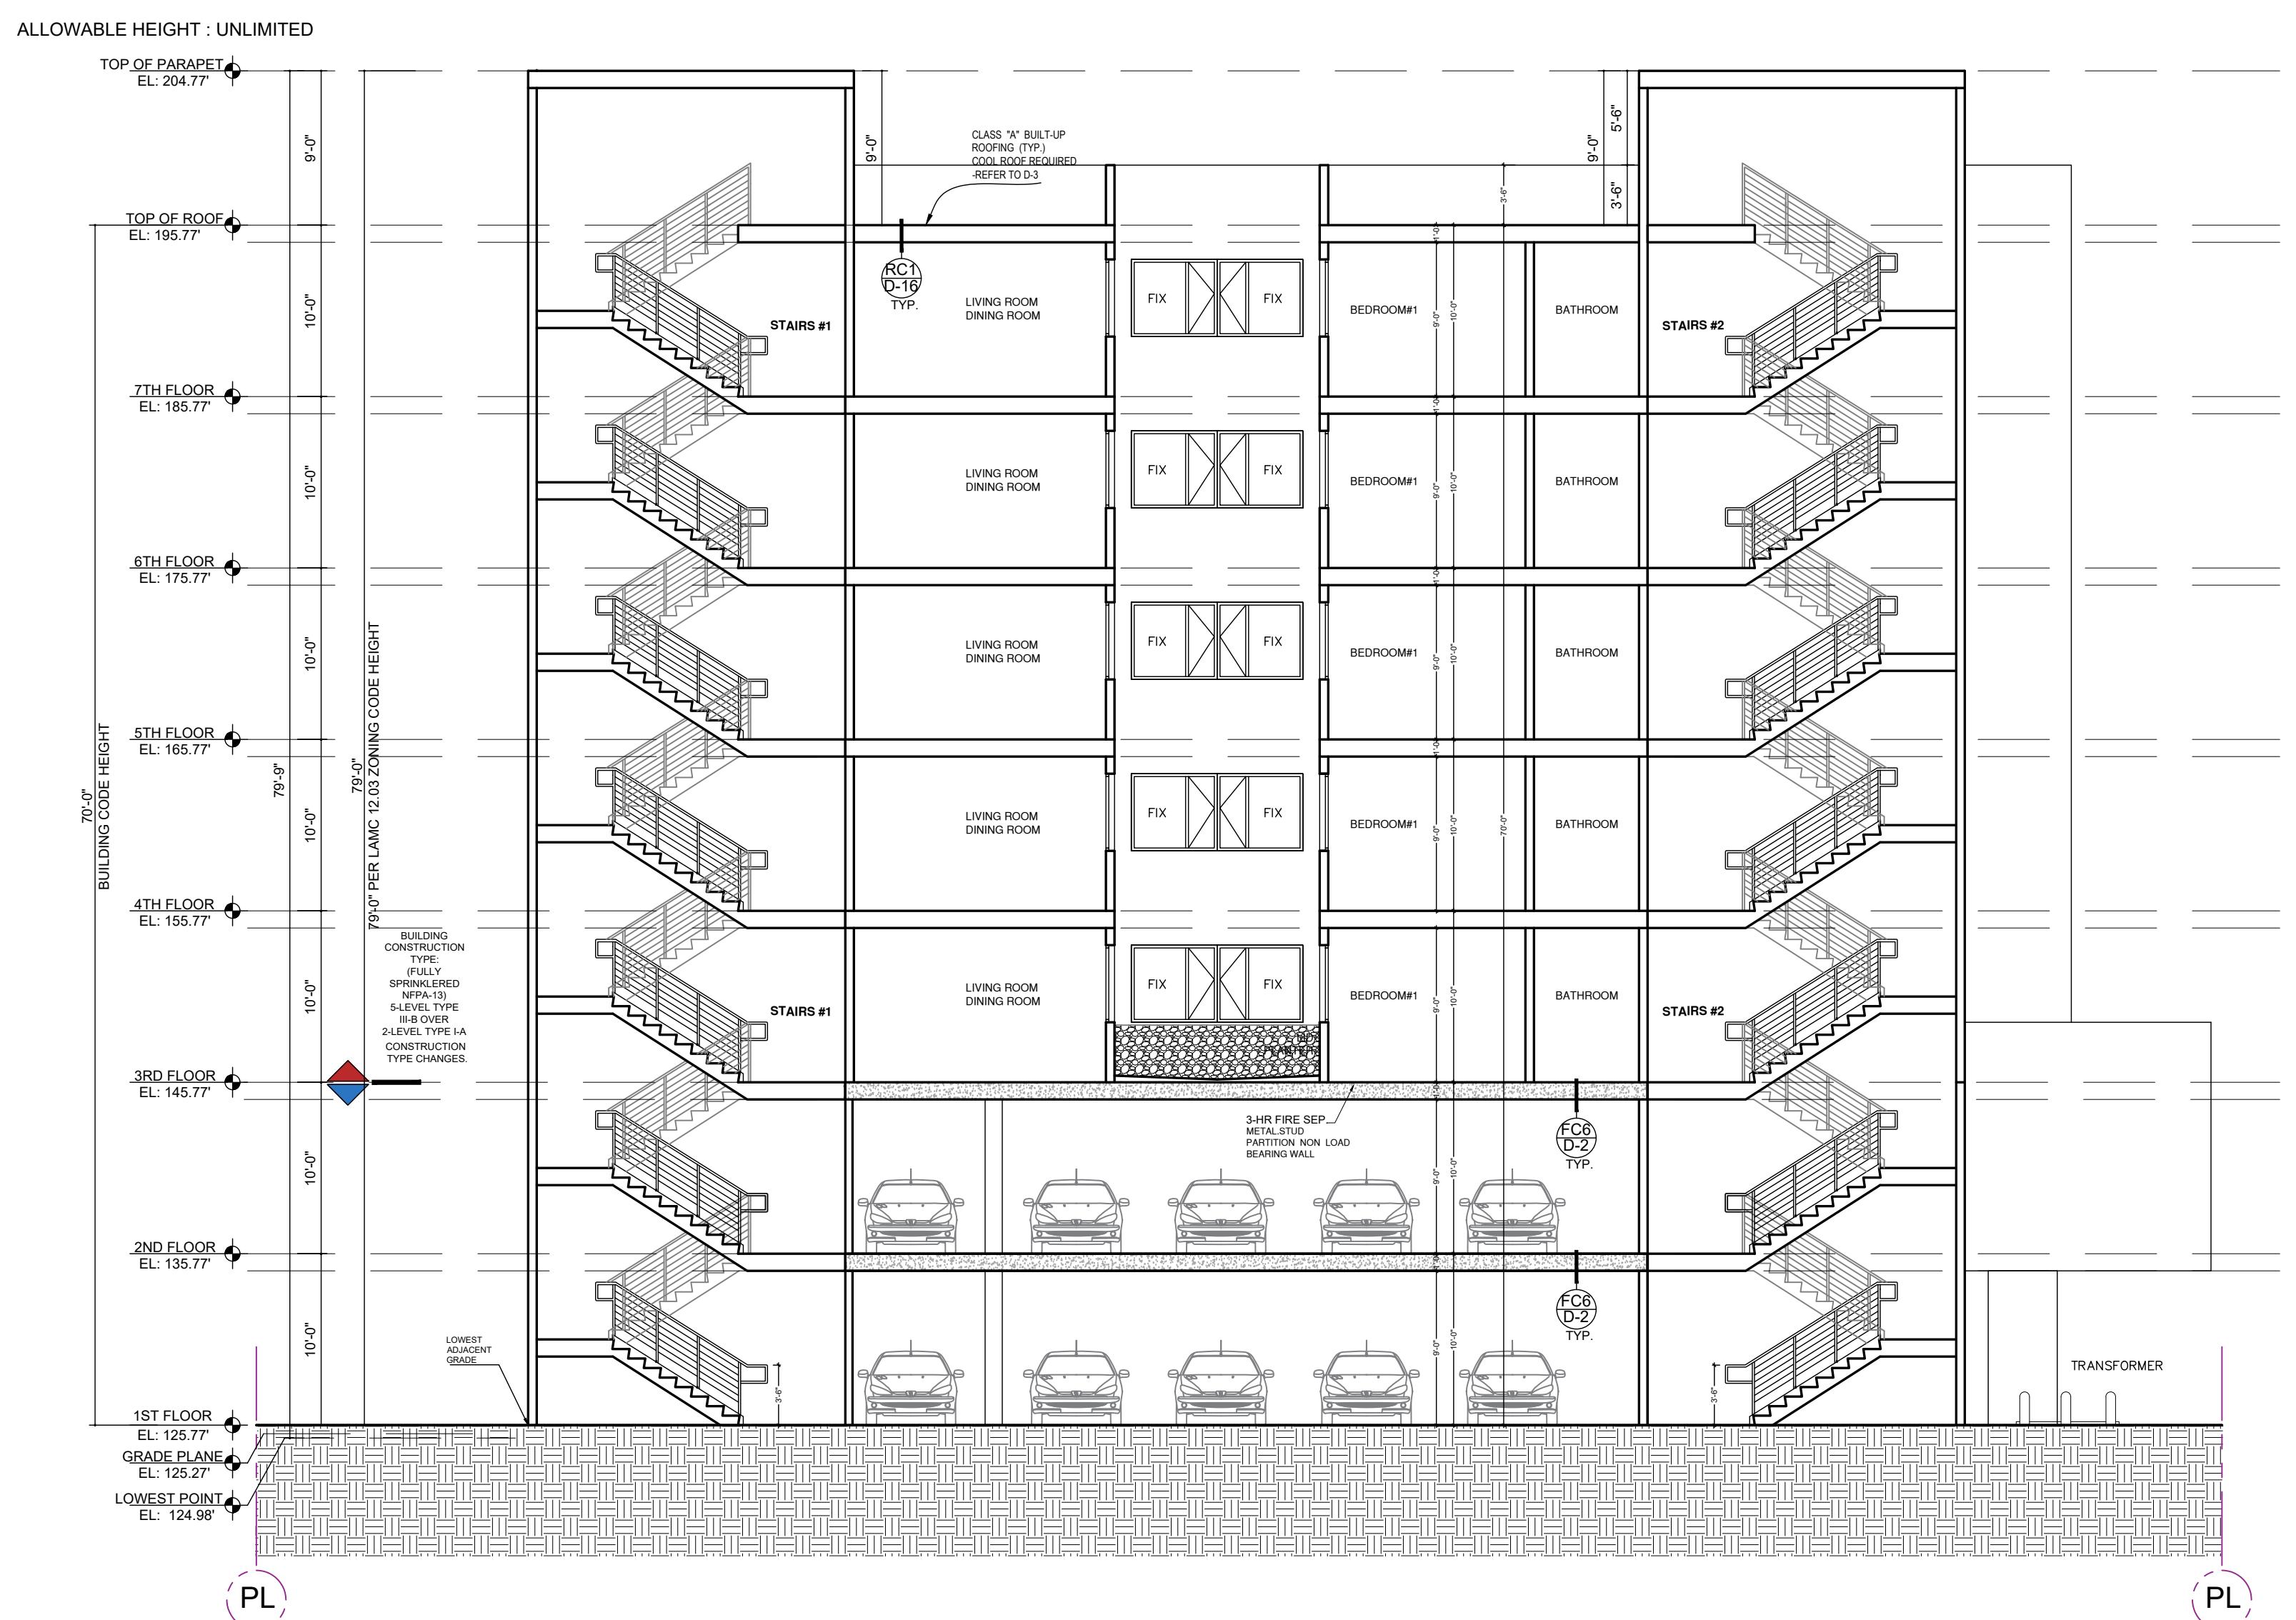

SECTION - B

SCALE 1/8"=1'-0"

BUILDING SECTION GENERAL NOTES

1. THESE BUILDING SECTIONS ARE PROVIDED TO ILLUSTRATE THE DESIGNERURAL RELATIONSHIPS BETWEEN STRUCTURAL ELEMENTS, INTERIOR VOLUME CONFIGURATIONS AND BUILDING PROFILES. REFER TO THE STRUCTURAL PLANS AND TRUSS MANUFACTURER'S PLANS AND CALCULATIONS FOR ALL FRAMING AND TRUSS INFORMATION.
2. FIRE-RATED WALLS, FLOOR/CEILING AND ROOF/CEILING ASSEMBLIES MAY VARY BASED ON THE ACTUAL LOCATION OF A UNIT WITHIN THE BUILDING. SEE COMPOSITE BUILDING PLANS AND CONSTRUCTION NOTES FOR ADDITIONAL INFORMATION.
3. ALL SHAFTS AND VERTICAL OPENINGS SHALL BE PROTECTED PER CBC SECTION 710.8, 711 AND DETAILS ON SHEETS A8.60, A8.61 AND A8.62.
4. REFER TO SHEETS A0.10 FOR RATED WALL SUMMARY AND FIRE RESISTANCE DESIGN SCHEDULE.
5. 30" PARAPETS SHALL BE PROVIDED ON EXTERIOR WALLS TYP. (CBC 705.11)

ADBS APPROVAL STAMP

DOOR SCHEDULE

MARK	DOOR DATA						FRAME		DESCRIPTION	REMARKS	FIRE RATED	DOOR NOTE	
	TYPE	CORE	WIDTH	HEIGHT	THICK	MAT.	FIN.	MAT.	FIN.				
①			3'-0"	8'-0"		WOOD	PAINT	WOOD	PAINT	APARTMENT, ENTRY DOOR	SELF CLOSING	20 MIN.	EXIT DOORS SHALL BE OPENABLE FROM THE INSIDE WITHOUT THE USE OF A KEY, SPECIAL KNOWLEDGE OR EFFORT. FLUSH BOLTS OR SURFACE BOLTS ARE PROHIBITED.
②			2'-10"	7'-0"		WOOD	PAINT	WOOD	PAINT	INTERIOR DOOR			
③			3'-0"	8'-0"		METAL	PAINT	METAL	PAINT	STAIRS DOOR	SMOKE GASKED / PANIC HARDWARE/ SELF CLOSING	90 MIN.	
④			8'-0"	6'-9"		WOOD	PAINT	WOOD	PAINT	SLIDING CLOSET DOOR			
⑤			3'-0"	6'-9"		WOOD	PAINT	WOOD	PAINT	BI-FOLD CLOSET DOOR			
⑥			2'-1"	7'-0"		WOOD	PAINT	WOOD	PAINT	HINGED CLOSET DOOR			
⑦			6'-0"	6'-9"		WOOD	PAINT	WOOD	PAINT	SLIDING CLOSET DOOR			
⑧			3'-0"	7'-0"		METAL	PAINT	METAL	PAINT	EXTERIOR STAIR DOOR	SELF CLOSING SMOKE GASKETED FIRE ASSEMBLY	90 MIN.	
⑨			3'-0"	7'-0"		METAL	PAINT	METAL	PAINT	MECH. RM ELECTRICAL RM	SMOKE GASKED / PANIC HARDWARE/ SELF CLOSING	90 MIN.	
⑩			6'-0"	12'-0"		GLASS	PAINT	METAL	PAINT	DOUBLE DOOR AT LOBBY	PANIC HARDWARE/ SELF CLOSING		
⑪			4'-0"	8'-0"		METAL	PAINT	METAL	PAINT	ELEVATOR DOOR	SMOKE GASKETED FIRE ASSEMBLY	90 MIN.	
⑫			6'-0"	7'-0"		METAL	PAINT	METAL	PAINT	TRASH/ RECYCLE	SELF CLOSING SMOKE GASKETED FIRE ASSEMBLY	90 MIN.	
⑬			3'-0"	6'-0"		METAL	PAINT	METAL	PAINT	BICYCLE GATE			ELEVATOR LOBBY DOOR PROVIDED PER SECTION 708.4.1 EXCEPT 10.10.1.3. DOOR WITH MAGNET HELD OPEN DEVICE TO MEET 13.1.4.3 CBC MINIMUM REQUIREMENT COMPLYING WITH THE SMOKE AND DRAFT CONTROL DOOR ASSEMBLY REQUIREMENTS IN SECTION 716.5.3.
⑭			3'-0"	8'-0"		GLASS	PAINT	METAL	PAINT	COURT ACCESS DOOR			
⑮			2'-0"	2'-0"		METAL	PAINT	METAL	PAINT	TRASH CHUTE	SELF CLOSING SMOKE GASKETED FIRE ASSEMBLY	90 MIN.	
⑯			3'-0"	3'-6"		METAL	PAINT	METAL	PAINT	GATE			
⑰			6'-6"	7'-0"		METAL	PAINT	METAL	PAINT	ROLL UP DOOR		90 MIN.	
													10.10.1.3 Door opening force The force for pushing or pulling open interior swinging doors, other than fire doors, shall not exceed 5 pounds (2N). These forces do not apply to the force required to retract latch bolts or disengage other devices that hold the door in a closed position. For other swinging doors, as well as sliding and folding

B D C

B E B E R L Y D E S I G N

WINDOW SCHEDULE

NOTES:

INTERIOR FINISH OF ELEVATOR CABS SHALL BE SPECIFIED BY THE OWNER, COORDINATE AND CONFIRM AS REQUIRED	ELEVATOR DOORS
HEIGHT OF TILE AT BATHTUBS AND SHOWERS SHALL BE CONFIRMED WITH THE INTERIOR DESIGNERS AND OWNER	ALL ELEVATOR DOORS SHALL BE SELF-CLOSING AND CARRY U.L. LABELS AND NUMBER
FLOOR FINISHES OF OUTDOOR AREAS SHALL BE COORDINATED WITH LANDSCAPE DESIGNER AND OWNER	
ALL TILE SIZES AND BASEBOARD PROFILE SHALL BE CONFIRMED WITH THE INTERIOR DESIGNER AND OWNER.	
ALL INTERIOR FLOOR AND WALL FINISHES SHALL BE TESTED AS SPECIFIED IN SECTION 802. APPLICATION SHALL BE IN ACCORDANCE WITH SECTION 803, 804, AND TABLE 803.9 (MIN CLASS C)	
INTERIOR WALL AND CEILING FINISH SHALL HAVE A FLAME SPREAD INDEX NOT GREATER THAN SPECIFIED IN T803.11. SPECIFY INTERIOR WALL AND CEILING FINISH ON PLANS.(LAFC 803.3)	
MATERIAL OTHER THAN FOAM PLASTICS, USED AS INTERIOR TRIM SHALL HAVE A MIN CLASS C FLAME SPREAD AND SMOKE-DEVELOPED INDEX AND SHALL NOT EXCEED 10% OF THE WALL OR CEILING AREA IN WHICH IT IS ATTACHED.{LAFC 804.1}	
CURTAIN, DRAPERY, FABRIC HANGINGS, AND SIMILAR COMBUSTIBLE DECORATIVE MATERIAL SUSPENDED FROM WALLS OR CEILINGS SHALL NOT EXCEED 10% OF THE WALL OR CEILING AREA TO WHICH SUCH MATERIALS ARE ATTACHED.{LAFC 807.3}**	
IN EVERY GROUP A,E,R-1,R-2, AND R-2.1 ALL DRAPES, HANGINGS, CURTAINS, DROPS, AND ALL OTHER DECORATIVE MATERIAL SHALL BE MADE FROM A NONFLAMMABLE MATERIAL OR TREATED AND MAINTAINED IN A FLAME-RETARDANT CONDITION BY MEANS OF FLAME-RETARDANT SOLUTION OR PROCESS APPROVED BY THE OSFM.{TITLE 19.DIVE1. O 3.08}**	
INTERIOR FINISH MATERIALS APPLIED TO WALL AND CEILINGS SHALL BE TESTED AS SPECIFIED IN SECTION 803. IN ADDITION, PROVIDE DETAILS SHOWING APPLICATION IN ACCORDANCE WITH SECTION 803, 804, AND TABLE 803.9.	
THE FLAME-SPREAD RATING OF PANELING MATERIALS ON THE WALLS OF THE CORRIDOR, LOBBY AND EXIT ENCLOSURE MUST BE IDENTIFIED ON PLANS. (T-803.11)	
ALL NEW WINDOWS SHALL BE DUAL GLAZED ALUM. FRAME WINDOWS SHGC=0.25 MIN. U FACTOR 0.30, SELECTED BY OWNER, CONTRACTOR INSTALLED.	
WINDOWS SHALL MEET EGRESS REQUIREMENTS SECTION (CBC 310.4).	
. ALL SLIDING DOORS AND WINDOWS SHALL BE MILGARD ALUM. OR EQUAL. PROVIDE THERMALLY BROKEN AS REQUIRED TO MEET ENERGY STANDARD PER TITLE 24 REQUIRED	
. CONTRACTOR TO FIELD VERIFY ALL WINDOW OPENINGS PRIOR TO ORDERING.	
WINDOWS SHALL COMPLY WITH 1126A.8 WHERE GLAZED OPENINGS ARE PROVIDED IN ACCESSIBLE ROOMS OR SPACES FOR OPERATION BY OCCUPANTS, AT LEAST ONE OPENING SHALL COMPLY WITH SECTION 1138A.4. EACH GLAZED OPENING REQUIRED BY THE ENFORCING AGENCY TO BE OPERABLE SHALL COMPLY WITH SECTION 1138A.4.	
WINDOWS SHALL BE THERMALLY BROKEN IF REQUIRED IN ORDER TO MEET SHADING COEFFICIENT AND U VALUE PRESCRIBED IN THE TITLE 24 SHEETS	
ALL WINDOWS AND DOORS SHALL BE WATER TESTED. TEST PRODUCT AND INSTALLATION BASED ON ASTM E-1105.	
AT GROUND FLOOR UNITS WATER CURTAIN PROVIDE 3/8" OR 1/2" LEXAN PANEL WITH S.S CLIP TO CEILING & WALL FOR 18" DRAFTSTOP OVER WINDOW HEAD.	
PROVIDE PANIC HARDWARE ON ROOF TOP DOORS THAT LEAD TO THE STAIRCASE AND AT THE DISCHARGE DOORS THAT LEAD TO THE STAIRCASE AND AT THE DISCHARGE DOORS THAT LEAD TO THE COURT /RIGHT OF WAY 1010.1.10	

OWNER :



8688 WEST PICO LLC

PROJECT :

8688 W Pico Blvd,
Los Angeles, CA 90035

SHEET TITLE:

DOOR & WINDOW SCHEDULE

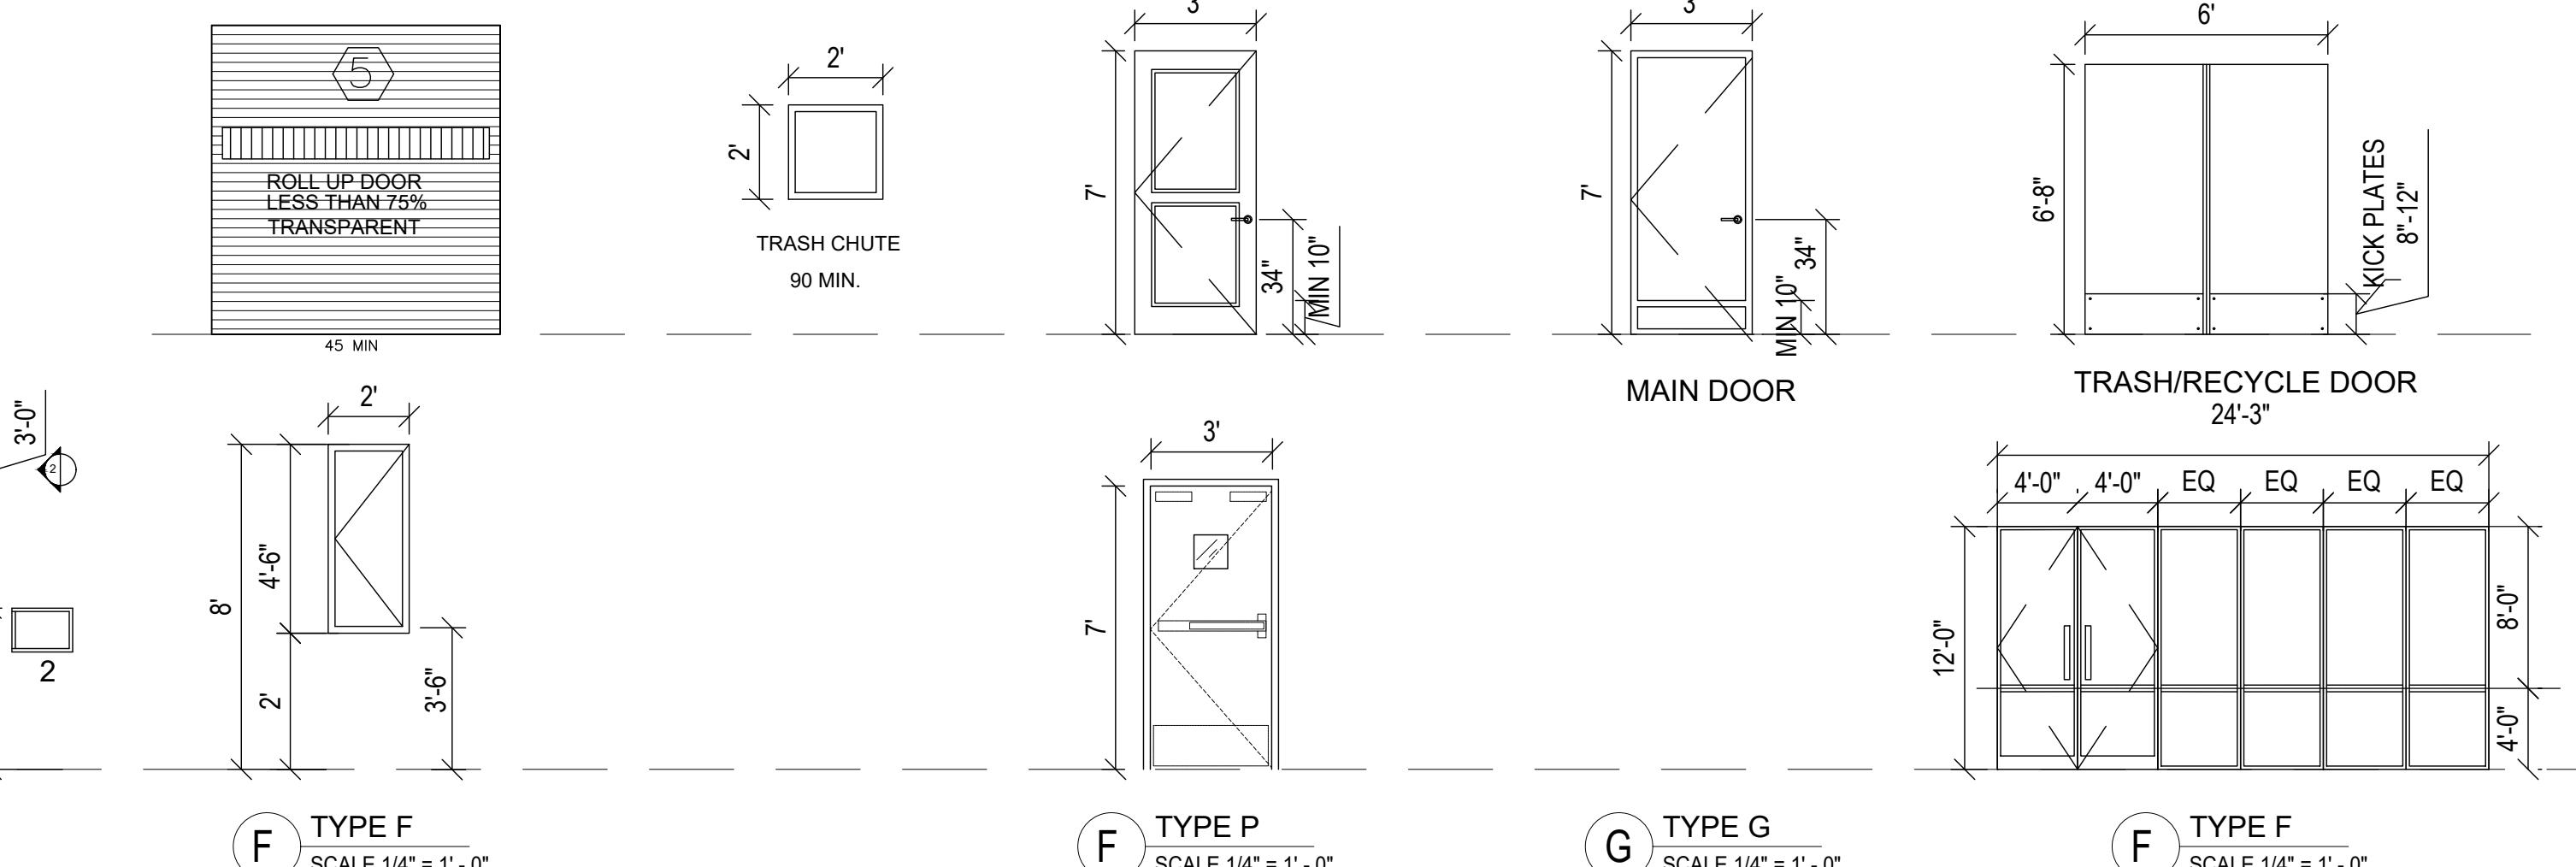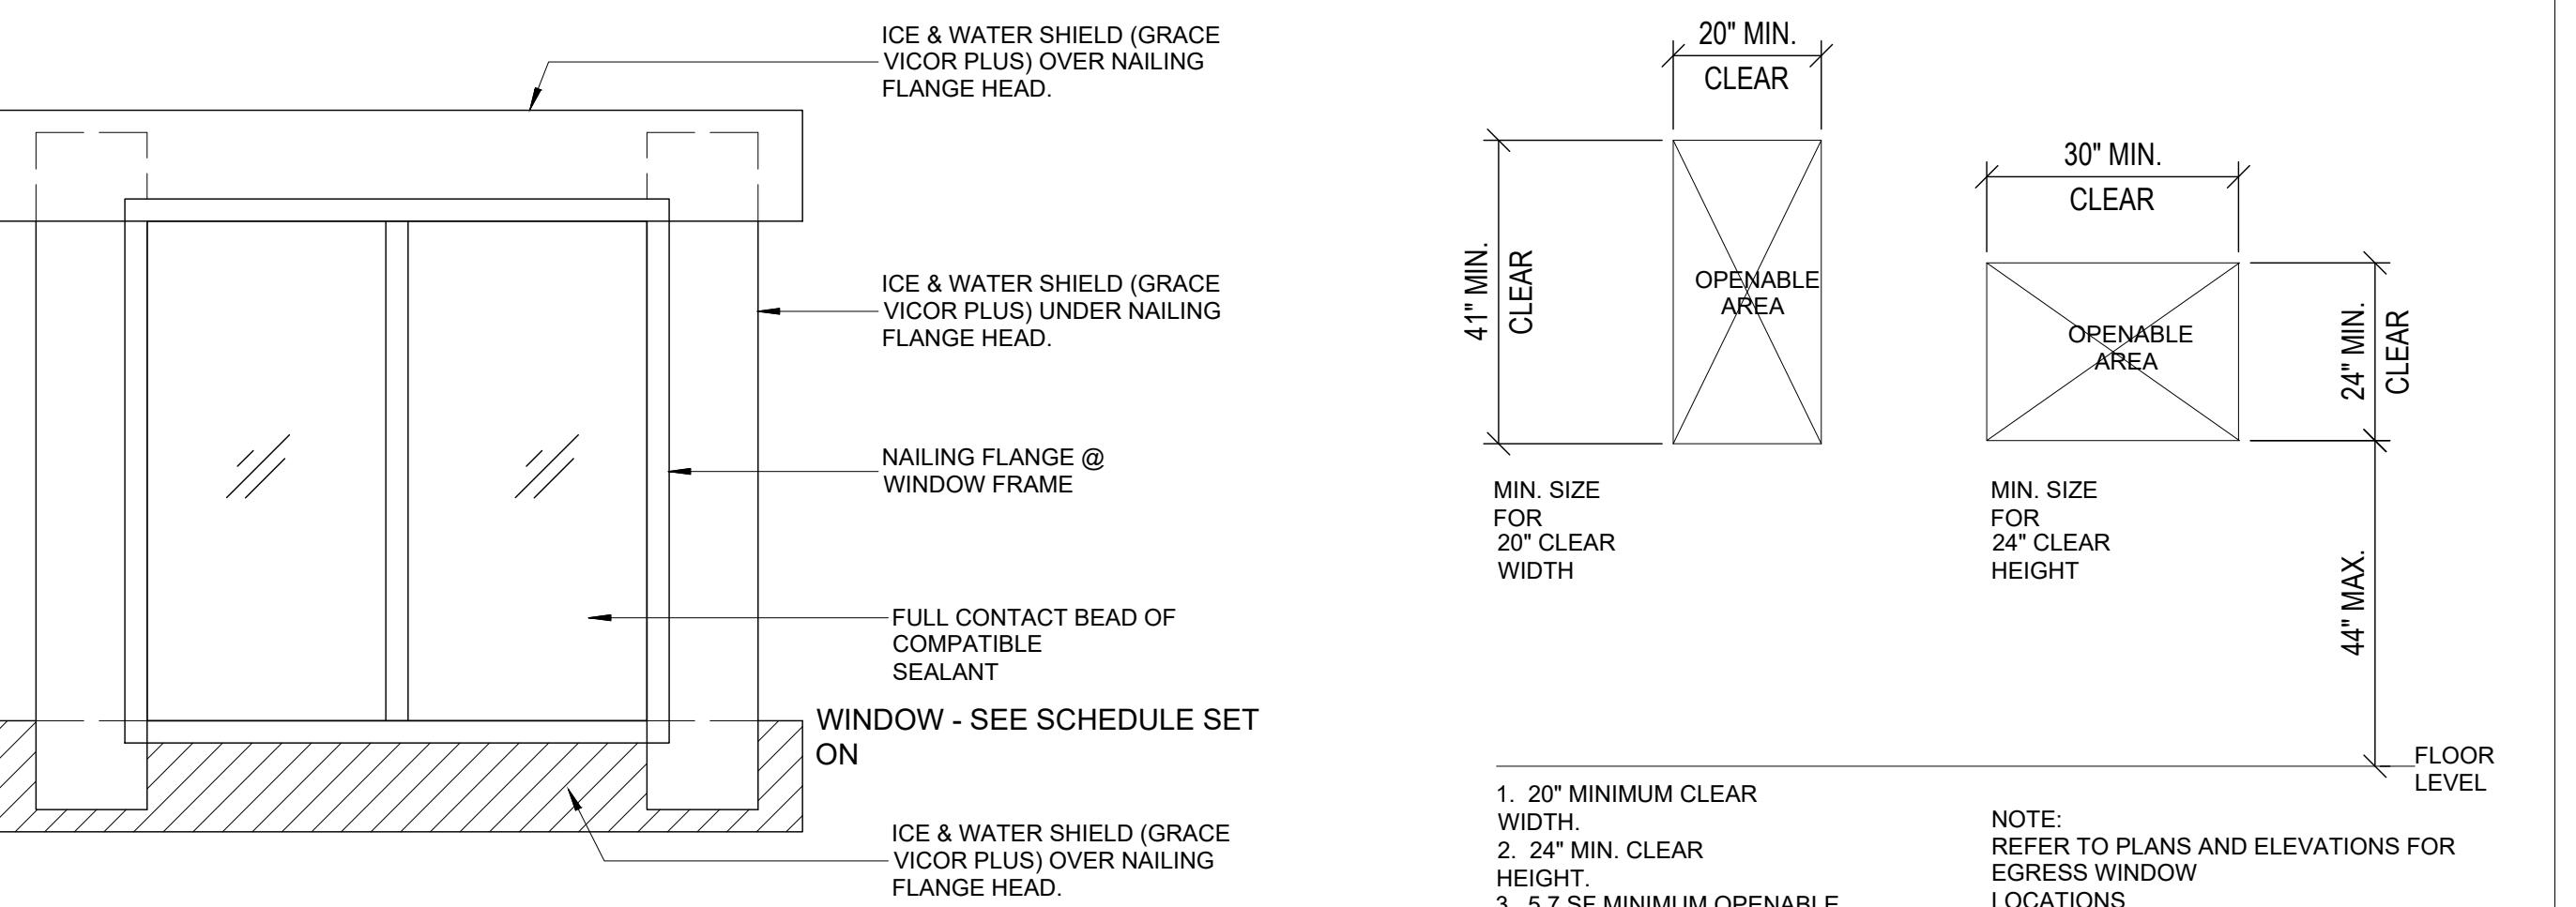

REVISION:
NO. DATE BY

SCALE :
DRAWN :

DATE : December 25
JOB NUMBER :

SHEET

ЛБ 0

AJ.U

The figure contains five technical drawings of door frames labeled A through E. Each drawing shows a rectangular frame with internal dimensions and fixings. Type A has a total width of 6' and a height of 8'. Type B has a total width of 3'-6" and a height of 8'. Type C has a total width of 2' and a height of 8'. Type D has a total width of 3' and a height of 5'. Type E is a long horizontal frame with a total width of 17'-7" and a height of 2'-2". Fixings are indicated by 'FIX' labels and diagonal lines.

Architectural floor plan for Type F. The room has a total width of 8' and a total depth of 10'. The room is divided into a central rectangular opening (4' 6" wide by 3' 6" deep) and a surrounding area. The central opening is 2' from the left wall and 3' 6" from the right wall. The top edge of the opening is 2' from the top wall. The bottom edge of the opening is 2' from the bottom wall.

The diagram illustrates a Type P fire door assembly. The overall width is 3' and the overall height is 7'. The door itself is 2' 7" wide and 6' 7" high. A horizontal handle is located on the left side of the door. A small square with diagonal lines is positioned in the upper right quadrant of the door panel. A rectangular opening is located at the bottom of the door panel. The door is set within a frame, and a dashed line indicates the hinge side.

MAIN DOOR

TRASH/RECYCLE DOOR
24'-3"

4'-0" 4'-0" EQ EQ EQ EQ

12'-0"

8'-0"

4'-0"

TYPE G

SCALE 1/4" = 1' - 0"

TYPE F


SCALE 1/4" = 1' - 0"

- 10 -

A5.0


TRANSIT STOP MAO & LOCATION

PUBLIC TRANSPORTATION DISTANCE

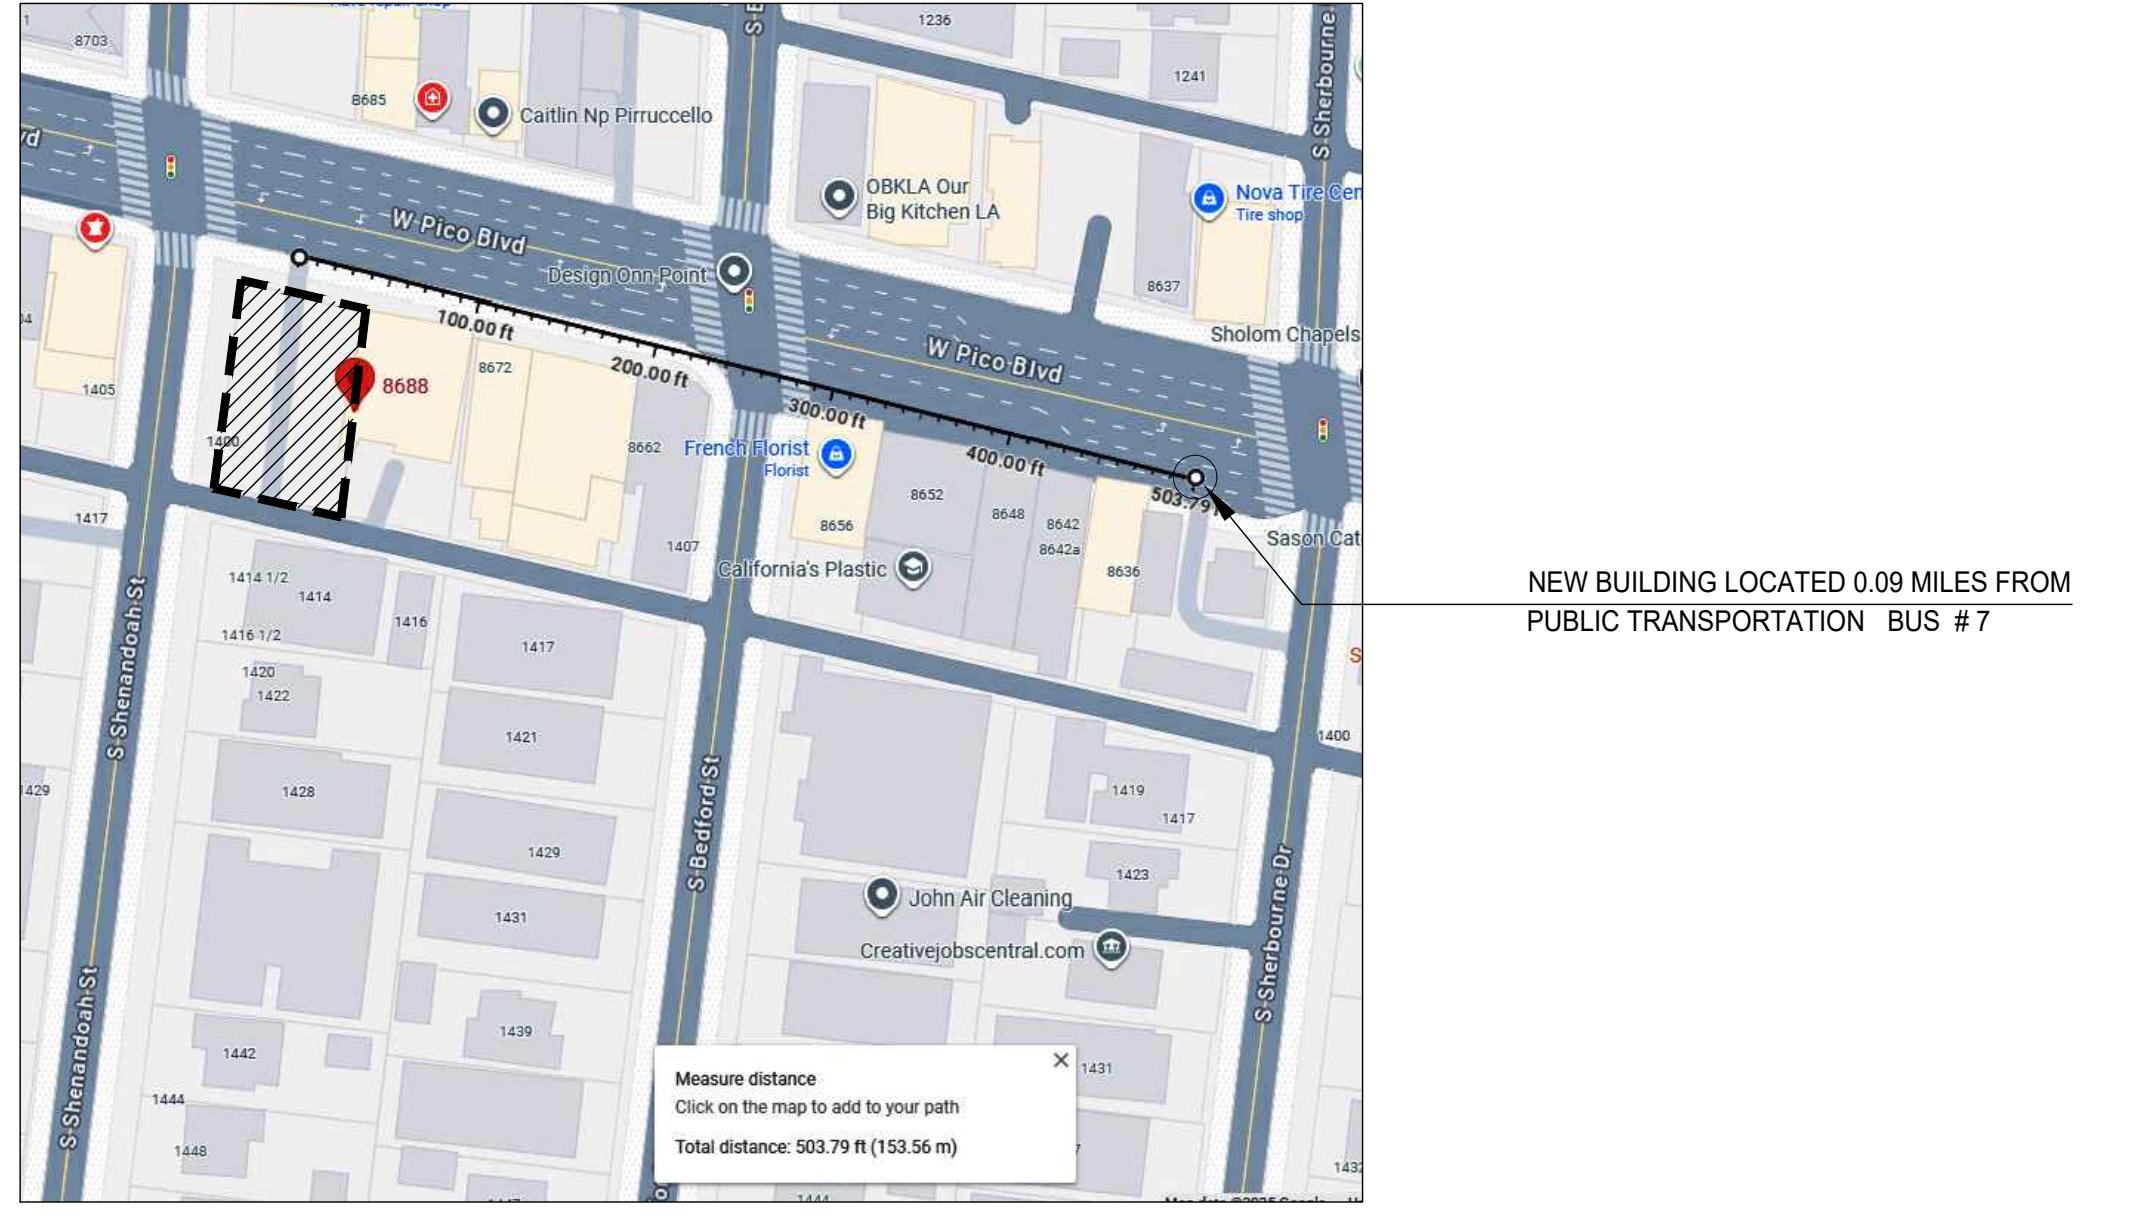

LONG TERM BICYCLE PARKING DETAIL



BUS SCHEDULE

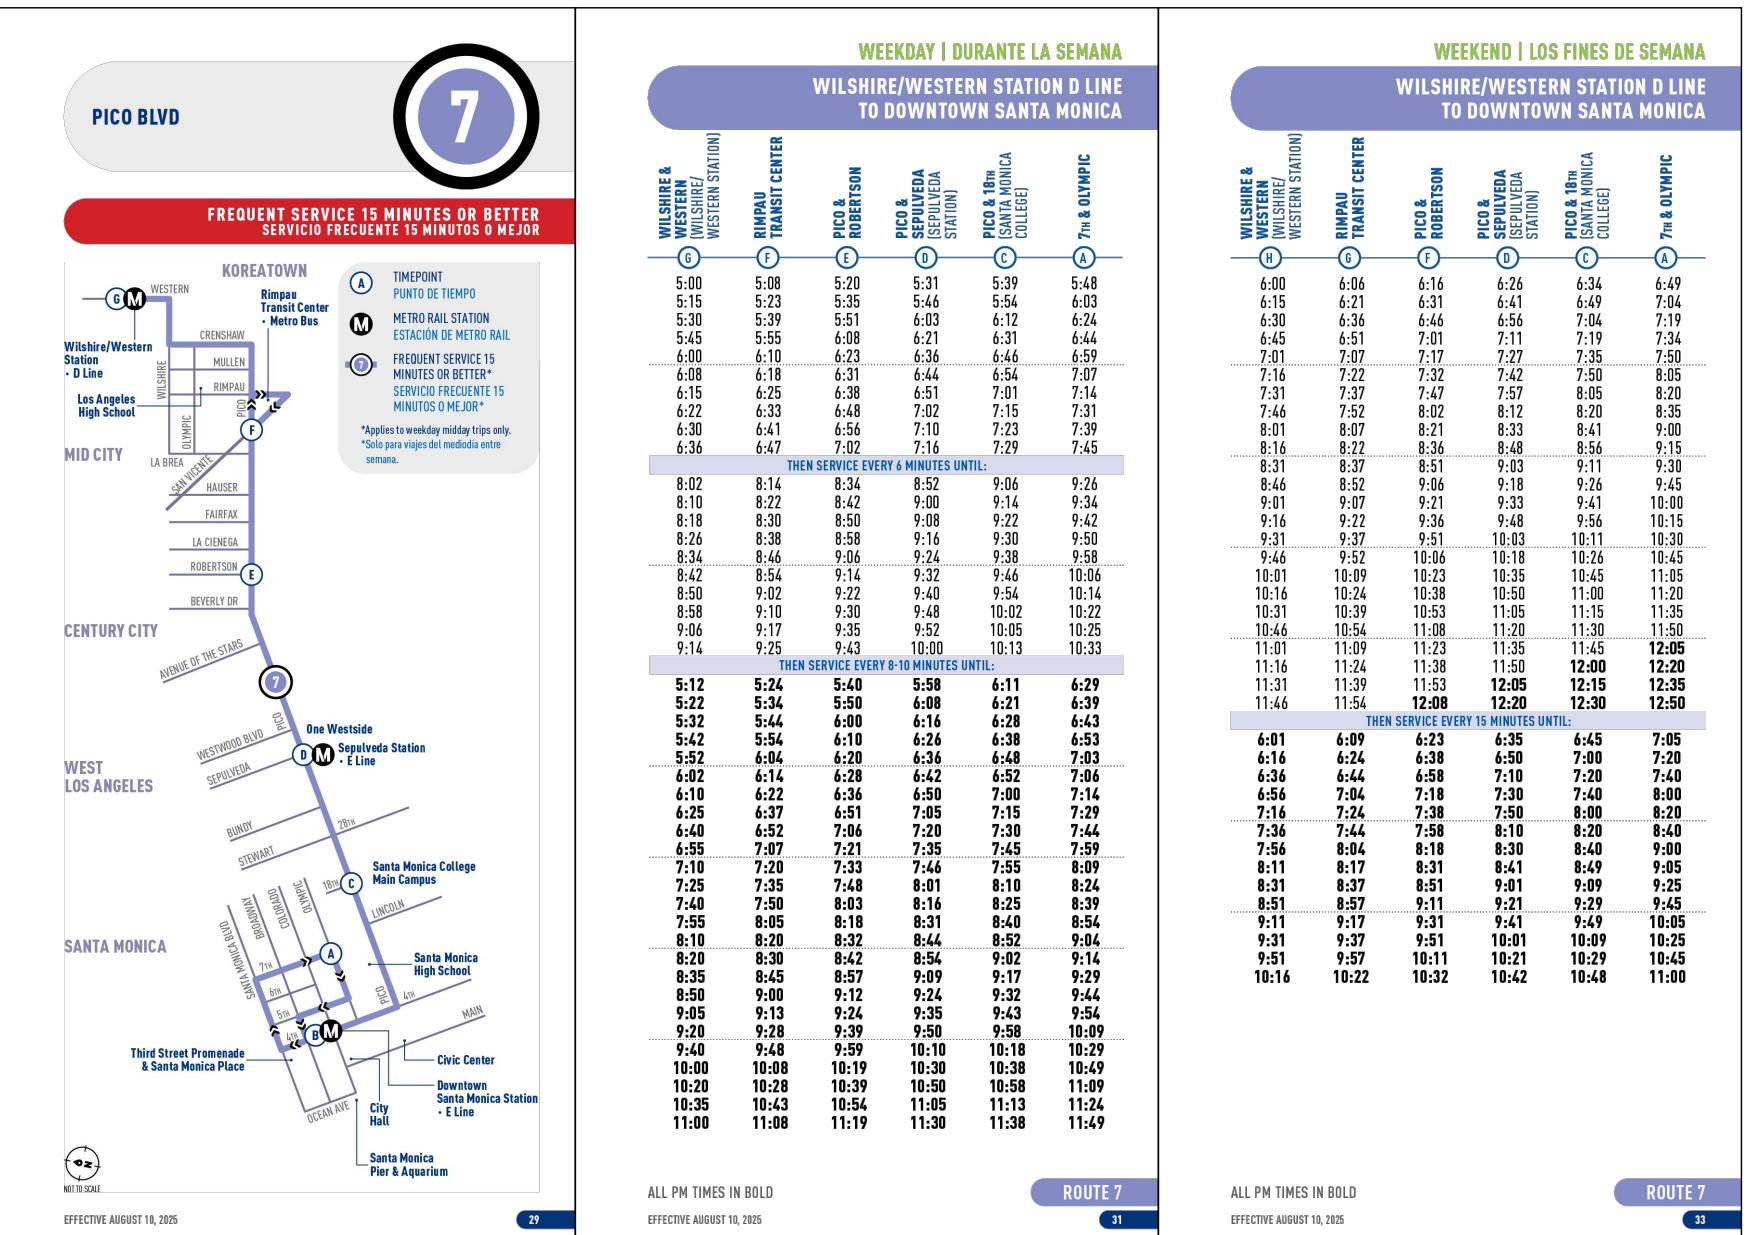


19 BIKE RACK ATTACHMENT

Stack Rack

Recommended Spacing

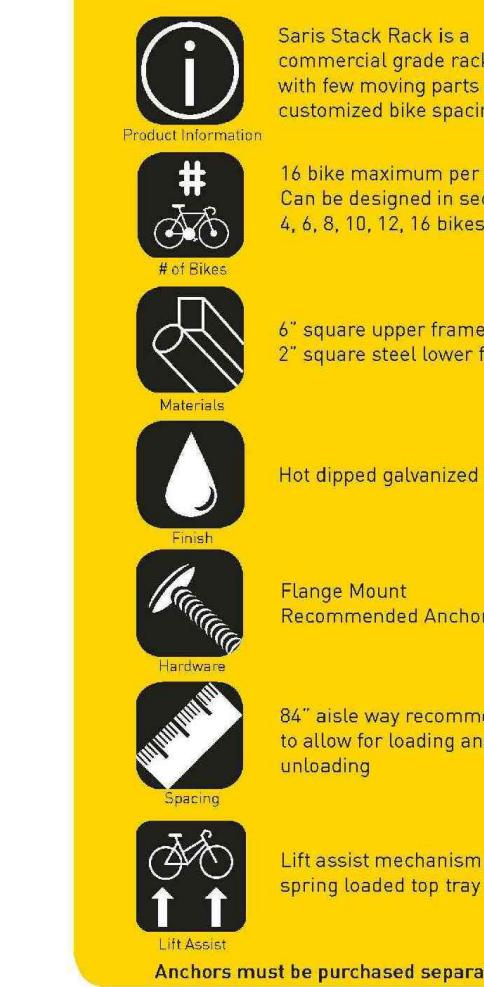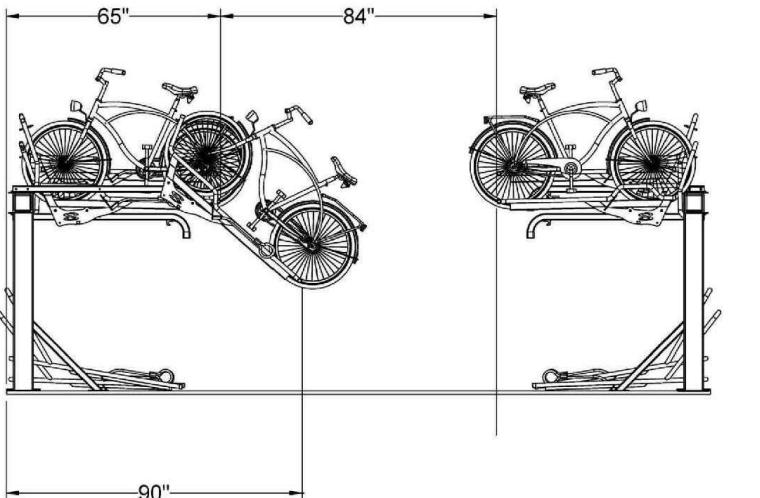


Single-Sided Layout

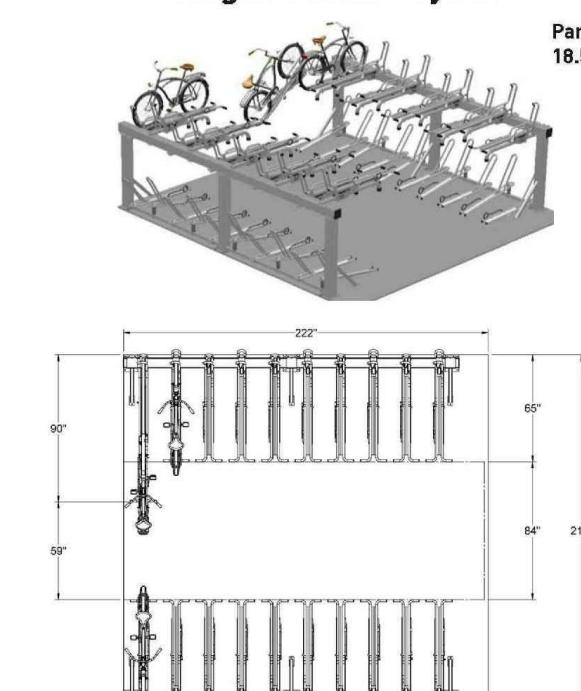


Downloadable product resources available online:
 Saris Bicycle Parking & Storage Solutions 800.783.7257 x174 www.sarsparking.com

SHORT TERM BICYCLE PARKING DETAIL

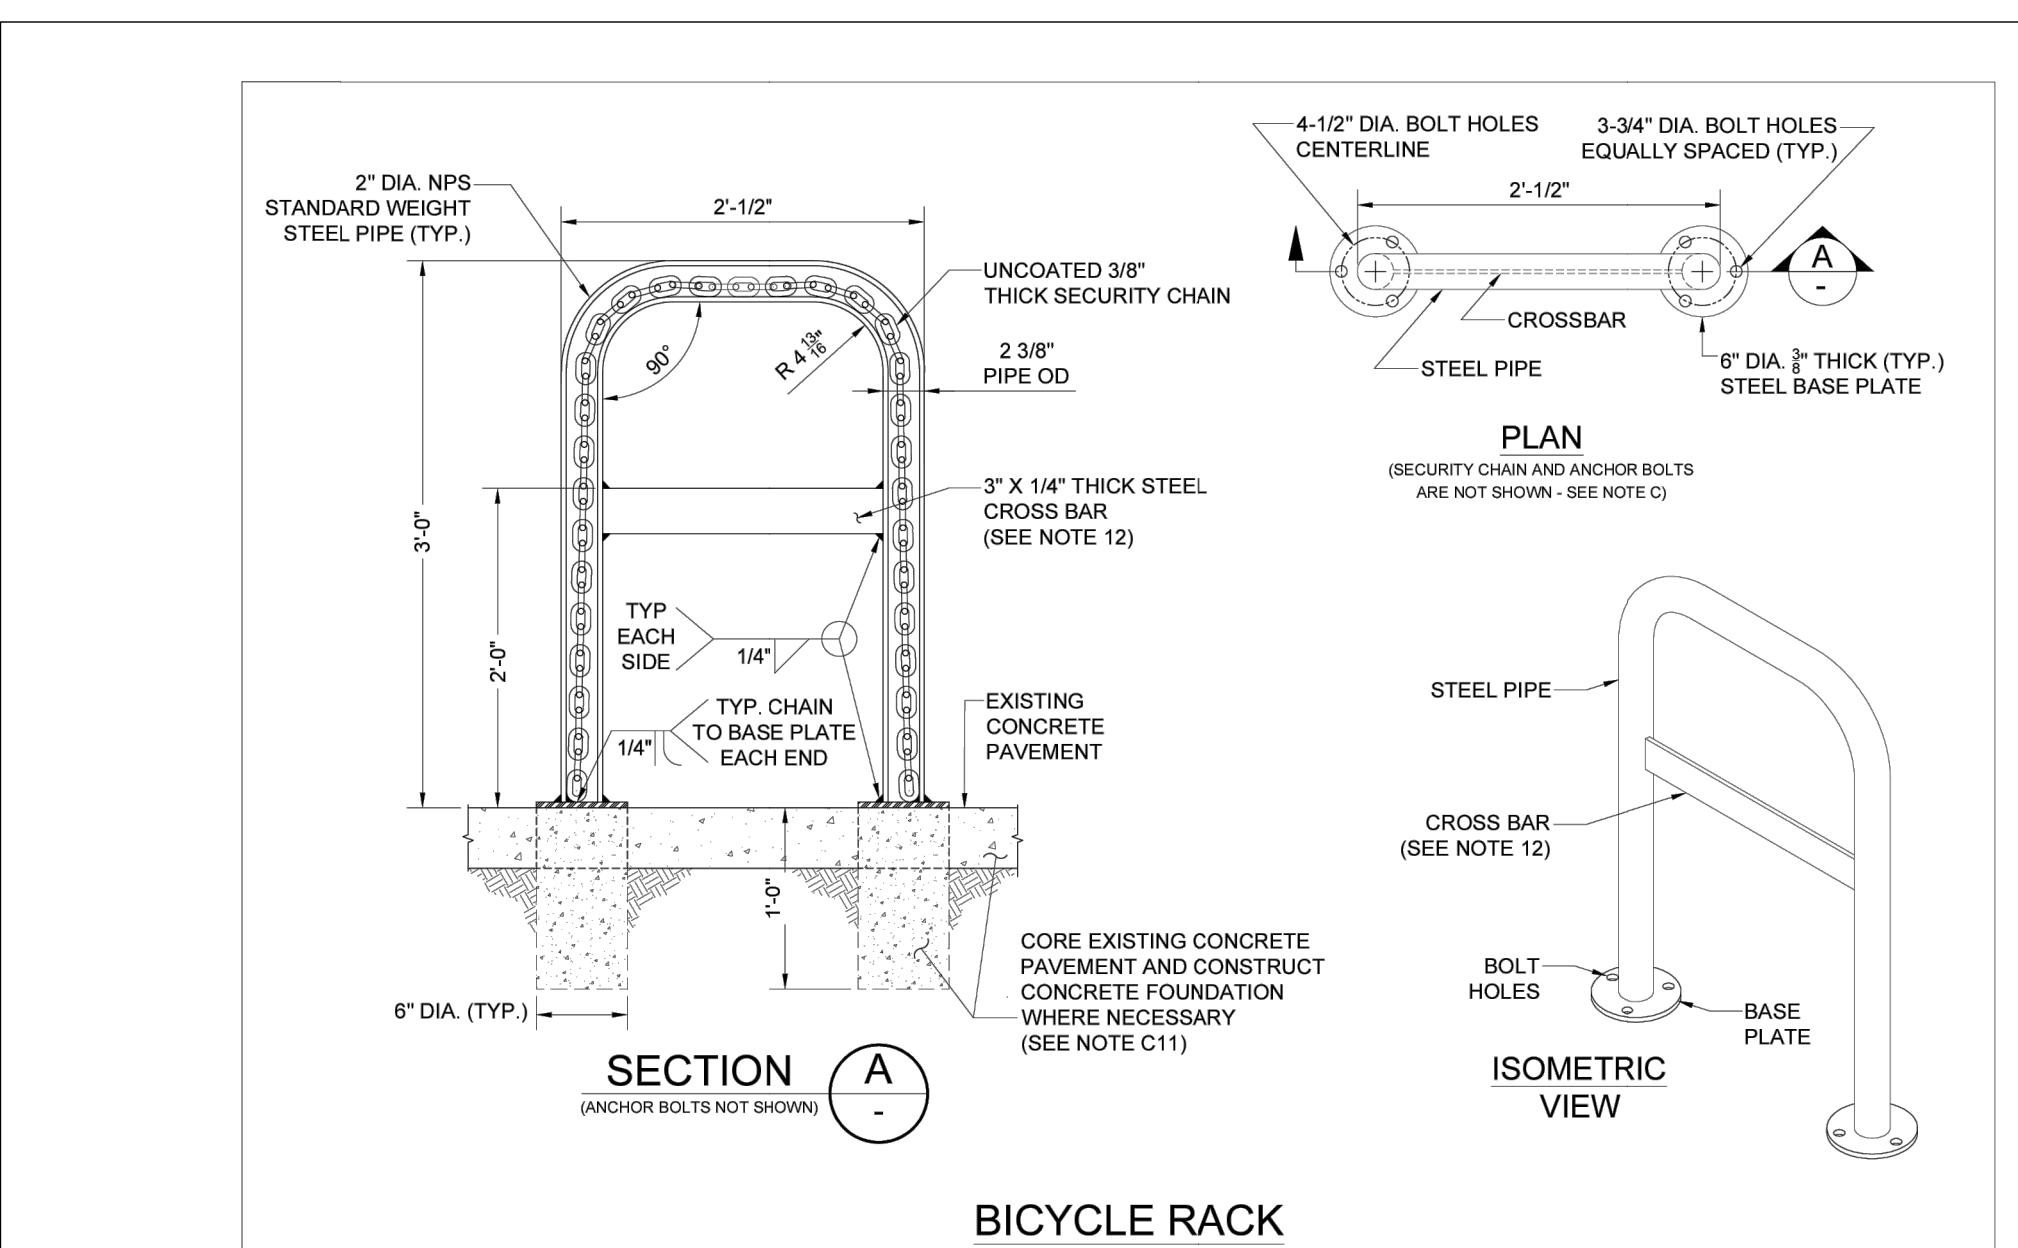

BICYCLE RACK

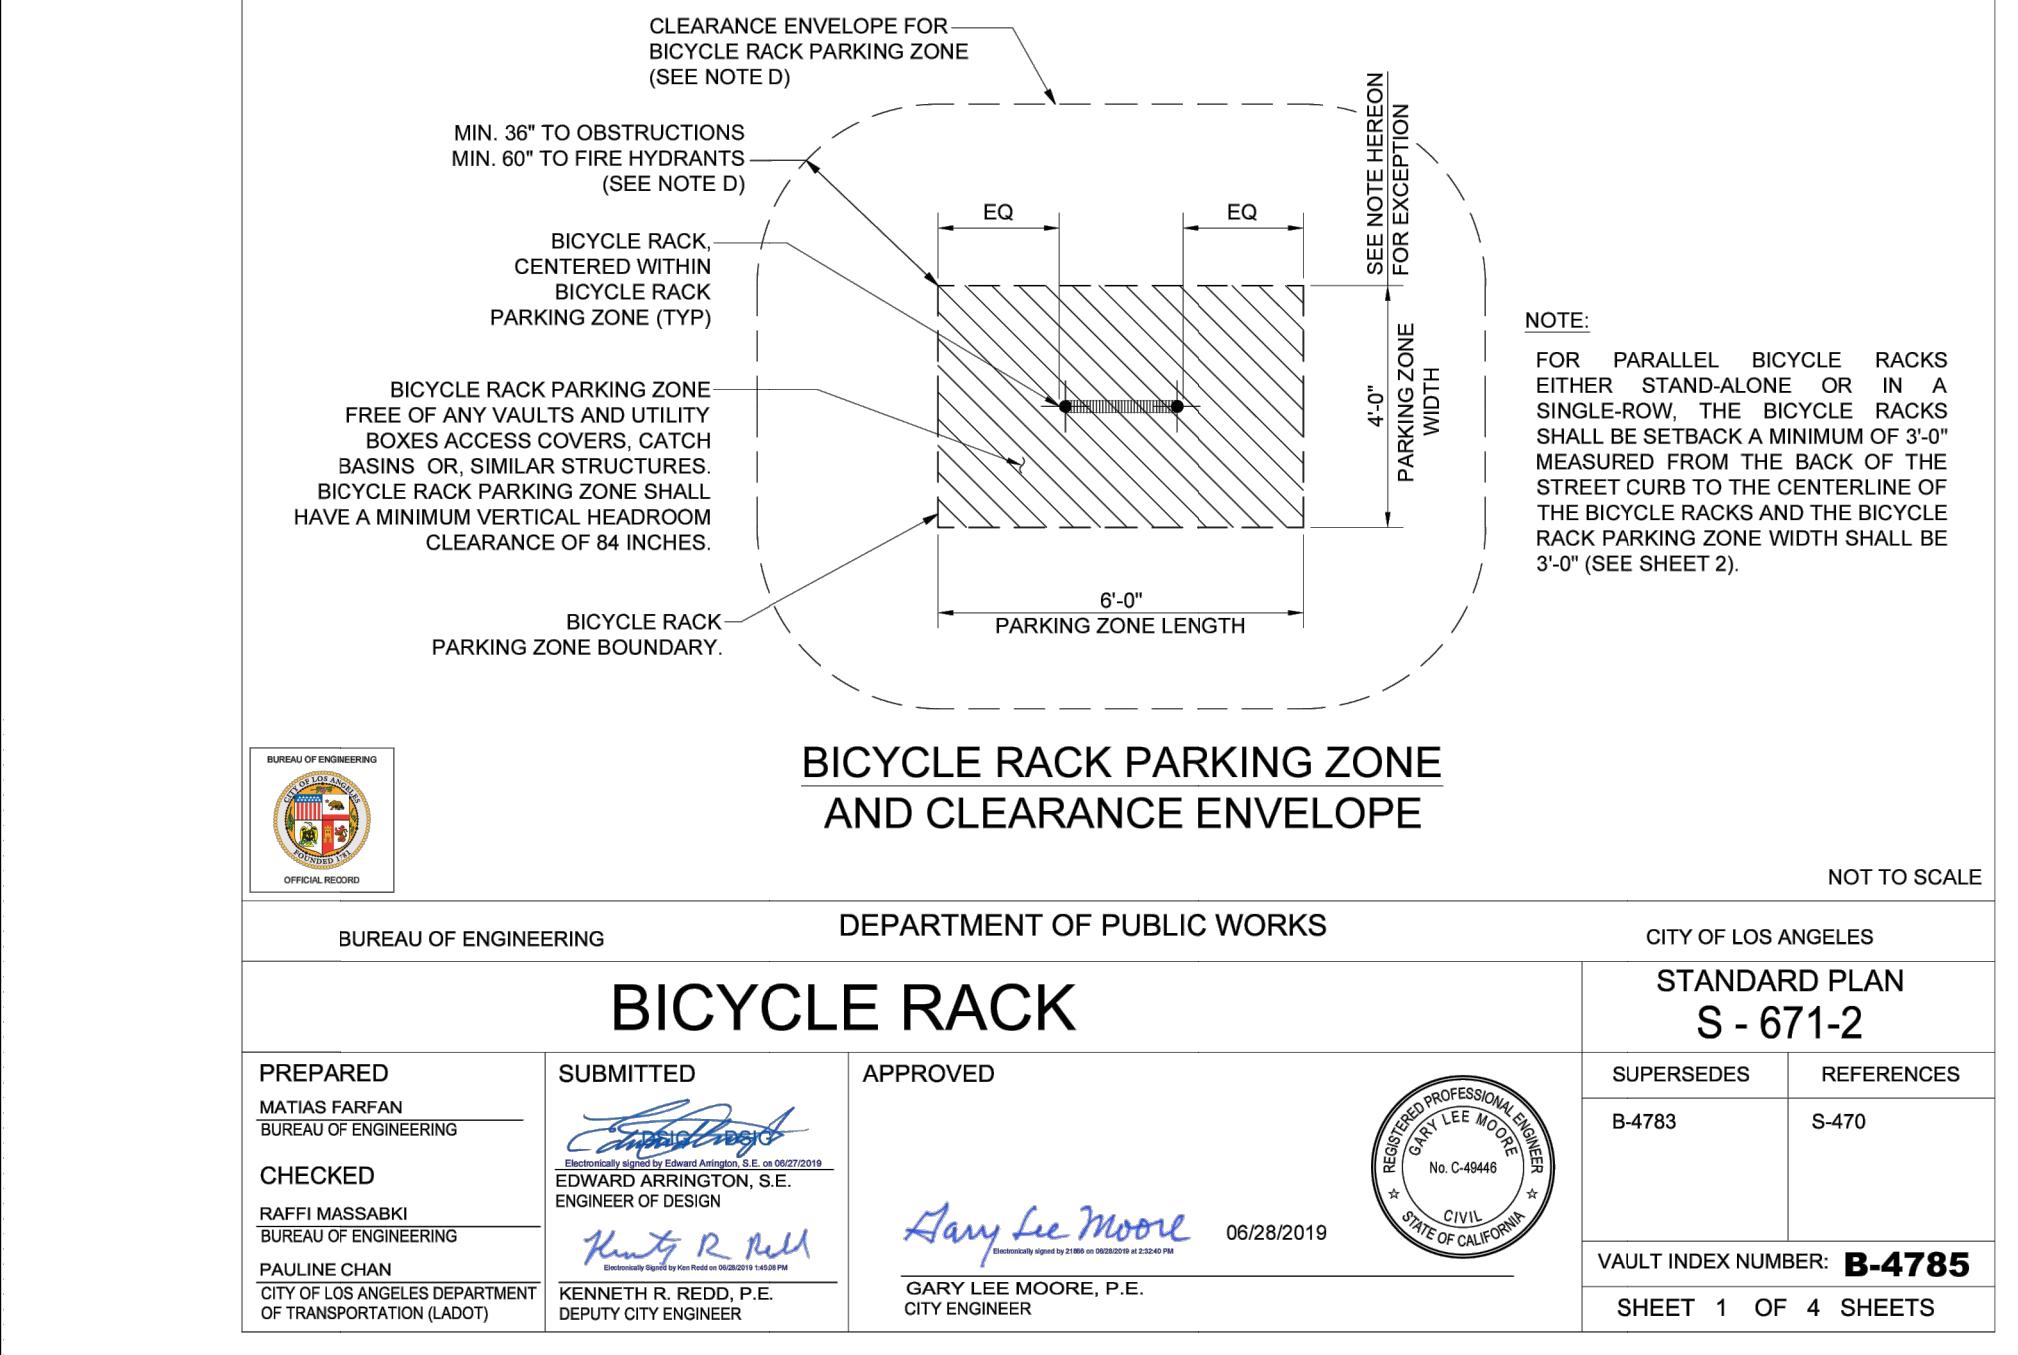

PLANS RECYCLING NOTES

SECTIONS 12.21.A19.(C)(4) THROUGH (12)(IV)

1. TO ENCOURAGE ACTIVE PARTICIPATION IN RECYCLING TO THE MAXIMUM EXTENT POSSIBLE, EACH PROPERTY OWNER, MANAGER, OR LESSEE SHALL INFORM ALL TENANTS AND/OR EMPLOYEES LIVING OR WORKING ON THE PROPERTY OF THE AVAILABILITY AND LOCATION OF THE RECYCLING AREA(S) OR ROOM(S), THE TYPES OF MATERIALS THAT ARE COLLECTED FOR RECYCLING, THAT THE RECYCLING COLLECTION FACILITIES ARE LOCATED ON THE PROPERTY PURSUANT TO STATE LAW REQUIRING THE DIVERSION OF A SUBSTANTIAL PORTION OF SOLID WASTE.
2. EACH PROPERTY OWNER OR LESSEE SHALL CONTRACT WITH A RECYCLER OR HAULER FOR THE PICK-UP OF RECYCLABLE MATERIALS, SEPARATE FROM TRASH COLLECTION, WHEN RECEPTACLES ARE FULL OR EVERY WEEK, WHICHEVER OCCURS FIRST.
3. NO TOXIC OR HAZARDOUS MATERIAL SHALL BE STORED IN RECYCLING AREAS OR ROOMS RECYCLING OR RECEPTACLES.
4. ALL RECYCLABLE MATERIALS SHALL BE PLACED OR STORED IN RECYCLING RECEPTACLES. PAPER PRODUCTS AND OTHER LIGHTWEIGHT MATERIALS SHALL BE IMMEDIATELY PLACED INTO COVERED RECYCLING RECEPTACLES WHEN THEY ARE DROPPED OFF.
5. ON A DAILY BASIS THE RECYCLING AREA OR ROOM SHALL BE KEPT FREE OF LITTER, DEBRIS, SPILLAGE, BUGS, RODENTS, ODORS, AND OTHER SIMILAR UNDESIRABLE HAZARDS.
6. THE RECYCLING AREA OR ROOM SHALL BE CLEARLY IDENTIFIED BY ONE OR MORE SIGNS DESIGNATING IT FOR RECYCLING COLLECTION AND LOADING.
7. THE RECYCLING AREA OR ROOM SHALL BE AVAILABLE FOR USE BY PERSONS RESIDING OR EMPLOYED ON THE PROPERTY, BUT SHALL BE KEPT SECURED FROM UNAUTHORIZED ENTRY BY THE GENERAL PUBLIC.

8. RECYCLING AREAS OR ROOMS SHALL NOT DIMINISH THE REQUIRED NUMBER OF PARKING SPACES OR IMPAIR TRAFFIC FLOW.

9. RECYCLING AREAS OR ROOMS SHALL BE PLACED ALONGSIDE OF TRASH AREAS OR ROOMS WHEREVER POSSIBLE AND SHALL COMPLY WITH THE FOLLOWING: (AMENDED BY ORD. NO. 181,227, EFF. 9/1/10.)

A. RECYCLING ROOMS SHALL COMPLY WITH SECTION 91.6102 OF THIS CODE AND MUST BE EQUIPPED WITH AN AUTOMATIC SPRINKLER SYSTEM PURSUANT TO SECTION 57.304.2.2 OF THIS CODE.

B. OUTDOOR RECYCLING AREAS IN COMMERCIAL, INDUSTRIAL, OR PUBLIC FACILITIES, OR RESIDENTIAL BUILDINGS HAVING FOUR OR MORE LIVING UNITS SHALL BE CONFINED TO THE REAR ONE-HALF OF THE LOT AND SHALL NOT EXCEED AN AREA OF 300 SQUARE FEET.

C. OUTDOOR RECYCLING AREAS SHALL BE COMPLETELY ENCLOSED BY AN EIGHT-FOOT WALL OR CHAIN LINK FENCE WITH WOODEN SLATES.

CONCRETE BLOCK, OR SIMILAR CONSTRUCTION (ENCLOSURE) WITH GATES OF THE SAME HEIGHT. NO MATERIAL SHALL EXCEED THE HEIGHT OF THE WALL OR FENCE. THE ENCLOSURE SHALL BE CONSTRUCTED WITH A CONCRETE FLOOR SLOPED TO DRAIN, AND A WATER FAUCET FOR HOSE ATTACHMENT SHALL BE LOCATED ADJACENT TO OR WITHIN THE ENCLOSURE. THE ENCLOSURE SHALL BE SECURED BY A LOCKING GATE.

D. PURSUANT TO SECTION 57.304.2.2 OF THE CODE, OUTDOOR RECYCLING AREAS SHALL BE LOCATED A MINIMUM OF 10 FEET FROM ANY BUILDING OR BUILDING OPENING EXCEPT WHEN LOCATED ADJACENT TO A MINIMUM ONE-HOUR WALL AND A MINIMUM OF 10 FEET FROM ANY BUILDING OPENING.

EDC
BEBERLY DESIGN

NOTICE:
THE DESIGNS SHOWN AND DESCRIBED HEREIN, INCLUDING ALL TECHNICAL DRAWINGS, GRAPHICS, AND MODELS THEREIN, ARE THE PROPERTY OF BEBERLY DESIGN AND ARE NOT COPIED, DUPLICATED, REPRODUCED OR COMMERCIALIZED, IN WHOLE OR IN PART WITHOUT THE WRITTEN PERMISSION OF BEBERLY DESIGN.
ALL THESE DRAWINGS HAVE BEEN PREPARED TO DESCRIBE NEW WORK ONLY AND DO NOT REPRESENT AS-BUILT OR ACCURATE EXISTING CONDITIONS. THE DESIGNER SHALL NOT BE HELD LIABLE FOR THE ACCURACY OF THIS INFORMATION AND SHALL NOT BE RESPONSIBLE FOR DISCREPANCIES BETWEEN THIS DOCUMENT AND EXISTING CONDITIONS. THESE PLANS ARE NOT DRAWN TO SCALE AND ARE FOR REVIEW AND EVALUATION AS 'INSTRUMENTS OF SERVICE' BY THE CLIENT, CONSULTANT, CONTRACTOR, SUBCONTRACTORS, AGENT, VENDORS AND OFFICE PERSONNEL ONLY IN ACCORDANCE WITH THIS NOTICE. DO NOT SCALE OFF THESE DRAWINGS. ALL RIGHTS RESERVED COPYRIGHT, BEBERLY DESIGN

D-1