

### DEPARTMENT OF CITY PLANNING

### **RECOMMENDATION REPORT**

City Pl	anning C	Commission	Case No.: CEQA No.:	CPC-2023-5657-DB-VHCA ENV-2023-5658-CE
Date: Time: Place:	January 2 after 8:30 Van Nuys Council C	a.m.	Incidental Cases: Related Cases: Council No.: Plan Area:	None None 11 - Park West Los Angeles
	14410 Sy	Ivan Street, Van Nuys CA Ies, CA 90401	Plan Overlay:	West Los Angeles Transportation Improvement and Mitigation Plan
		ing may be available virtually, in a	Certified NC:	West Los Angeles Sawtelle
	agenda a meeting fo	mat. Please check the meeting pproximately 72 hours before the pr additional information at:	GPLU: Zone:	Neighborhood Commercial [Q]C2-1
	boards-he	nning.lacity.org/about/commissions- earings and/or by contacting	Applicant:	Donghao Li 1531 Sawtelle Blvd., LLC
	cpc@lacit	<u>y.org</u>	Representative:	Gary Benjamin
Public H Appeal \$	-	October 4, 2024 Not appealable		Alchemy Planning + Land Use

Expiration Date:January 23, 2025Multiple Approval:No

### PROJECT 1531 – 1535 South Sawtelle Boulevard

LOCATION: (legally described as Barrett Villa Tract, Block E, Lots 7 & FR 8, Arb 4)

**PROPOSED PROJECT:** The project is the construction, use, and maintenance of a five-story, 56-foot high, 9-unit residential development including one (1) unit set aside for a Very Low Income Household, with zero vehicular parking spaces. The project will be approximately 15,972 square feet in floor area with a Floor Area Ratio ("FAR") of 3.25:1. The site is currently improved with a one-story, 2,500 square-foot commercial retail building and surface parking lot located in the rear of the lot which will be demolished for the project. There are no protected trees on the subject property and there are no protected street trees. There are no existing trees on the property to be removed as part of the project.

## REQUESTED ACTION:

The City Planning Commission will consider:

1. Pursuant to California Environmental Quality Act ("CEQA") Guidelines, an exemption from CEQA pursuant to CEQA Guidelines, Article 19, Section 15332 (Class 32), and that there is no substantial evidence demonstrating that an exception to a categorical exemption pursuant to CEQA Guidelines, Section 15300.2 applies.

2. Pursuant to Los Angeles Municipal Code Section 12.22 A.25(g)(2) and (3), a Density Bonus/Affordable Housing Incentive Program Compliance Review to permit the construction of a Housing Development Project totaling 9 dwelling units, reserving one unit for Very Low Income Household occupancy for a period of 55 years, with the following requested incentives and waivers:

a. An Off-Menu Incentive to allow a reduction in the required north side yard setback to allow five feet in lieu of the otherwise required eight feet in the [Q]C2-1 Zone.

b. An Off-Menu Incentive to allow a reduction in the required south side yard setback to allow five feet in lieu of the otherwise required eight feet in the [Q]C2-1 Zone.

c. A Waiver of Development Standards to allow an increase in Floor Area Ratio (FAR) to 3.25:1 in lieu of the 1.5:1 FAR otherwise allowed in the [Q]C2-1 Zone.

d. A Waiver of Development Standards to allow a height increase of 56-feet in lieu of the 45-feet or three stories otherwise required in the [Q]C2-1 Zone.

### **RECOMMENDED ACTIONS:**

- 1. **DETERMINE** that based on the whole of the administrative record, that the Project is exempt from CEQA pursuant to CEQA Guidelines, Article 19, Section 15332 (Class 32 Infill Development), and there is no substantial evidence demonstrating that an exception to a categorical exemption pursuant to CEQA Guidelines, Section 15300.2 applies.
- 2. **Approve,** pursuant to LAMC Section 12.22 A.25, a Density Bonus Compliance Review for a Housing Development Project totaling 9 dwelling units and setting aside 11 percent (1 unit) as Very Low Income Restricted Affordable Units for a period of 55 years, with the following requested incentives and waivers:
  - a. An Off-Menu Incentive to allow a reduction in the required north side yard setback to allow five feet in lieu of the otherwise required eight feet in the [Q]C2-1 Zone.
  - b. An Off-Menu Incentive to allow a reduction in the required south side yard setback to allow five feet in lieu of the otherwise required eight feet in the [Q]C2-1 Zone.
  - c. A Waiver of Development Standards to allow an increase in Floor Area Ratio (FAR) to 3.25:1 in lieu of the 1.5:1 FAR otherwise allowed in the [Q]C2-1 Zone.
  - d. A Waiver of Development Standards to allow a height increase of 56-feet and five (5) stories in lieu of the 45-feet or three stories otherwise required in the [Q]C2-1 Zone.

VINCENT P. BERTONI, AICP Director of Planning

Theodore L. Arving

Theodore L. Irving, AICP, Principal Planner

Kyle Winston, City Planner

Connie Chauv

Connie Chauv, Senior City Planner

Isaiah Ross, City Planning Associate (213) 238-7731 Isaiah.ross@lacity.org

**ADVICE TO PUBLIC:** \*The exact time this report will be considered during the meeting is uncertain since there may be several other items on the agenda. Written communications may be mailed to the *Commission Secretariat, Room 273, City Hall, 200 North Spring Street, Los Angeles, CA 90012* (Phone No. 213-978-1300). While all written communications are given to the Commission for consideration, the initial packets are sent to the week prior to the Commission's meeting date. If you challenge these agenda items in court, you may be limited to raising only those issues you or someone else raised at the public hearing agendized herein, or in written correspondence on these matters delivered to this agency at or prior to the public hearing. As a covered entity under Title II of the Americans with Disabilities Act, the City of Los Angeles does not discriminate on the basis of disability, and upon request, will provide reasonable accommodation to ensure equal access to these programs, services and activities. Sign language interpreters, assistive listening devices, or other auxiliary aids and/or other services may be provided upon request. To ensure availability of services, please make your request not later than three working days (72 hours) prior to the meeting by calling the Commission Secretariat at (213) 978-1300.

### TABLE OF CONTENTS

Project Analysis A-1
Project Summary Background Requested Actions Issues Conclusion
Conditions of Approval C-1
FindingsF-1
Public Hearing and CommunicationsP-1
Exhibits:
Exhibit A – Project Plans
Exhibit B – Maps – Vicinity, Radius, ZIMAS
Exhibit C – Site Photos
Exhibit D – Agency Comments

- Exhibit E Notice of Exemption
- Exhibit F Public Correspondence

### PROJECT ANALYSIS

### PROJECT SUMMARY

The project is the construction, use, and maintenance of a five-story, 9-unit residential development including one (1) unit set aside for a Very Low Income Household, with zero vehicular parking spaces and a total of 1,575 square feet of common open space. The project includes a mix of three (3) five-bedroom units, five (5) four-bedroom units, and one (1) three-bedroom unit. There are no protected trees on the subject property and there are no protected street trees. The project will be approximately 15,972 square feet in floor area with a Floor Area Ratio ("FAR") of 3.25:1. The site is currently improved with a one-story, 2,500 square foot commercial retail building and surface parking lot in the rear of the lot which will be demolished for the project.

### BACKGROUND

### Subject Property

The property is rectangularly shaped, consisting of two parcels, approximately 7,029 square-feet (0.161 net acres). The property has approximately 50 feet of frontage along the west side of Sawtelle Boulevard with a uniform depth of approximately 140 feet, with an approximately 15-foot wide alley to the rear. The site is currently improved with one-story commercial retail building and a surface parking lot which will be demolished for the project.

#### Zoning and Land Use Designation

The project site is located in the West Los Angeles Community Plan and is designated for Neighborhood Commercial land uses, with corresponding zones of C1, C1.5, C2, C4, RAS3, RAS4, and P. The site is zoned [Q]C2-1 and is consistent with the land use designation. The site is subject to Qualified "Q" Conditions limiting the site to C1 uses and a building height of 3 stories and 45 feet (Ordinance No. 166311) and is also subject to a Building Line of 10 feet along Sawtelle Boulevard (Ordinance No. 73,915). The site is located within the West Los Angeles Transportation Improvement and Mitigation Specific Plan (ZI 2192), which is regulated by the Los Angeles Department of Transportation. The site is also located in the Aquist – Priolo Earthquake Fault zone (ZI 2441) and Preliminary Fault Rupture Study Area (ZI 2442); and is listed on the Housing Element Inventory of Sites (ZI – 2512). Projects within a Preliminary Fault Study Rupture Area and/or the Alquist-Priolo Earthquake Fault Zone are required to comply with the fault investigation requirements of the Alquist-Priolo Earthquake Fault Zone (ZI 2427), the Al Fresco Ordinance within Planning Overlay (ZI 2517), and the Transit Priority Area in the City of Los Angeles (ZI 2452).

### Surrounding Uses

The surrounding neighborhood is characterized by multi-family residential and a variety of commercial uses up to four (4) stories in height. The property adjacent to the east along Sawtelle Boulevard is zoned [Q]C2-1 and is developed with a surface parking lot and 1-story senior healthcare facility. The property adjacent to the north abutting the subject site is zoned [Q]C2-1 and is developed with a two-story multi-family residential building. The property adjacent to the south abutting the subject site is zoned [Q]C2-1 and is developed with a three-story building with creative office space and semi-subterranean parking. The property adjacent to the west is located across an existing alley and is zoned [Q]R3-1 and is developed with a two-story multi-family residential building including semi-subterranean parking.

<u>Sawtelle Boulevard</u> is designated by the Mobility Plan 2035 as a Collector Street, with a designed Right-of-Way width of 66 feet and roadway width of 40 feet, and is currently dedicated to a 62-foot right-of-way and improved with a 40-foot roadway, with concrete curb, gutter, and sidewalk.

Alley, to the rear, is 15 feet in width.

### Relevant Cases and Building Permits

### Subject Site:

<u>Building Permit No. 22010-10000-06482</u>: On December 27, 2022, the applicant applied for a Building Permit with the Los Angeles Department of Building and Safety for a new five-story nineunit affordable housing project. The permit application is pending and the permit was not issued at the time of preparing this report.

### Surrounding Sites:

CPC-2022-3679-DB-VCU-MCUP-SPR-HCA: The subject site is located at 11332 West Santa Monica Boulevard. The project proposes a mixed-use development consisting of a total of 926 residential units, 32,761 square feet of commercial (retail/.restaurant) uses, 76,052 square feet of municipal office uses, and 23,615 square feet of institutional/recreational uses. The project proposes to demolish existing uses within the project site, including the West Los Angeles Courthouse building, the Municipal building, and the Felicia Manhood Multipurpose Center.

### HOUSING REPLACEMENT

Pursuant to Government Code Section 65915(c)(3), applicants of Density Bonus projects filed as of January 1, 2015 must demonstrate compliance with the housing replacement provisions which require replacement of rental dwelling units that either exist at the time of application of a Density Bonus project, or have been vacated or demolished in the five-year period preceding the application of the project. This applies to all pre-existing units that have been subject to a recorded covenant, ordinance, or law that restricts rents to levels affordable to persons and families of lower or very low income; subject to any other form of rent or price control; or occupied by Low or Very Low-Income Households. Pursuant to the Determination made by the Los Angeles Housing Department (LAHD) dated November 15, 2022, LAHD determined that since at least September 2017, the Property has been single-story commercial stores. The replacement provisions of SB 8 do not apply to commercial properties if there are no residential dwelling units(s) that exist or have existed on the property for the past five (5) years. Further, this development does not require the demolition of any prohibited types of housing, therefore, no SB 8 replacement affordable units are required.

### **REQUESTED ACTIONS**

### Density Bonus / Affordable Housing Incentives Program

In accordance with California State Law (including Senate Bill 1818, and Assembly Bills 2280, 2222, and 2556), the applicant is proposing to utilize LAMC Section 12.22 A.25 (Affordable Housing Incentives – Density Bonus) to set aside one (1) dwelling unit for Very Low Income household occupancy for a period of 55 years. Because the applicant is providing 11 percent of

base 9 dwelling units to be affordable for Very Low Income household occupancy, the project is eligible for two (2) Density Bonus Incentives.

### Off-Menu Incentives

As a result of setting aside 11 percent (1 dwelling unit) of the base 9 dwelling units as a Restricted Affordable Unit for Very Low Income Households, the applicant requests two (2) Off-Menu Density Bonus Incentives, as follows:

- a. An Off-Menu Incentive to allow a reduction in the required north side yard setback to allow five feet in lieu of the otherwise required eight feet in the [Q]C2-1 Zone.
- b. An Off-Menu Incentive to allow a reduction in the required south side yard setback to allow five feet in lieu of the otherwise required eight feet in the [Q]C2-1 Zone.

### Waivers of Development Standards

As mentioned above, a project that provides 11 percent of its base units for Very Low Income Households qualifies for two (2) Incentives, but may request other "waiver[s] or reduction[s] of development standards that will have the effect of physically precluding the construction of a development meeting the [affordable set-aside percentage] criteria of subdivision (b) at the densities or with the concessions or incentives permitted under [State Density Bonus Law]" (Government Code Section 65915(e)(1)), in conjunction with a Density Bonus Project. Given that the project is utilizing all two (2) Density Bonus Incentives, the applicant requests two (2) Waivers of Development Standards, as follows:

- c. A Waiver of Development Standards to allow an increase in Floor Area Ratio (FAR) to 3.25:1 in lieu of the 1.5:1 FAR otherwise allowed in the [Q]C2-1 Zone.
- d. A Waiver of Development Standards to allow a height increase of 56-feet in lieu of the 45-feet otherwise required in the C2-1 Zone.

### <u>CEQA</u>

The Department of City Planning determined based on the whole of the administrative record, that the Project is exempt from CEQA pursuant to California Environmental Quality Act ("CEQA") Guidelines, an Exemption from CEQA pursuant to CEQA Guidelines, Article 19, Section 15332 (Class 32), and that there is no substantial evidence demonstrating that an exception to a categorical exemption pursuant to CEQA Guidelines, Section 15300.2 applies. The Notice of Exemption and Justification for Environmental Case No. ENV-2023-5658-CE is provided in the case file and attached as Exhibit E.

### **ISSUES**

### Public Hearing & Testimony

A public hearing was held by a Hearing Officer on behalf of the City Planning Commission on October 4, 2024. The public hearing was attended by the representative (Gary Benjamin) and approximately two (2) members from the community.

### Applicant Presentation:

The applicant's representative described the site location, project description, requested entitlements, and community outreach, which had been completed.

There were two (2) questions from the community raising concern about the potential impacts of construction of the building in proximity to high tension power wires along Sawtelle Boulevard and an inquiry about the construction process of the proposed project near the power lines. There was also a question about the demand for adequate parking for the project which has large dwelling units. The community wanted to know more about the applicant's proposal for zero parking.

The applicant responded noting that the project is intended for young professionals and students who may attend a nearby university or work at nearby employment centers. The applicant also mentioned that there are public parking facilities near the subject property and there is a public transit bus network that services the area. There is also metered parking on Sawtelle Boulevard. The applicant mentioned that he will utilize AB 2097 which does not require parking for the project. The applicant also shared that the project will include a front yard setback and the Los Angeles Department of Water and Power will provide an encroachment review to ensure that the proposed building is setback from the power lines on the street. He mentioned that although the power lines will not be placed underground, the project will be adequately setback from the proposed building.

### Urban Design Studio / Professional Volunteer Program

The proposed project was reviewed by the Department of City Planning, Urban Design Studio's Professional Volunteer Program (PVP) on April 16, 2024. The Resulting comments and suggestions focus primarily on the pedestrian experience, 360-degree design, and climate adaptive design. The following includes a discussion of UDS comments and suggestions and the applicant's response.

### Pedestrian First Design

• Ensure all units comply with ADA requirements, addressing issues such as door swings, shower valve accessibility, and space to maneuver.

The applicant responded that all units will comply with ADA requirements

### <u>360 Degree Design</u>

- Review front and rear setback and building line requirements to ensure compliance.
- Review the design of "stair number 3" as shown on the roof plan and its combination with auditorium seating for code compliance.
- Consider the design and layout of residential units to provide functional living and sleeping areas.
- Update plans to reconfigure the trash and recycling room layout, possibly moving the elevator.
- Update plans to correct elevator location, which appears to be inconvenient and hidden to residents.
- Update plans to correct discrepancies between the site plan and exterior elevations.
- Continue to explore alternative locations for transformer vault. DWP will generally try to supply up to 800A of electric service from transformers on the street at 120/240V three phase with off-site improvements as needed sometimes at a cost. If more capacity is needed, an on-site transformer can be installed at a grade up to 1200A at 120/208V, 3 phase or below grade in underground transformer vaults. The smaller G284 vault can supply up to 1200A, 120/240V, 3 phase and the larger H222 can supply up to 2000A at 120/208V, 3 phase.

The applicant responded that the project complies with building line and rear setback requirements. The applicant noted that architectural stairs not used for required egress are allowed to provide access to the roof through a recreation room; the unit layouts are designed to maximize bedroom space while providing required common areas, accessible restrooms, and kitchen; and the location of trash rooms and elevator are to maximize unit count and size. The applicant responded that an underground transformer is not required and is cost-prohibitive, and that alley access for on-grade transformers is allowed and hidden from the Sawtelle frontage.

### Climate Adapted Design

- Include solar panels on roof plan if feasible to meet current code
- Consider different tree selection other then 'Desert Museum Palo Verde' and planting palette to more appropriate species in relation to coastal location.

The applicant responded that the project was submitted to LADBS prior to the code change, and is therefore not required; and that the Palo Verde trees thrive in the Southern California climate and are attractive shade trees that require little water use.

### CONCLUSION

Based on the information submitted to the record, staff recommends that the City Planning Commission approve the construction of a 9-unit residential building with a Density Bonus Compliance Review and determine based on the whole of the administrative record, that the Project is exempt from CEQA pursuant to CEQA Guidelines, Article 19, Section 15332 (Infill Development), and that there is no substantial evidence demonstrating that an exception to a categorical exemption pursuant to CEQA Guidelines, Section 15300.2 applies.

### CONDITIONS OF APPROVAL

- 1. Site Development. The project shall be in substantial conformance with the plans and materials submitted by the Applicant, including the proposed building design elements and materials, stamped "Exhibit A," attached to the subject case file. No change to the plans will be made without prior review by the Department of City Planning, Project Planning Bureau, and written approval by the Director of Planning. Each change shall be identified and justified in writing. Minor deviations may be allowed in order to comply with the provisions of the Los Angeles Municipal Code or the project conditions.
- 2. **Residential Density**. The project shall be limited to a maximum density of 9 multi-family residential dwelling units, including On-Site Restricted Affordable Units.
- 3. **On-Site Restricted Affordable Units.** One (1) unit shall be reserved for Very Low Income household, as defined by the California Government Code 65915 and by the Los Angeles Housing Department (LAHD). In the event the SB 8 Replacement Unit condition requires additional affordable units or more restrictive affordability levels, the most restrictive requirements shall prevail.
- 4. **Changes in On-Site Restricted Units**. Deviations that increase the number of restricted affordable units or that change the composition of units or change parking numbers shall be consistent with LAMC Section 12.22 A.25.
- 5. Housing Requirements. Prior to issuance of a building permit, the owner shall execute a covenant to the satisfaction of the Los Angeles Housing Department (LAHD) to make one (1) unit available to Very Low Income Households or equal to 11 percent of the project's total base residential density allowed, for sale or rental, as determined to be affordable to such households by LAHD for a period of 55 years. In the event the applicant reduces the proposed density of the project, the number of required reserved on-site Restricted Units may be adjusted, consistent with LAMC Section 12.22 A.25, to the satisfaction of LAHD, and in consideration of the project's Replacement Unit Determination. Enforcement of the terms of said covenant shall be the responsibility of LAHD. The Applicant shall submit a copy of the recorded covenant to the Department of City Planning for inclusion in this file. The project shall comply with the Guidelines for the Affordable Housing Incentives Program adopted by the City Planning Commission and with any monitoring requirements established by the LAHD.
- 6. Floor Area Ratio (Incentive). The project total Floor Area shall be limited to 15,972 square feet and a 3.25:1 FAR.
- 7. **Height (Waiver)**. The project shall be limited to a maximum height of 56 feet and five (5) stories per Exhibit "A".
- 8. Setback (Incentive). The project shall have a minimum 5-foot northerly side yard setback.
- 9. Setback (Waiver). The project shall have a minimum 5-foot southerly side yard setback.
- 10. **Parking Per AB 2097**. The project shall be permitted to provide a minimum of zero parking spaces pursuant to California Government Code Section 65863.2 (AB 2097).
- 11. **Bicycle Parking.** Bicycle parking shall be provided consistent with LAMC 12.21 A.16 and Exhibit "A".

- 12. Landscape Plan. The landscape plan shall indicate landscape points for the project equivalent to **10% more than otherwise required** by LAMC 12.40 and Landscape Ordinance Guidelines "O". All open areas not used for buildings, driveways, parking areas, recreational facilities or walks shall be attractively landscaped, including an automatic irrigation system, and maintained in accordance with a landscape plan prepared by a licensed landscape architect or licensed architect, and submitted for approval to the Department of City Planning.
- 13. **Soil Depths.** Shrubs, perennials, and groundcover shall require a minimum soil depth as follows:
  - a. A minimum depth with a height ranging from 15 to 40 feet shall be 42 inches.
  - b. A minimum depth with a height ranging from 1 to 15 feet shall be 24 to 36 inches.
  - c. A minimum depth with a height of less than 1 foot shall be 18 inches.
  - d. A minimum depth of an extensive green roof shall be 3 inches.

Trees shall require a 42-inch minimum soil depth. Further, the minimum amount of soil volume for tree wells on the rooftop or any above grade open spaces shall be based on the size of the tree at maturity:

- e. 220 cubic feet for trees with a canopy diameter ranging from 15 to 19 feet.
- f. 400 cubic feet for trees with a canopy diameter ranging from 20 to 24 feet.
- g. 620 cubic feet for trees with a canopy diameter ranging from 25 to 29 feet.
- h. 900 cubic feet for trees with a canopy diameter ranging from 30 to 34 feet.

### 14. Street Trees.

- a. New street trees shall be planted within the public right-of-way, where feasible, at a ratio of at least one (1) tree for every 25 feet of lot length, to the satisfaction of the Bureau of Street Services, Urban Forestry Division, Department of Public Works.
- b. Project shall preserve all healthy mature street trees whenever possible. All feasible alternatives in project design should be considered and implemented to retain healthy mature street trees. A permit is required for the removal of any street tree and shall be replaced 2:1 as approved by the Board of Public Works and Urban Forestry Division.
- a. Plant street trees at all feasible planting locations within dedicated streets as directed and required by the Bureau of Street Services, Urban Forestry Division. All tree plantings shall be installed to current tree planting standards when the City has previously been paid for tree plantings. The subdivider or contractor shall notify the Urban Forestry Division at: (213) 847-3077 upon completion of construction for tree planting direction and instructions.
- 15. **Stormwater/irrigation.** The project shall implement on-site stormwater infiltration as feasible based on the site soils conditions, the geotechnical recommendations, and the City of Los Angeles Department of Building and Safety Guidelines for Storm Water Infiltration. If on-site infiltration is deemed infeasible, the project shall analyze the potential for stormwater capture and reuse for irrigation purposes based on the City Low Impact Development (LID) guidelines.
- 16. Lighting. All pedestrian walkways and vehicle access points will be well-lit. All outdoor lighting will be shielded to prevent excessive illumination and mitigate light impacts on adjacent residential properties and the public right-of-way. Utilize adequate, uniform, and glare-free

lighting, such as dark-sky compliant fixtures, to avoid uneven light distribution, harsh shadows, and light spillage.

- 17. Lighting Design. Areas where nighttime uses are located shall be maintained to provide sufficient illumination of the immediate environment so as to render objects or persons clearly visible for the safety of the public and emergency response personnel. All pedestrian walkways, storefront entrances, and vehicular access ways shall be illuminated with lighting fixtures. Lighting fixtures shall be harmonious with the building design. Wall mounted lighting fixtures to accent and complement architectural details at night shall be installed on the building to provide illumination to pedestrians and motorists.
- 18. **Heat Island Effect**. To reduce the heat island effect, a minimum of 50% of the area of pathways, patios, driveways or other paved areas shall use materials with a minimum initial Solar Reflectance value of 0.35 in accordance with ASTM (American Society of Testing Materials) standards.
- 19. **Solar and Electric Generator.** Generators used during the construction process shall be electric or solar powered. Solar generator and electric generator equipment shall be located as far away from sensitive uses as feasible.

Or: Where power poles are available, electricity from power poles and/or solar-powered generators rather than temporary diesel or gasoline generators shall be used during construction. (WL)

- 20. **Solar-ready Buildings.** The Project shall comply with the Los Angeles Municipal Green Building Code, Section 99.05.211, to the satisfaction of the Department of Building and Safety.
- 21. **Signage.** There shall be no off-site commercial signage on construction fencing during construction.

### Administrative Conditions

- 22. **Final Plans.** Prior to the issuance of any building permits for the project by the Department of Building and Safety, the applicant shall submit all final construction plans that are awaiting issuance of a building permit by the Department of Building and Safety for final review and approval by the Department of City Planning. All plans that are awaiting issuance of a building permit by the Department of Building and Safety shall be stamped by Department of City Planning staff "Plans Approved". A copy of the Plans Approved, supplied by the applicant, shall be retained in the subject case file.
- 23. **Notations on Plans.** Plans submitted to the Department of Building and Safety, for the purpose of processing a building permit application shall include all of the Conditions of Approval herein attached as a cover sheet and shall include any modifications or notations required herein.
- 24. **Approval, Verification and Submittals.** Copies of any approvals, guarantees or verification of consultations, review of approval, plans, etc., as may be required by the subject conditions, shall be provided to the Department of City Planning prior to clearance of any building permits, for placement in the subject file.
- 25. **Code Compliance.** Use, area, height, and yard regulations of the zone classification of the subject property shall be complied with, except where granted conditions differ herein.

- 26. **Department of Building and Safety.** The granting of this determination by the Director of Planning does not in any way indicate full compliance with applicable provisions of the Los Angeles Municipal Code Chapter IX (Building Code). Any corrections and/or modifications to plans made subsequent to this determination by a Department of Building and Safety Plan Check Engineer that affect any part of the exterior design or appearance of the project as approved by the Director, and which are deemed necessary by the Department of Building and Safety for Building Code compliance, shall require a referral of the revised plans back to the Department of City Planning for additional review and sign-off prior to the issuance of any permit in connection with those plans.
- 27. **Enforcement.** Compliance with these conditions and the intent of these conditions shall be to the satisfaction of the Department of City Planning.

### 28. Indemnification and Reimbursement of Litigation Costs.

Applicant shall do all of the following:

- (i) Defend, indemnify and hold harmless the City from any and all actions against the City relating to or arising out of, in whole or in part, the City's processing and approval of this entitlement, including <u>but not limited to</u>, an action to attack, challenge, set aside, void, or otherwise modify or annul the approval of the entitlement, the environmental review of the entitlement, or the approval of subsequent permit decisions, or to claim personal property damage, including from inverse condemnation or any other constitutional claim.
- (ii) Reimburse the City for any and all costs incurred in defense of an action related to or arising out of, in whole or in part, the City's processing and approval of the entitlement, including but not limited to payment of all court costs and attorney's fees, costs of any judgments or awards against the City (including an award of attorney's fees), damages, and/or settlement costs.
- (iii) Submit an initial deposit for the City's litigation costs to the City within 10 days' notice of the City tendering defense to the Applicant and requesting a deposit. The initial deposit shall be in an amount set by the City Attorney's Office, in its sole discretion, based on the nature and scope of action, but in no event shall the initial deposit be less than \$50,000. The City's failure to notice or collect the deposit does not relieve the Applicant from responsibility to reimburse the City pursuant to the requirement in paragraph (ii).
- (iv) Submit supplemental deposits upon notice by the City. Supplemental deposits may be required in an increased amount from the initial deposit if found necessary by the City to protect the City's interests. The City's failure to notice or collect the deposit does not relieve the Applicant from responsibility to reimburse the City pursuant to the requirement in paragraph (ii).
- (v) If the City determines it necessary to protect the City's interest, execute an indemnity and reimbursement agreement with the City under terms consistent with the requirements of this condition.

The City shall notify the applicant within a reasonable period of time of its receipt of any action and the City shall cooperate in the defense. If the City fails to notify the applicant of any claim, action, or proceeding in a reasonable time, or if the City fails to reasonably cooperate in the defense, the applicant shall not thereafter be responsible to defend, indemnify or hold harmless the City.

The City shall have the sole right to choose its counsel, including the City Attorney's office or outside counsel. At its sole discretion, the City may participate at its own expense in the defense of any action, but such participation shall not relieve the applicant of any obligation imposed by this condition. In the event the Applicant fails to comply with this condition, in whole or in part, the City may withdraw its defense of the action, void its approval of the entitlement, or take any other action. The City retains the right to make all decisions with respect to its representations in any legal proceeding, including its inherent right to abandon or settle litigation.

For purposes of this condition, the following definitions apply:

"City" shall be defined to include the City, its agents, officers, boards, commissions, committees, employees, and volunteers.

"Action" shall be defined to include suits, proceedings (including those held under alternative dispute resolution procedures), claims, or lawsuits. Actions includes actions, as defined herein, alleging failure to comply with <u>any</u> federal, state or local law.

Nothing in the definitions included in this paragraph are intended to limit the rights of the City or the obligations of the Applicant otherwise created by this condition.

### FINDINGS

### DENSITY BONUS / AFFORDABLE HOUSING INCENTIVES PROGRAM FINDINGS

- 1. Government Code Section 65915 and LAMC Section 12.22 A.25(c) state that the Commission <u>shall approve</u> a density bonus and requested incentive(s) unless the Commission finds that:
  - a. The incentives do not result in identifiable and actual cost reductions to provide for affordable housing costs as defined in California Health and Safety Code Section 50052.5 or Section 50053 for rents for the affordable units.

The record does not contain substantial evidence that would allow the City Planning Commission to make a finding that the requested incentives do not result in identifiable and actual cost reduction to provide for affordable housing costs per State Law. The California Health & Safety Code Sections 50052.5 and 50053 define formulas for calculating affordable housing costs for very-low, low, and moderate-income households. Section 50052.5 addresses owner-occupied housing and Section 50053 addresses rental households. Affordable housing costs are a calculation of residential rent or ownership pricing not to exceed 25 percent gross income based on area median income thresholds dependent on affordability levels.

The applicant proposes to construct a total of nine (9) dwelling units, of which one (1) dwelling unit will be set aside for Very Low Income Household Occupancy for a period of 55 years. Density Bonus projects are eligible for two (2) incentives if they reserve at least 11 percent of base dwelling units for Very Low Income Households. Based on the set-aside of 11 percent of base units for Very Low Income households, the applicant is entitled to two (2) Incentives under both the Government Code and LAMC. Therefore, the two (2) Off-Menu Incentive requests and two (2) Waiver of Development Standards qualify as the proposed development's Incentives.

**Yards:** The subject site is zoned [Q]C2-1 which requires side yard setbacks of eight feet for a five-story building. The applicant has requested incentives for a reduction of the required north side yard setback and the south side yard setback to allow for minimum setbacks of 5 feet. As proposed, the reduced side yard setbacks will allow the developer to expand the building footprint, to allow for the construction of the affordable residential unit and floor area, whose rent will provide for the operational costs of the affordable unit. The requested incentive will allow the project to expand the building envelope so that additional units can be constructed, provide for design efficiencies and allow the overall space dedicated to residential uses to be increased.

b. The incentive(s) will have a specific adverse impact upon public health and safety, or on any real property that is listed in the California Register of Historical Resources and for which there are no feasible method to satisfactorily mitigate or avoid the specific adverse impact without rendering the development unaffordable to Very Low, Low and Moderate Income households. Inconsistency with the zoning ordinance or the general plan land use designation shall not constitute a specific, adverse impact upon the public health or safety (Government Code Section 65915(d)(1)(B) and 65589.5(d)).

There is no substantial evidence in the record that the proposed incentive(s) will have a specific adverse impact. A "specific adverse impact" is defined as, "a significant,

quantifiable, direct and unavoidable impact, based on objective, identified written public health or safety standards, policies, or conditions as they existed on the date the application was deemed complete" (LAMC Section 12.22 A.25(b)). As required by Section 12.22 A.25 (e)(2), the project meets the eligibility criterion that is required for density bonus projects. The project also does not involve a contributing structure in a designated Historic Preservation Overlay Zone or on the City of Los Angeles list of Historical-Cultural Monuments. The project is not located on a substandard street in a Hillside area or a Very High Fire Hazard Severity Zone. There is no evidence in the record which identifies a written objective health and safety standard that has been exceeded or violated. Therefore, there is no substantial evidence that the proposed incentive(s) will have a specific adverse impact on public health and safety, or on property listed in the California Register of Historic Resources. Based on the above, there is no basis to deny the requested incentives.

### c. The incentive(s) are contrary to state or federal law.

There is no evidence in the record that the proposed incentives are contrary to state or federal law.

2. The waiver[s] or reduction[s] of development standards relate to development standards that will not have the effect of physically precluding the construction of a development meeting the [affordable set-aside percentage] criteria of subdivision (b) at the densities or with the concessions or incentives permitted under [State Density Bonus Law] (Government Code Section 65915(e)(1))

A project that meets the requirements of Government Code Section 65915 may request other "waiver[s] or reduction[s] of development standards that will have the effect of physically precluding the construction of a development meeting the [affordable set-aside percentage] criteria of subdivision (b) at the densities or with the concessions or incentives permitted under [State Density Bonus Law]" (Government Code Section 65915(e)(1)).

Therefore, the request for the following is recommended as Waivers of Development Standards. Without the below Waivers, the existing development standards would physically preclude development of the base units, build out of the incentives, and project amenities:

Floor Area Ratio: The subject site is zoned [Q]C2-1 which limits the FAR to 1.5:1. The applicant has requested an increase in FAR of 3.25:1 (15,972 square feet of floor area). The project is for the construction of 15,972 square feet of floor area across five stories and an average of 3,194 square feet of floor area for each floor. Limiting the project to a 1.5:1 FAR would only allow the construction of two stories with a total of four dwelling units. The requested incentive will allow the developer to accommodate the intended level of density. including the construction of the Restricted Affordable unit, and the necessary circulation and common amenity space. The limitation of the maximum allowed FAR of 1.5 would limit the ability to provide space for the construction of the residential dwelling units permitted by-right and the Restricted Affordable Unit which is of a sufficient size. The ability to develop larger units will increase the revenues from the market-rate units, which will lower the marginal cost of developing the affordable units. The additional floor area will allow certain fixed costs involved in the construction of new residential units to be spread over more floor area thereby reducing the per square foot build cost of the development. As proposed, the additional FAR will allow for the construction of the affordable residential unit. The requested incentive will allow the developer to expand the building envelope which ensures that all units are of habitable size and the overall space dedicated to residential units is increased.

FAR by-right	Buildable Lot Area	Base Floor Area (sf)
1.5:1	7,029	7,029 x 1.5 = <b>10,543</b>
FAR Requested	Requested Floor Are	ea Additional Floor Area (sf)
3.25:1	15,972	15,972 – 10,543 = <b>5,429</b>

**Height**: The subject site is zoned [Q]C2-1, with a Height District No. 1 that permits a maximum 45-foot building height or three stories. The applicant is requesting a Waiver of Development Standard for an 11-foot height increase to allow a maximum height of 56 feet, which will allow for the construction of an additional unit and required open space amenities. The imposition of the 45-foot height limit would physically preclude development of the intended level of density with the required open space amenities. Utilization of the height increase to allow a maximum height of the proposed project would lose one (1) unit, conference room and recreation room. The requested Waiver of Development Standard facilitates the provision of one (1) Very Low Income unit by allowing one (1) additional story of residential and open space uses that could not be constructed under the normally required 45-foot height limit.

### **CEQA FINDINGS**

The Categorical Exemption prepared for the proposed project is appropriate pursuant to CEQA Guidelines, Article 19, Section 15332, and there is no substantial evidence demonstrating that an exception to a categorical exemption pursuant to CEQA Guidelines, Section 15300.2 applies.

## a. The project is consistent with the applicable General Plan designation and all applicable General Plan policies as well as with applicable zoning designation and regulations:

The subject site is located within the West Los Angeles Community Planning Area and is designated for Neighborhood Commercial land uses, with corresponding zones of C1, C1.5, C2, C4, RAS3, RAS4, and P. The site is zoned [Q]C2-1 and is consistent with the land use designation. The proposed project is for the construction of a five-story, multi-family residential building with 9 dwelling units, totaling 15,972 square feet of floor area on an approximately 7,029 square-foot lot. The project will not provide automobile parking spaces on the subject site. Additionally, a total of 10 bicycle parking spaces are included in the project. As such, the project is consistent with the applicable West Los Angeles Community Planning Area designation and policies and all applicable zoning designations and regulations in combination with State Density Bonus Law.

The site is located in the Alquist-Priolo Earthquake Fault zone (ZI 2441) and Preliminary Fault Rupture Study Area (ZI 2442); and is listed on the Housing Element Inventory of Sites (ZI – 2512). Projects within a Preliminary Fault Study Rupture Area and/or the Alquist-Priolo Earthquake Fault Zone are required to comply with the fault investigation requirements of the Alquist-Priolo Earthquake Fault Zone Act. The applicant has submitted a Geotechnical Engineering, Engineering Geologic Investigation and Seismic Fault Evaluation Report, prepared by Environmental Geotechnology Laboratory, Inc., dated March 24, 2023. RCMs also include the submittal of the Geology and Soils Report to the Department of Building and Safety ("DBS"), and compliance with a Soils Report Approval Letter (Log No. 124355, dated May 4, 2023 which details conditions of approval that must be followed. In addition, the RCMs require that design and construction of the building must conform to the California Building

Code, and grading on site shall comply with the City's Landform Grading Manual, as approved by the Department of Building and Safety Grading Division.

## b. The proposed development occurs within city limits on a project site of no more than five acres substantially surrounded by urban uses:

The subject site consists of a level, rectangular site measuring 0.161 acres and is wholly within the City of Los Angeles. The surrounding neighborhood is characterized by multi-family residential and a variety of commercial uses up to four (4) stories in height. The property adjacent to the east along Sawtelle Boulevard is zoned [Q]C2-1 and is developed with a surface parking lot and 1-story senior healthcare facility. The property adjacent to the north abutting the subject site is zoned [Q]C2-1 and is developed with a two-story multi-family residential building. The property adjacent to the south abutting the subject site is zoned [Q]C2-1 and is developed with a three-story building with creative office space and semi-subterranean parking. The property adjacent to the west is located across an existing alley and is zoned [Q]R3-1 and is developed with a two-story multi-family residential building.

### c. The project site has no value as habitat for endangered, rare or threatened species:

The subject property is currently developed with a one-story, commercial building and an associated surface parking lot located at the rear of the property proposed to be demolished. Further, the subject property is surrounded by existing commercial and residential properties. According to the Tree Disclosure Statement dated July 21, 2023 and signed by the Property Owner Donghao Li, there are no protected trees and shrubs on the subject site and there are no existing street trees. Therefore, the subject site is not, and has no value as a habitat for endangered, rare, or threatened species.

## d. Approval of the project would not result in any significant effects relating to traffic, noise, air quality, or water quality:

The project will be subject to Regulatory Compliance Measures (RCMs), which require compliance with the City of Los Angeles Noise Ordinance, pollutant discharge, dewatering, stormwater mitigations, and Best Management Practices for stormwater runoff. These RCMs will reduce any potential impacts to less than significant and will ensure the project will not have significant impacts on noise and water. The project will not alter or encroach upon any water sources and construction of the proposed project will be on a property that is surrounded by more dense projects and will not create impacts to water quality.

Furthermore, The Department of Transportation (LADOT) Referral Form dated April 15, 2024 and the Vehicle Miles Traveled (VMT) calculator indicated that the number of daily vehicle trips will be 39 which is under the threshold of 250 or more daily vehicles trips to require VMT analysis. As such, the project will not have any significant impacts to traffic. In regards to Air Quality, the proposed project for 9 residential dwelling units is not expected to result in a cumulatively considerable net increase of any criteria pollutant for which the air basin is non attainable under an applicable federal or state ambient air quality standard. Interim thresholds were developed by the Los Angeles Department of City Planning staff based on California Emissions Estimator Model (CalEEMod) runs relying on reasonable assumptions, consulting with AQMD staff, and surveying published air quality studies for which criteria air pollutants did not exceed the established SCAQMD construction and operational thresholds. The proposed projects includes less than 80 residential dwelling units, less than 75,000 square feet of non-residential uses, and will import/export less than 1,000 cubic yards of soil, therefore, the project is not required to provide an Air Quality study.

### e. The site can be adequately served by all required utilities and public services:

The site is currently being served by the City of Los Angeles Department of Water and Power, the City's Bureau of Sanitation, the Los Angeles Police Department, the Los Angeles Fire Department, and other public service agencies. The utilities and public services have been servicing the neighborhood continuously for over 70 years. In addition, the California Green Code requires new construction to meet stringent efficiency standards for both water and power, such as high-efficiency toilets, dual-flush water closets, minimum irrigation standards, LED lighting, etc.

As a result of these new building codes that are required of all projects, it can be anticipated that the project will not create any impact on existing utilities and public services.

The project can be characterized as in-fill development within an urbanized area and meets the five conditions listed above. Therefore, the project qualifies for a Class 32 Categorical Exemption consistent with the California Environmental Quality Act.

### Exceptions Narrative for Class 32 Categorical Exemption

There are five (5) Exceptions which must be considered in order to find a project exempt under Class 32:

**a.** Cumulative Impacts. All exemptions for these classes are inapplicable when the cumulative impact of successive projects of the same type in the same place, over time is significant.

There is no cumulative impact of successive projects of the same type in the same place as the proposed project.

**b.** Significant Effect Due to Unusual Circumstances. A categorical exemption shall not be used for an activity where there is a reasonable possibility that the activity will have a significant effect on the environment due to unusual circumstances.

The proposed project is for the construction of a five-story, multi-family residential building with 9 dwelling units, totaling 15,972 square feet of floor area on an approximately 7,029 square-foot lot in the [Q]C2-1 Zone. All surrounding properties are developed with commercial and residential buildings. The subject site is of similar size and massing to nearby properties. There are no known unusual circumstances which may lead to a significant effect on the environment.

**c.** Scenic Highways. A categorical exemption shall not be used for a project which may result in damage to scenic resources, including but not limited to, trees, historic buildings, rock outcroppings, or similar resources, within a highway officially designated as a state scenic highway.

The only State Scenic Highway within the City of Los Angeles is the Topanga Canyon State Scenic Highway, State Route 27, which travels through a portion of Topanga State Park. The portion of State Route 27 which travels through the Los Angeles city limits is approximately 20 miles from the subject site. Therefore, the subject site will not create any impacts within a highway designated as a state scenic highway.

**d.** Hazardous Waste Sites. A categorical exemption shall not be used for a project located on a site which is included on any list complied pursuant to Section 65962.5 of the Government Code

According to Envirostor, the State of California's database of Hazardous Waste Sites, neither the subject site, nor any site within a 1,000-foot radius of the subject site, is identified as a hazardous waste site.

e. Historical Resources. A categorical exemption shall not be used for a project which may cause a substantial adverse change in the significance of a historical resource

The project site is developed and has not been identified as a historic resource by local or state agencies, and the project site has not been determined to be eligible for listing in the National Register of Historic Places, California Register of Historical Resources, the Los Angeles Historic-Cultural Monuments Register, and/or any local register. Further, the project site was not found to be a potential historic resource based on the City's HistoricPlacesLA website or SurveyLA, the citywide survey of Los Angeles. Neither the State nor the City choose to treat the site as a historic resource, therefore, the proposed project cannot cause a substantial adverse change in the significance of a historical resource and this exception does not apply.

### PUBLIC HEARING AND COMMUNICATIONS

### **PUBLIC HEARING**

The public hearing was held on October 4, 2024 at approximately 9:00 a.m. Due to concerns over COVID-19, the Public Hearing was conducted in a virtual format. The hearing was conducted by the Hearing Officer, Isaiah Ross, on behalf of the City Planning Commission in taking testimony for Case No. CPC-2023-5657-DB-HCA and ENV-2023-5658-CE. All interested parties were invited to attend the public hearing at which they could listen, ask questions, or present testimony regarding the project. The purpose of the hearing was to obtain testimony from affected and/or interested parties regarding this application. Interested parties are also invited to submit written comments regarding the request prior to the hearing. The environmental analysis was among the matters to be considered at the hearing. The hearing notice was mailed on September 3, 2024, published in the newspaper on September 17, 2024 and was posted on-site on September 17, 2024, in accordance with LAMC noticing requirements. The courtesy notice was mailed on November 22, 2024 in accordance with LAMC noticing requirements. The public hearing was attended by the representative (Gary Benjamin) and approximately one (1) member from the community.

### Applicant Presentation:

The applicant's representative described the site location, project description, requested entitlements, and community outreach, which had been completed. The applicant's representative mentioned that the subject site is eligible for the Transit Oriented Communities (TOC) Tier 2 Affordable Housing Incentive Program. The project was originally proposed with TOC incentive requests, however, due to TOC eligibility updates, the applicant representative filed for the Off-Menu Density Bonus Affordable Housing Incentive Program.

There were two (2) questions from the community raising concern about the potential impacts of construction of the building in proximity to high tension power wires along Sawtelle Boulevard and an inquiry about the construction process of the proposed project near the power lines. There was also a question about the demand for adequate parking for the project which has large dwelling units. The community wanted to know more about the applicant's proposal for zero parking.

The applicant responded noting that the project is intended for young professionals and students who may attend a nearby university or work at nearby employment centers. The applicant also mentioned that there are public parking facilities near the subject property and there is a public transit bus network that services the area. There is also metered parking on Sawtelle Boulevard. The applicant mentioned that he will utilize AB 2097 which does not require parking for the project. The applicant also shared that the project will include a front yard setback and the Los Angeles Department of Water and Power will provide an encroachment review to ensure that the proposed building is setback from the power lines on the street. He mentioned that although the power lines will not be placed underground, the project will be adequately setback to avoid impact.

### WRITTEN CORRESPONDENCE

The West Los Angeles Sawtelle Neighborhood Council made a motion on June 26, 2024 to approve the project located at 1531 South Sawtelle Boulevard as presented by the applicant, with one abstention due to the negative impact that market rate co-living represents to meaningfully affordable, family-sized units in Sawtelle. The West Los Angeles Sawtelle Neighborhood Council voted 11-1-1 to approve the motion.

Staff received two (2) letters of opposition from one of the community members in attendance at the public meeting raising concern about the potential impacts of zero proposed parking and construction of the building in proximity to the LADWP power lines on Sawtelle Boulevard. A second letter of opposition is from a community member who lives at 1525 Sawtelle Boulevard, adjacent to the subject property, and would like the property restored to commercial retail uses, has concerns about the lack of parking available in the area and on the subject property, and has concerns about the property being used for disposal and storage of unwanted items. The letters have been attached to the case file (Exhibit F).

1531-1535 S. SAWTELLE BOULEVARD



1531-1535 S. SAW ENTITLMENTS NOVEMBER 2023



I Z Z Z

ABBREVIATIO	ONS	SYMBOLS
A.F.F.	ABOVE FINISH FLOOR	
ADJ	ADJACENT	
AD	AREA DRAIN	
ALUM.		(A401
AUD BLDG	AUDITORIUM BUILDING	
BLDG	BELOW	
BM	BEAM	
BOT	BOTTOM	
C. WALL	CURTAIN WALL	ATOT
CONST	CONSTRUCTION	
CONT DIM	CONTINUOUS DIMENSION	(C) (B) (A) (C) (C) (C) (C) (C) (C) (C) (C) (C) (C
DKG	DECKING	
DR	DOOR	
DWG	DRAWING	
EL	ELEVATION	100
ELEC EP	ELECTRICAL ELECTRICAL PANEL	
Er EX, (E)	EXISTING	
EXT	EXTERIOR	$\frown$
EXTR.	EXTRUDED	(02)
F.B.O.	FURNISHED BY OTHERS	
F.D.	FLOOR DRAIN	<02 02
F.E.C. F.F.	FIRE EXTINGUISHER CABINET FINISH FLOOR	$\sim$
F.F.L.	FINISH FLOOR LINE	$\left< \begin{array}{c} 02 \\ 2.2 \end{array} \right>$
F.O.S.	FACE OF STUDS	↓ ↓
F.R.	FIRE RATED	
F.S.	FINISH STRUCTURE	A401
FLR	FLOOR	
flur FND	FLOURESCENT FOUNDATION	
FP'G	FIREPROOFING	
FR	FRAME(ED), (ING)	, A401
F.R.T.	FIRE RETARDANT TREATED	
F.P.	FIXED PANEL	● ST-I
FTG	FOOTING	
fur g.c.	FURRED,(ING)	
G.C. GA	GENERAL CONDITIONS GAUGE	+10'-0" T.O.P.
GV	GALVENIZED	1.0.1.1
GWB	GYPSUM WALL BOARD	
H.M.	HOLLOW METAL	+10'-0" F. CLG.
HVAC	HEATING, VENTILATION, & AIR CONDITIONING	
HOR	HORIZONTAL	+   0'-0"
INT	INTERIOR	Ψ
L.PT.	LOW POINT	Λ
LAM	LAMINATE	<u></u> 03
LW	LIGHTWEIGHT	
lwc Mas	LIGHTWEIGHT CONCRETE MASONRY	Ç
MECH	MECHANICAL	
MFR	MANUFACTURER	$\frown$
MIN	MINIMUM	
MK	ARCHITECTURAL MILLWORK	
MTL MTL PNL	METAL DANIEL	
(N)	METAL PANEL NEW	
N.C.	NO CEILING	1
N.I.C.	NOT IN CONTRACT	$\triangleleft$
N.W.P	NO WORL PROPOSED	
O.D.	OUTSIDE DIAMETER	
O.H. OPG	OPPOSITE HAND OPENING	
overhd	OVERHEAD	
PL	PROPERTY LINE	
PLSTR	PLASTER	<b>→</b> 2%
P. LAM	PLASTIC LAMINATE	2%
PLYWD	PLYWOOD	
ptd r.c.p	PAINTED REFLECTED CEILING PLAN	- OPEN TO
RAD	RADIUS	BEYOND -
REF	REFERENCE	<b>`</b>
REM	REMOVE	$\checkmark$
REV	REVERSE	$\nearrow$
req rf'g	REQUIRED ROOFING	I
R.O.	ROUGH OPENING	I
S.C.	SOLID CORE	5 5
SIM	SIMILAR	01 / A401
S.STL	STAINLESS STEEL	
SHT	SHEET	
sht'g struct	Sheathing Structural	(02)
T	TREAD	
TBD	TO BE DETERMINED	$\sim$
T.O.	TOP OF	<
T.PTN	TOILET PARTITION	I
TEL		
TV TYP.	TELEVISION TYPICAL	
U.O.N	UNLESS OTHERWISE NOTED	
V.I.F.	VERIFY IN FIELD	

VICINITY MAPS

SECTION

EXTERIOR ELEVATION

INTERIOR

ELEVATION

ROOM TAG

DOOR TAG

WINDOW TAG

GUARDRAIL TAG

WALL TYPES

DETAIL SECTION

DETAIL CALL-OUT

MATERIAL CALL-OUT

ELEVATION


MARKER

BUILDING ELEVATION

SPOT ELEVATION

REVISION

CENTER LINE

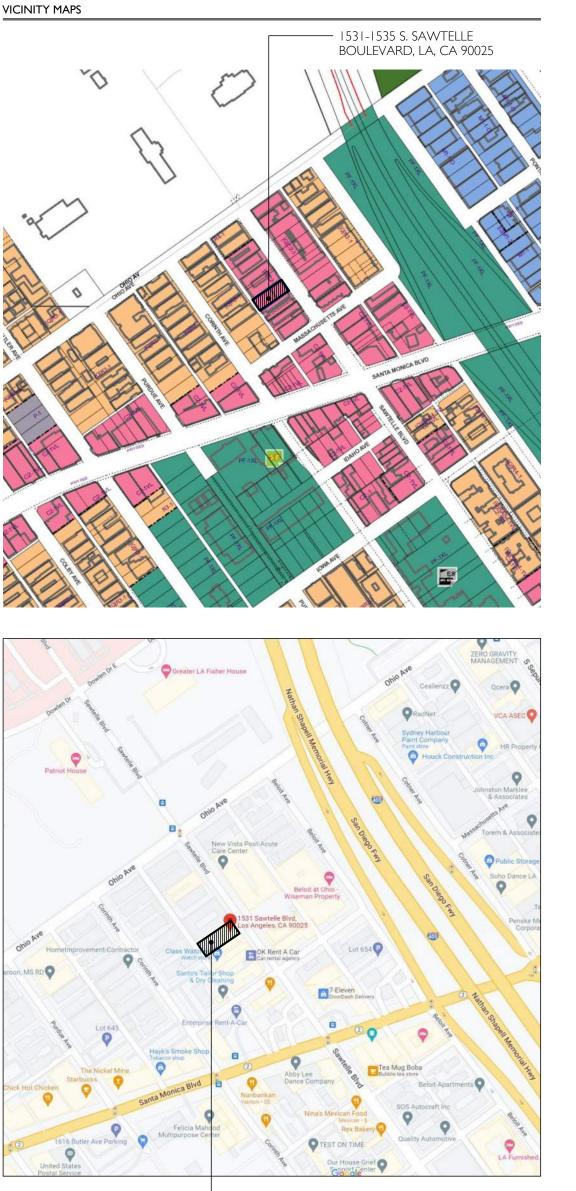

— 1531-1535 S. SAWTELLE BOULEVARD, LA, CA 90025

### PROJECT INFORMATION

PROJECT LOCATION PROPERTY OWNER / CLIENT

CONTRACTOR ARCHITECT

## 1531-1535 S. SAWTELLE BOULEVARD, LA, CA 90025 Donghao Li Tripalink design inc 2905 vermont ave #204 Los angeles, ca 90007 TO BE DETERMINED 64NORTH ARCHITECTURE LTD. 719 FAIRFAX AVE, SUITE C LOS ANGELES, CA 90046 T 310 919 0919

### APPLICABLE CODES

2019 EDITION OF THE CALIFORNIA RESIDENTIAL CODE 2019 EDITION OF THE CALIFORNIA ELECTRICAL CODE 2019 EDITION OF THE CALIFORNIA MECHANICAL CODE 2019 EDITION OF THE CALIFORNIA PLUMBING CODE 2019 EDITION OF THE CALIFORNIA GREEN BUILDING STANDARDS CODE 2019 EDITION OF THE CALIFORNIA ENERGY CODE 2020 LA CITY AMENDMENTS

 $\bigcirc$ NORTH ARROW /// glass Notation SLIDER DIRECTION  $\triangleleft$ 

stair Direction

SLOPE GRADE

- OPEN TO BEYOND BEYOND

BREAK

MATCHLINE

STRUCTURAL GRID





### DRAWING INDEX

#	DESCRIPTION	SCALE	DD
			12/2022
GENER/	AL		12/2
4000	COVER SHEET	N.T.S.	•
A00 I	DRAWING INDEX, ABBREVIATIONS, & SYMBOLS	N.T.S.	٠
A002	PROJECT INFORMATION	N.T.S.	٠
A011	RENDERINGS	N.T.S.	٠
A012	RENDERINGS	N.T.S.	٠
A013	RENDERINGS	N.T.S.	٠
A014	RENDERINGS	N.T.S.	٠
A015	RENDERINGS	N.T.S.	٠
A016	RENDERINGS	N.T.S.	٠
A017	RENDERINGS	N.T.S.	٠
A018	RENDERINGS	N.T.S.	٠
A019	RENDERINGS	N.T.S.	٠
A020	RENDERINGS	N.T.S.	٠
A021	SITE DIAGRAMS	/32" =  '-0"	٠
A022	BUILDING AREA DIAGRAMS	/32" =  '-0"	•
A023	FAR DIAGRAMS	/32" =  '-0"	•
A024	OPEN SPACE DIAGRAMS	/32" =  '-0"	•
A025	ALLOWABLE OPENINGS DIAGRAMS	/ 6 =  '-0"	•
A026	BUILDING AREA ANALYSIS	/ 6 =  '-0"	•
A027	BUILDING MATERIALS	N.T.S.	•
SURVEY			
S101	SURVEY	1:8	٠
	C A DE		
L091	PLANT LEGEND	N.T.S.	•
L092	PLANT PALETTE	N.T.S.	•
		/8" =  '-0"	•
L201	LANDSCAPE PLAN	/8" =  '-0"	•
LIFE & S	AFETY DIAGRAMS		
LS201	LIFE & SAFTEY LEVEL I PLAN	/8" =  '-0"	•
LS202	LIFE & SAFTEY LEVEL 2-5 PLAN	/8" =  '-0"	•
LS206	LIFE & SAFTEY LEVEL 6 PLAN	/8" =  '-0"	•
LS207	LIFE & SAFTEY ROOF PLAN	/8" =  '-0"	•
LS401	LIFE & SAFTEY SECTION	/8" =  '-0"	•
LS402	LIFE & SAFTEY SECTION	/8" =  '-0"	•
ARCHIT	ECTURAL		
A101	SITE PLAN	/8" =  '-0"	٠
A201	FIRST FLOOR PLAN	/8" =  '-0"	٠
A202	SECOND FLOOR PLAN	/8" =  '-0"	٠
A203	THIRD FLOOR PLAN	/8" =  '-0"	٠
	FOURTH FLOOR PLAN	/8" =  '-0"	٠
A204		1/0 - 1-0	
A204 A205	FIFTH FLOOR PLAN	1/8" = 1'-0"	٠
	FIFTH FLOOR PLAN ROOF FLOOR PLAN		•
A205		/8" =  '-0"	
A205 A206 A301	ROOF FLOOR PLAN	/8" =  '-0"  /8" =  '-0"	٠
A205 A206 A301 A302	ROOF FLOOR PLAN ELEVATIONS	/8" =  '-0"  /8" =  '-0"  /8" =  '-0"	•
A205 A206 A301 A302 A303	ROOF FLOOR PLAN ELEVATIONS ELEVATIONS	/8" =  '-0"  /8" =  '-0"  /8" =  '-0"  /8" =  '-0"	•
A205 A206 A301 A302 A303 A401	ROOF FLOOR PLAN ELEVATIONS ELEVATIONS ELEVATIONS	/8" =  '-0"  /8" =  '-0"  /8" =  '-0"  /8" =  '-0"  /8" =  '-0"	• • • •
A205 A206 A301 A302 A303 A401 A501	ROOF FLOOR PLANELEVATIONSELEVATIONSELEVATIONSBUILDING SECTIONS	/8" =  '-0"  /8" =  '-0"	• • • •
A205 A206	ROOF FLOOR PLAN ELEVATIONS ELEVATIONS ELEVATIONS BUILDING SECTIONS UNIT PLANS	/8" =  '-0"  /4" =  '-0"	• • • •
A205 A206 A301 A302 A303 A401 A501 A502 A503	ROOF FLOOR PLANELEVATIONSELEVATIONSELEVATIONSBUILDING SECTIONSUNIT PLANSUNIT PLANSUNIT PLANS	1/8" = 1'-0"         1/8" = 1'-0"         1/8" = 1'-0"         1/8" = 1'-0"         1/8" = 1'-0"         1/8" = 1'-0"         1/4" = 1'-0"         1/4" = 1'-0"	• • • • • •
A205 A206 A301 A302 A303 A401 A501 A502 A503 A504	ROOF FLOOR PLANELEVATIONSELEVATIONSELEVATIONSBUILDING SECTIONSUNIT PLANSUNIT PLANSUNIT PLANSUNIT PLANSUNIT PLANS	1/8" = 1'-0"         1/8" = 1'-0"         1/8" = 1'-0"         1/8" = 1'-0"         1/8" = 1'-0"         1/4" = 1'-0"         1/4" = 1'-0"         1/4" = 1'-0"         1/4" = 1'-0"         1/4" = 1'-0"	• • • • •
A205       A206       A301       A302       A303       A401       A501       A502       A503       A504       A801	ROOF FLOOR PLANELEVATIONSELEVATIONSELEVATIONSBUILDING SECTIONSUNIT PLANSUNIT PLANSUNIT PLANSUNIT PLANSGALZING SCHEDULES	$\frac{1/8" = 1' - 0"}{1/8" = 1' - 0"}$ $\frac{1/8" = 1' - 0"}{1/8" = 1' - 0"}$ $\frac{1/8" = 1' - 0"}{1/8" = 1' - 0"}$ $\frac{1/8" = 1' - 0"}{1/4" = 1' - 0"}$ $\frac{1/4" = 1' - 0"}{1/4" = 1' - 0"}$ $\frac{1/4" = 1' - 0"}{1/4" = 1' - 0"}$	• • • • • • • •
A205         A206         A301         A302         A303         A401         A501         A502         A503         A504         A801         A802	ROOF FLOOR PLANELEVATIONSELEVATIONSELEVATIONSBUILDING SECTIONSUNIT PLANSUNIT PLANSUNIT PLANSUNIT PLANSUNIT PLANSOR SCHEDULESDOOR SCHEDULES	1/8" = 1'-0"         1/8" = 1'-0"         1/8" = 1'-0"         1/8" = 1'-0"         1/8" = 1'-0"         1/4" = 1'-0"         1/4" = 1'-0"         1/4" = 1'-0"         1/4" = 1'-0"         1/4" = 1'-0"         1/4" = 1'-0"         1/4" = 1'-0"         1/4" = 1'-0"         1/4" = 1'-0"         1/4" = 1'-0"         1/4" = 1'-0"         1/4" = 1'-0"         1/4" = 1'-0"         1/4" = 1'-0"         1/4" = 1'-0"	• • • • • • • • • • • •
A205 A206 A301 A302 A303 A401 A501 A502 A503	ROOF FLOOR PLANELEVATIONSELEVATIONSELEVATIONSBUILDING SECTIONSUNIT PLANSUNIT PLANSUNIT PLANSUNIT PLANSGALZING SCHEDULES	$\frac{1/8" = 1' - 0"}{1/8" = 1' - 0"}$ $\frac{1/8" = 1' - 0"}{1/8" = 1' - 0"}$ $\frac{1/8" = 1' - 0"}{1/8" = 1' - 0"}$ $\frac{1/8" = 1' - 0"}{1/4" = 1' - 0"}$ $\frac{1/4" = 1' - 0"}{1/4" = 1' - 0"}$ $\frac{1/4" = 1' - 0"}{1/4" = 1' - 0"}$	• • • • • • • • • • • • •

### 01 / ARCHITECT

## 64NORTH 719 N. FAIRFAX AVENUE, SUITE C LOS ANGELES, CA 90046 T 310 919 0919 / F 310 933 0550 64NORTH.COM

### 02 / CLIENT & TEAM

# CLIENT / TRIPALINK DESIGN, INC. 2905 S VERMONT AVENUE, SUITE 202 LOS ANGELES, CALIFORNIA 90007

CIVIL ENGINEER /

LFA 319 MAIN STREET

EL SEGUNDO, CALIFORNIA 90245 (213) 239 9700

STRUCTURAL ENGINEER / IDG 10866 WIMER COUNTRY ROAD, LOS ANGELES, CA 91040 (323) 257-8854 OFFICE


MECHANICAL, ELECTRICAL & PLUMBING ENGINEER / MEP CALIFORNIA ENGINEERING CORP 1920 MAIN ST. SUITE 980

IRVINE, CA 92614

EXTERIOR BUILDING MAINTENANCE / LFA 319 MAIN STREET


EL SEGUNDO, CALIFORNIA 90245 (213) 239 9700

SURVEYOR / THE LAND SURVEYOR 1215 W. IMPERIAL HIGHWAY, SUIT 208 BREA, CA 92821 (714) 376-7123 SAMONTHELANDSU IBVEYOR COM SAM@THELANDSURVEYOR.COM

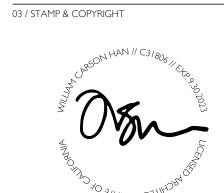

04 / KEY PLAN

 $\bigcirc$ 

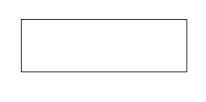

05 / PROJECT NAME & ADDRESS

## 1531-1535 S. SAWTELLE BOULEVARD LOS ANGELES, CA 90025

06 / REVISIONS

NO.	DATE	DESCRIPTION
01	12/2022	enititlements
02	12/2022	PERMIT
03	06/2023	ENITITLEMENTS REV I
04	11/2023	ENITITLEMENTS REV 2
05	01/2024	ENITITLEMENTS REV 3

07 / SHEET TITLE

### DRAWING INDEX ABBREVIATIONS & SYMBOLS

08 / SHEET NUMBER





© 64NORTH ARCHITECTURE, LTD.

UNIT SUMMARY

Required		
Level	4-Bed	5-Bed
LI	Ĺ	1
L2		L.
L3		1
L4 L5		T
L5		1
Total	l	5

### FAR / FLOOR AREA RATIO

_evel	
Basement	
_1	
_2	
_3	
_4	
_5	
Total, Proposed	

Buildable Area Ratio, Proposed

Kequired Unit Type	No. Units	SF Req. Per	Total Req.	
Less Than 3 Hab. Rooms (Studio & I-Beds)		0 100		SF
3 Habitable Rooms (2-Beds)		0 125	0	SF
More Than 3 Hab. Rooms (3+ Bedrooms)		9 175	1,575	SF
Subtotal		9	1,575	SF
Total, Required			1,575	SF
Provided				
Interior Common Spaces				
Recreation Room			1,632	SF
Maximum (25% of Total)			394	SF
Total			394	SF
Exterior Common Spaces				
Level I			364	SF
Rooftop			817	SF
Total			1,575	SF
Planted (25% of Total)			394	SF
				CE.
Total, Provided			1,575	SF
TREES				

Required	
I Tree Per 4 Units	
Provided	
Trees on Site	

ł	6-Bed	Total
	0	2
	Ĕ	2 2 2 2
	L	2
	L	2
	0	1
	3	9

OPEN SPACE





## PROJECT DATA Description

FAR

3.25

- SF

2,868 SF

3,300 SF

3,300 SF

3,300 SF

3,204 SF

15,972 SF

4,922.0 SF

:1

Building Information	
Occcupancy Type	R2 and S
Construction Type	5 Levels Of Type III-A Construction
Fire Sprinklers Emergency Responder System	Automatic Fire Sprinkler Per NFPA 13 Per LAFD Requirement
Legal & Zoning Information Address I	531-1535 S. Sawtelle Boulevard, LA, CA 9002
Address Assessor Parcel No. (APN)	4261-005-00
Zoning	[Q] C2-
Specific Plan	West Los Angeles Transporation Improvemen
Subarea Historical	Non Not Liste
	80 - 112,865,979,828,984
Lot Area Lot Area	7,029 SF
	0.16 AC
Lot Area For Density (Includes 1/2 Alley)	7,375.0 SF
Buildable Area	4,922.0 SF
Density	
Permitted Per LAMC	l Unit Per 800 SF Lot Are
Density Units Permitted	8.79
Density Bonus	
% Very Low Income Units of Base Very Low Income Units Provided (Rounded	109 (qU
Percentage Density Bonus	329
Units Permitted	1
Proposed	
Total Units	
FAR	
Permitted Per LAMC	
Ratio	1.5 :1
Allowable SF	7,383 SF
Permitted Per Density Bonus Off Menu Ince	ntive
Ratio	3.25 :1
Allowable SF	15,997 SF
Proposed	
Ratio	3.25 :1
Total SF	15,972 SF
Height & Stories	
Permitted Per Q Condition Height	45
Transitional Height	Non
Permitted Per Waivers	
II' Increase	56
Proposed	56
Height	56
	5 Storie
Stories	5 Storie
Stories Dedications	
Stories Dedications Sawtelle Boulevard	3' (33' to CL of R.O.W. / Collector Street
Stories Dedications Sawtelle Boulevard Alley	3' (33' to CL of R.O.W. / Collector Street
Stories	3' (33' to CL of R.O.W. / Collector Street
Stories Dedications Sawtelle Boulevard Alley Yards & Setbacks	3' (33' to CL of R.O.W. / Collector Street 2.5' (10' to CL of Alley
Stories Dedications Sawtelle Boulevard Alley Yards & Setbacks Permitted Per LAMC Front Yard / Building Line Side Yards	3' (33' to CL of R.O.W. / Collector Street 2.5' (10' to CL of Alley 7'-0" (After Dedication 8' (5'+1' For Each Story Over 2nd
Stories Dedications Sawtelle Boulevard Alley Yards & Setbacks Permitted Per LAMC Front Yard / Building Line Side Yards	3' (33' to CL of R.O.W. / Collector Street 2.5' (10' to CL of Alley 7'-0" (After Dedication 8' (5'+1' For Each Story Over 2nd
Stories Dedications Sawtelle Boulevard Alley Yards & Setbacks Permitted Per LAMC Front Yard / Building Line Side Yards Rear Yard	3' (33' to CL of R.O.W. / Collector Street 2.5' (10' to CL of Alley 7'-0" (After Dedication 8' (5'+1' For Each Story Over 2nd 18' (15'+1' For Each Story Over 2nd
Stories Dedications Sawtelle Boulevard Alley Yards & Setbacks Permitted Per LAMC Front Yard / Building Line Side Yards Rear Yard Permitted Per Density Bonus Off Menu Ince North Side Yard	3' (33' to CL of R.O.W. / Collector Street 2.5' (10' to CL of Alley 7'-0" (After Dedication 8' (5'+1' For Each Story Over 2nd 18' (15'+1' For Each Story Over 2nd 18' (15'+1' For Each Story Over 2nd
Stories Dedications Sawtelle Boulevard Alley Yards & Setbacks Permitted Per LAMC Front Yard / Building Line Side Yards Rear Yard Permitted Per Density Bonus Off Menu Ince North Side Yard	3' (33' to CL of R.O.W. / Collector Street 2.5' (10' to CL of Alley 7'-0" (After Dedication 8' (5'+1' For Each Story Over 2nd 18' (15'+1' For Each Story Over 2nd 18' (15'+1' For Each Story Over 2nd
Stories Dedications Sawtelle Boulevard Alley Yards & Setbacks Permitted Per LAMC Front Yard / Building Line Side Yards Rear Yard Permitted Per Density Bonus Off Menu Ince North Side Yard South Side Yard	3' (33' to CL of R.O.W. / Collector Street 2.5' (10' to CL of Alley 7'-0" (After Dedication 8' (5'+1' For Each Story Over 2nd 18' (15'+1' For Each Story Over 2nd 18' (15'+1' For Each Story Over 2nd
Stories Dedications Sawtelle Boulevard Alley Yards & Setbacks Permitted Per LAMC Front Yard / Building Line Side Yards Rear Yard Permitted Per Density Bonus Off Menu Ince North Side Yard South Side Yard Proposed Front Yard / Building Line	3' (33' to CL of R.O.W. / Collector Street 2.5' (10' to CL of Alley 7'-0" (After Dedication 8' (5'+1' For Each Story Over 2nd 18' (15'+1' For Each Story Over 2nd 18' (15'+1' For Each Story Over 2nd 18' 215'+1' For Each Story Over 2nd
Stories Dedications Sawtelle Boulevard Alley Yards & Setbacks Permitted Per LAMC Front Yard / Building Line Side Yards Rear Yard Permitted Per Density Bonus Off Menu Ince North Side Yard South Side Yard Proposed Front Yard / Building Line North Side Yard	3' (33' to CL of R.O.W. / Collector Street 2.5' (10' to CL of Alley 7'-0" (After Dedication 8' (5'+1' For Each Story Over 2nd 18' (15'+1' For Each Story Over 2nd ntive
Stories Dedications Sawtelle Boulevard Alley Yards & Setbacks Permitted Per LAMC Front Yard / Building Line	3' (33' to CL of R.O.W. / Collector Street 2.5' (10' to CL of Alley 7'-0" (After Dedication 8' (5'+1' For Each Story Over 2nd 18' (15'+1' For Each Story Over 2nd 18' (15'+1') For Each Story Ove
Stories Dedications Sawtelle Boulevard Alley Yards & Setbacks Permitted Per LAMC Front Yard / Building Line Side Yards Rear Yard Permitted Per Density Bonus Off Menu Ince North Side Yard South Side Yard South Side Yard Proposed Front Yard / Building Line North Side Yard South Side Yard South Side Yard South Side Yard Rear Yard	3' (33' to CL of R.O.W. / Collector Street 2.5' (10' to CL of Alley 7'-0" (After Dedication 8' (5'+1' For Each Story Over 2nd 18' (15'+1' For Each Story Over 2nd 18' (15'+1') For Each Story Ove
Stories Dedications Sawtelle Boulevard Alley Yards & Setbacks Permitted Per LAMC Front Yard / Building Line Side Yards Rear Yard Permitted Per Density Bonus Off Menu Ince North Side Yard South Side Yard South Side Yard Proposed Front Yard / Building Line North Side Yard South Side Yard South Side Yard Rear Yard Parking	3' (33' to CL of R.O.W. / Collector Street 2.5' (10' to CL of Alley 7'-0" (After Dedication 8' (5'+1' For Each Story Over 2nd 18' (15'+1' For Each Story Over 2nd 18' (15'+1') For Each Story Ove
Stories Dedications Sawtelle Boulevard Alley Yards & Setbacks Permitted Per LAMC Front Yard / Building Line Side Yards Rear Yard Permitted Per Density Bonus Off Menu Ince North Side Yard South Side Yard South Side Yard Proposed Front Yard / Building Line North Side Yard South Side Yard South Side Yard Rear Yard Parking Required Per LAMC	3' (33' to CL of R.O.W. / Collector Street 2.5' (10' to CL of Alley 7'-0" (After Dedication 8' (5'+1' For Each Story Over 2nd 18' (15'+1' For Each Story Over 2nd 18' (15'+1' For Each Story Over 2nd 7'-0" 5 5 18
Stories Dedications Sawtelle Boulevard Alley Yards & Setbacks Permitted Per LAMC Front Yard / Building Line Side Yards Rear Yard Permitted Per Density Bonus Off Menu Ince North Side Yard South Side Yard South Side Yard Proposed Front Yard / Building Line North Side Yard South Side Yard South Side Yard Rear Yard Parking Required Per LAMC Spaces Required For (9) 4+ Bedroom	3' (33' to CL of R.O.W. / Collector Street 2.5' (10' to CL of Alley 7'-0" (After Dedication 8' (5'+1' For Each Story Over 2nd 18' (15'+1' For Each Story Over 2nd 18' (15'+1') For Each Story Over 2nd 18
Stories Dedications Sawtelle Boulevard Alley Yards & Setbacks Permitted Per LAMC Front Yard / Building Line Side Yards Rear Yard Permitted Per Density Bonus Off Menu Ince North Side Yard South Side Yard South Side Yard Proposed Front Yard / Building Line North Side Yard South Side Yard South Side Yard Rear Yard Parking Required Per LAMC Spaces Required	7'-0' 5 5 18 s Per Unit With More Than 3 Habitable Room

Bicycle Parking			
Required Per LAMC 12.2	I.A. I 6.d (Fractions Rou	nded To Nearest Whole Number)	1
Long Term	l to 25	I Per Unit	5
	26 to 30	I Per I.5 Unit	0
Short Term	I to 25	I Per 10 Units, Minimum 1	
	26 to 30	I Per 15 Units	(
Total Required			10
Provided			10

Provided Incentives

Mnisterial Incentives Per AB2097 1. No Vehicular Parking

Off Menu Incentives Per LAMC 12.22-A,25 & LAMC 13B.2.5

I. Reduction Of Development Standards To Permit A 37.5% North Side Yard Reduction From 8'-0" to 5'-0".

2. Reduction Of Development Standards To Permit A 37.5% South Side Yard Reduction From 8'-0" to 5'-0".

Waivers Per LAMC 12.22-A,25 & LAMC 13B.2.5 I. Waiver Of Development Standards To Permit An II'-0" Height Increase From 45' To 56' 2. Waiver Of Development Standards To Permit An Increase In FAR From 1.5 to 3.25




### 64NORTH 719 N. FAIRFAX AVENUE, SUITE C LOS ANGELES, CA 90046 T 310 919 0919 / F 310 933 0550 64NORTH.COM

02 / CLIENT & TEAM

CLIENT / TRIPALINK DESIGN, INC. 2905 S VERMONT AVENUE, SUITE 202 LOS ANGELES, CALIFORNIA 90007 CIVIL ENGINEER / LFA 319 MAIN STREET EL SEGUNDO, CALIFORNIA 90245 (213) 239 9700 STRUCTURAL ENGINEER / IDG 10866 WIMER COUNTRY ROAD, LOS ANGELES, CA 91040 (323) 257-8854 OFFICE MECHANICAL, ELECTRICAL & PLUMBING ENGINEER / MEP CALIFORNIA ENGINEERING CORP 1920 MAIN ST. SUITE 980 IRVINE, CA 92614 EXTERIOR BUILDING MAINTENANCE / LFA 319 MAIN STREET EL SEGUNDO, CALIFORNIA 90245 (213) 239 9700 SURVEYOR / THE LAND SURVEYOR 1215 W. IMPERIAL HIGHWAY, SUIT 208 BREA, CA 92821 (714) 376-7123 SAM@THELANDSURVEYOR.COM



 $\bigcirc$ 

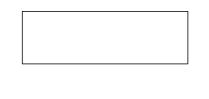

05 / PROJECT NAME & ADDRESS

## 1531-1535 S. SAWTELLE BOULEVARD LOS ANGELES, CA 90025

06 / REVISIONS

NO.	DATE	DESCRIPTION
01	12/2022	ENITITLEMENTS
02	12/2022	PERMIT
03	06/2023	ENITITLEMENTS REV I
04	11/2023	ENITITLEMENTS REV 2
05	01/2024	ENITITLEMENTS REV 3

07 / SHEET TITLE

## PROJECT INFÓRMATION






#### **64.NORTH** 719 N. FAIRFAX AVENUE, SUITE C LOS ANGELES, CA 90046 T 310 919 0919 / F 310 933 0550 64NORTH.COM


### 02 / CLIENT & TEAM

CLIENT / TRIPALINK DESIGN, INC. 2905 S VERMONT AVENUE, SUITE 202 LOS ANGELES, CALIFORNIA 90007 CIVIL ENGINEER / LFA 319 MAIN STREET EL SEGUNDO, CALIFORNIA 90245 (213) 239 9700 STRUCTURAL ENGINEER / IDG 10866 WIMER COUNTRY ROAD, LOS ANGELES, CA 91040 (323) 257-8854 OFFICE MECHANICAL, ELECTRICAL & PLUMBING ENGINEER / MEP CALIFORNIA ENGINEERING CORP 1920 MAIN ST. SUITE 980 IRVINE, CA 92614 EXTERIOR BUILDING MAINTENANCE / LFA 319 MAIN STREET EL SEGUNDO, CALIFORNIA 90245 (213) 239 9700 SURVEYOR / THE LAND SURVEYOR 1215 W. IMPERIAL HIGHWAY, SUIT 208 BREA, CA 92821 (714) 376-7123 SAM@THELANDSURVEYORCOM

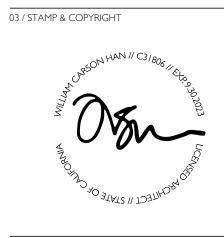



 $\bigcirc$ 

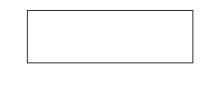

05 / PROJECT NAME & ADDRESS

### 1531-1535 S. SAWTELLE BOULEVARD LOS ANGELES, CA 90025

06 / REVISIONS

О.	DATE	DESCRIPTION
I	12/2022	ENTITLEMENTS
2	12/2022	PERMIT
3	08/2023	ENTITLEMENTS REV I
1	10/2023	ENTITLEMENTS REV 2

07 / SHEET TITLE

## RENDERINGS





01 / ARCHITECT

### **64.NORTH** 719 N. FAIRFAX AVENUE, SUITE C LOS ANGELES, CA 90046 T 310 919 0919 / F 310 933 0550 64NORTH.COM

02 / CLIENT & TEAM

CLIENT / TRIPALINK DESIGN, INC. 2905 S VERMONT AVENUE, SUITE 202 LOS ANGELES, CALIFORNIA 90007


CIVIL ENGINEER / LFA 319 MAIN STREET EL SEGUNDO, CALIFORNIA 90245 (213) 239 9700

STRUCTURAL ENGINEER / IDG 10866 WIMER COUNTRY ROAD, LOS ANGELES, CA 91040 (323) 257-8854 OFFICE

MECHANICAL, ELECTRICAL & PLUMBING ENGINEER / MEP CALIFORNIA ENGINEERING CORP 1920 MAIN ST. SUITE 980 IRVINE, CA 92614 EXTERIOR BUILDING MAINTENANCE / LFA 210 MAIN STREET


LFA 319 MAIN STREET EL SEGUNDO, CALIFORNIA 90245 (213) 239 9700 SURVEYOR /

SURVEYOR / THE LAND SURVEYOR 1215 W. IMPERIAL HIGHWAY, SUIT 208 BREA, CA 92821 (714) 376-7123 SAM@THELANDSURVEYOR.COM

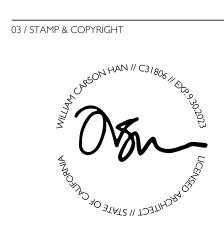

04 / KEY PLAN



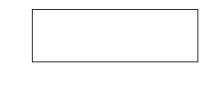

05 / PROJECT NAME & ADDRESS

### 1531-1535 S. SAWTELLE BOULEVARD LOS ANGELES, CA 90025

06 / REVISIONS

NO.	DATE	DESCRIPTION
01	12/2022	ENTITLEMENTS
02	12/2022	PERMIT
03	08/2023	ENTITLEMENTS REV I
04	10/2023	ENTITLEMENTS REV 2

\_\_\_\_\_

07 / SHEET TITLE

## RENDERINGS





01 / ARCHITECT

# **64.NORTH** 719 N. FAIRFAX AVENUE, SUITE C LOS ANGELES, CA 90046 T 310 919 0919 / F 310 933 0550 64NORTH.COM

02 / CLIENT & TEAM


CLIENT / TRIPALINK DESIGN, INC. 2905 S VERMONT AVENUE, SUITE 202 LOS ANGELES, CALIFORNIA 90007

CIVIL ENGINEER / LFA 319 MAIN STREET EL SEGUNDO, CALIFORNIA 90245 (213) 239 9700

STRUCTURAL ENGINEER / IDG 10866 WIMER COUNTRY ROAD, LOS ANGELES, CA 91040 (323) 257-8854 OFFICE


MECHANICAL, ELECTRICAL & PLUMBING ENGINEER / MEP CALIFORNIA ENGINEERING CORP 1920 MAIN ST. SUITE 980 IRVINE, CA 92614 EXTERIOR BUILDING MAINTENANCE / LFA 319 MAIN STREET EL SEGUNDO, CALIFORNIA 90245 (213) 239 9700

SURVEYOR / THE LAND SURVEYOR 1215 W. IMPERIAL HIGHWAY, SUIT 208 BREA, CA 92821 (714) 376-7123 SAM@THELANDSURVEYOR.COM

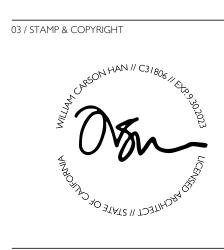

04 / KEY PLAN

 $\bigcirc$ 

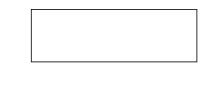

05 / PROJECT NAME & ADDRESS

## 1531-1535 S. SAWTELLE BOULEVARD LOS ANGELES, CA 90025

06 / REVISIONS

NO.	DATE	DESCRIPTION
01	12/2022	entitlements
02	12/2022	PERMIT
03	08/2023	ENTITLEMENTS REV I
04	10/2023	ENTITLEMENTS REV 2

07 / SHEET TITLE

## RENDERINGS






## 64NORTH 719 N. FAIRFAX AVENUE, SUITE C LOS ANGELES, CA 90046 T 310 919 0919 / F 310 933 0550 64NORTH.COM


02 / CLIENT & TEAM

CLIENT / TRIPALINK DESIGN, INC. 2905 S VERMONT AVENUE, SUITE 202 LOS ANGELES, CALIFORNIA 90007 CIVIL ENGINEER / LFA 319 MAIN STREET EL SEGUNDO, CALIFORNIA 90245 (213) 239 9700 STRUCTURAL ENGINEER / IDG 10866 WIMER COUNTRY ROAD, LOS ANGELES, CA 91040 (323) 257-8854 OFFICE MECHANICAL, ELECTRICAL & PLUMBING ENGINEER / MEP CALIFORNIA ENGINEERING CORP 1920 MAIN ST. SUITE 980 IRVINE, CA 92614 EXTERIOR BUILDING MAINTENANCE / LFA 319 MAIN STREET EL SEGUNDO, CALIFORNIA 90245 (213) 239 9700 SURVEYOR / THE LAND SURVEYOR 1215 W. IMPERIAL HIGHWAY, SUIT 208 BREA, CA 92821 (714) 376-7123 SAM@THELANDSURVEYOR.COM

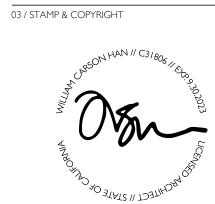

04 / KEY PLAN



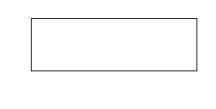

05 / PROJECT NAME & ADDRESS

## 1531-1535 S. SAWTELLE BOULEVARD LOS ANGELES, CA 90025

06 / REVISIONS

D.	DATE	DESCRIPTION
	12/2022	ENTITLEMENTS
	12/2022	PERMIT
	08/2023	ENTITLEMENTS REV I

\_\_\_\_\_ 04 10/2023 ENTITLEMENTS REV 2


07 / SHEET TITLE

## RENDERINGS

08 / SHEET NUMBER

A014

© 64NORTH ARCHITECTURE, LTD.

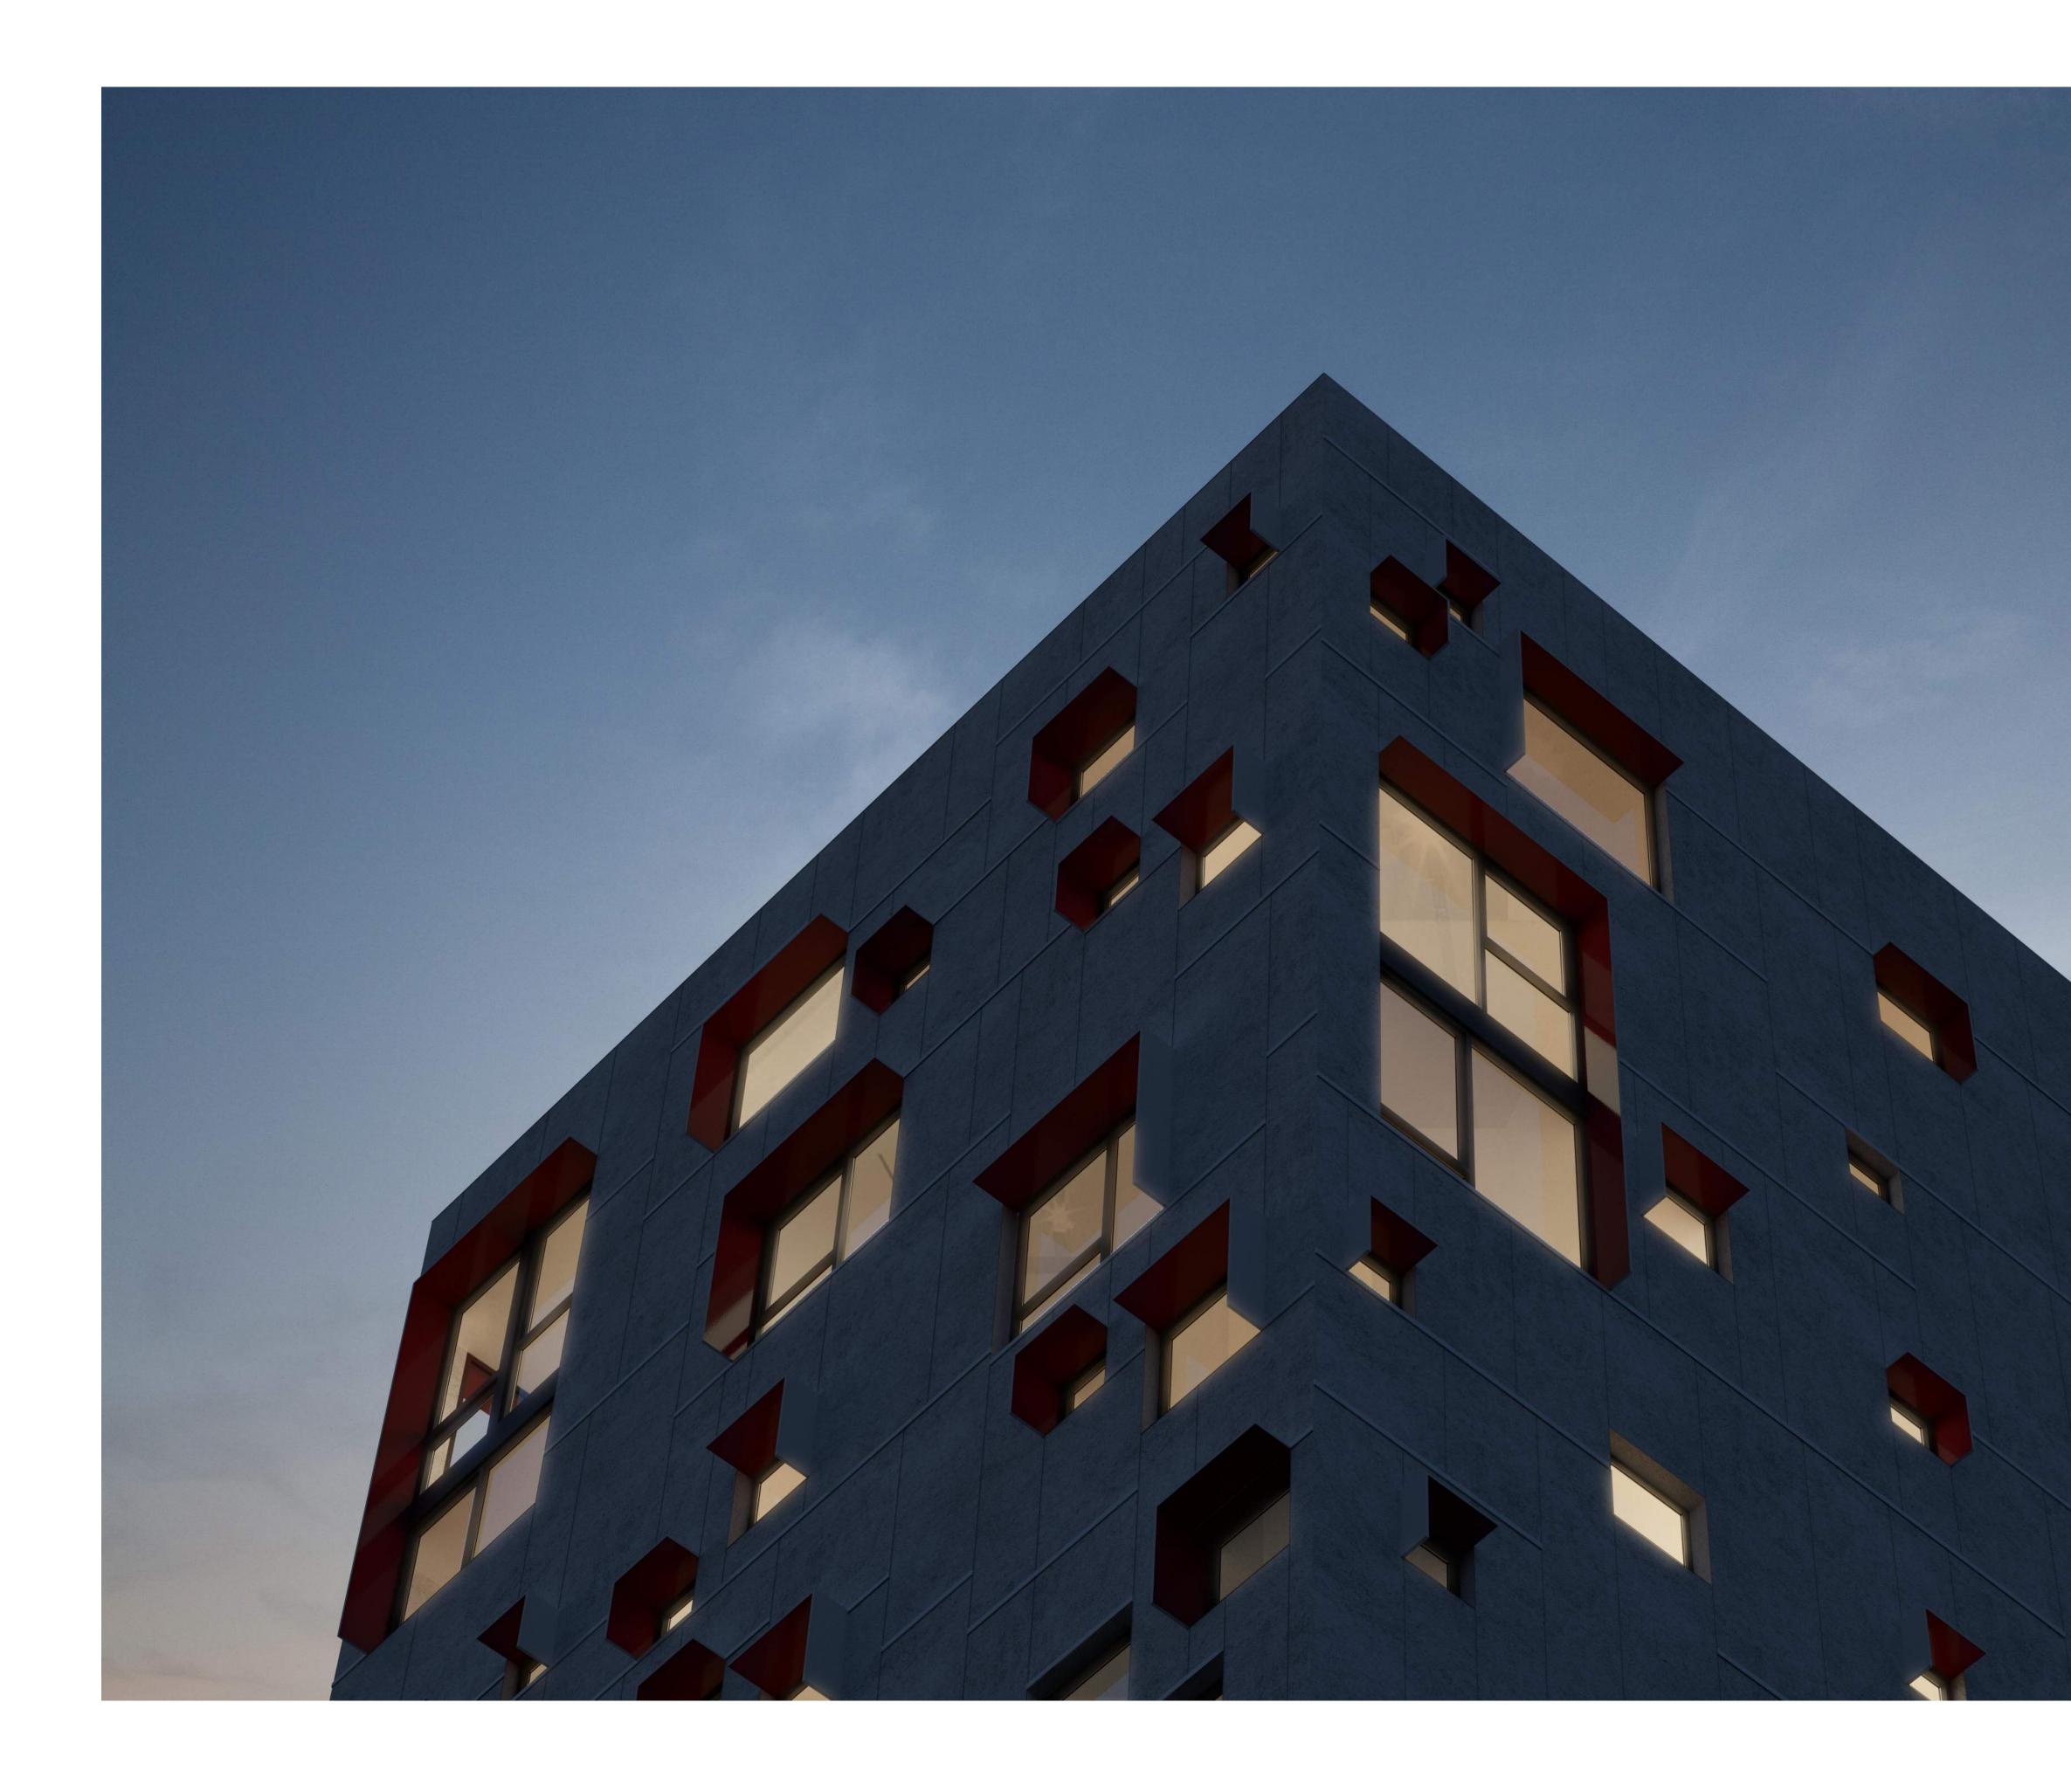



08 / SHEET NUMBER

### RENDERINGS

07 / SHEET TITLE

01 12/2022 ENTITLEMENTS 02 12/2022 PERMIT 03 08/2023 ENTITLEMENTS REV I

04 10/2023 ENTITLEMENTS REV 2

06 / REVISIONS NO. DATE DESCRIPTION

1531-1535 S. SAWTELLE BOULEVARD LOS ANGELES, CA 90025

05 / PROJECT NAME & ADDRESS

 $\bigcirc$ 

04 / KEY PLAN



03 / STAMP & COPYRIGHT

64NORTH 719 N. FAIRFAX AVENUE, SUITE C LOS ANGELES, CA 90046 T 310 919 0919 / F 310 933 0550 64NORTH.COM

CIVIL ENGINEER /

02 / CLIENT & TEAM

CLIENT / TRIPALINK DESIGN, INC. 2905 S VERMONT AVENUE, SUITE 202 LOS ANGELES, CALIFORNIA 90007

LFA 319 MAIN STREET EL SEGUNDO, CALIFORNIA 90245 (213) 239 9700

IDG 10866 WIMER COUNTRY ROAD, LOS ANGELES, CA 91040 (323) 257-8854 OFFICE

EXTERIOR BUILDING MAINTENANCE /

SURVEYOR / THE LAND SURVEYOR 1215 W. IMPERIAL HIGHWAY, SUIT 208 BREA, CA 92821 (714) 376-7123 SAM@THELANDSURVEYOR.COM

LFA 319 MAIN STREET EL SEGUNDO, CALIFORNIA 90245 (213) 239 9700

MECHANICAL, ELECTRICAL & PLUMBING ENGINEER / MEP CALIFORNIA ENGINEERING CORP 1920 MAIN ST. SUITE 980 IRVINE, CA 92614

STRUCTURAL ENGINEER /

### 01 / ARCHITECT



### **64.NORTH** 719 N. FAIRFAX AVENUE, SUITE C LOS ANGELES, CA 90046 T 310 919 0919 / F 310 933 0550 64NORTH.COM


### 02 / CLIENT & TEAM

CLIENT / TRIPALINK DESIGN, INC. 2905 S VERMONT AVENUE, SUITE 202 LOS ANGELES, CALIFORNIA 90007 CIVIL ENGINEER / LFA 319 MAIN STREET EL SEGUNDO, CALIFORNIA 90245 (213) 239 9700 STRUCTURAL ENGINEER / IDG 10866 WIMER COUNTRY ROAD, LOS ANGELES, CA 91040 (323) 257-8854 OFFICE MECHANICAL, ELECTRICAL & PLUMBING ENGINEER / MEP CALIFORNIA ENGINEERING CORP 1920 MAIN ST. SUITE 980 IRVINE, CA 92614 EXTERIOR BUILDING MAINTENANCE / LFA 319 MAIN STREET EL SEGUNDO, CALIFORNIA 90245 (213) 239 9700 SURVEYOR / THE LAND SURVEYOR 1215 W. IMPERIAL HIGHWAY, SUIT 208 BREA, CA 92821 (714) 376-7123 SAM@THELANDSURVEYORCOM



KETPLAN

 $\bigcirc$ 

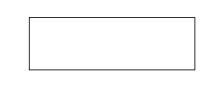

05 / PROJECT NAME & ADDRESS

### 1531-1535 S. SAWTELLE BOULEVARD LOS ANGELES, CA 90025

06 / REVISIONS

О.	DATE	DESCRIPTION
	12/2022	ENTITLEMENTS
)	12/2022	PERMIT
}	08/2023	ENTITLEMENTS REV I
1	10/2023	ENTITLEMENTS REV 2

07 / SHEET TITLE

## RENDERINGS





### **64.NORTH** 719 N. FAIRFAX AVENUE, SUITE C LOS ANGELES, CA 90046 T 310 919 0919 / F 310 933 0550 64NORTH.COM


### 02 / CLIENT & TEAM

CLIENT / TRIPALINK DESIGN, INC. 2905 S VERMONT AVENUE, SUITE 202 LOS ANGELES, CALIFORNIA 90007 CIVIL ENGINEER / LFA 319 MAIN STREET EL SEGUNDO, CALIFORNIA 90245 (213) 239 9700 STRUCTURAL ENGINEER / IDG 10866 WIMER COUNTRY ROAD, LOS ANGELES, CA 91040 (323) 257-8854 OFFICE MECHANICAL, ELECTRICAL & PLUMBING ENGINEER / MEP CALIFORNIA ENGINEERING CORP 1920 MAIN ST. SUITE 980 IRVINE, CA 92614 EXTERIOR BUILDING MAINTENANCE / LFA 319 MAIN STREET EL SEGUNDO, CALIFORNIA 90245 (213) 239 9700 SURVEYOR / THE LAND SURVEYOR 1215 W. IMPERIAL HIGHWAY, SUIT 208 BREA, CA 92821 (714) 376-7123 SAM@THELANDSURVEYOR.COM



04 / KEY PLAN

 $\bigcirc$ 

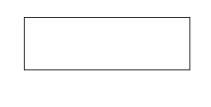

05 / PROJECT NAME & ADDRESS

### 1531-1535 S. SAWTELLE BOULEVARD LOS ANGELES, CA 90025

06 / REVISIONS

10.	DATE	DESCRIPTION
	12/2022	ENTITLEMENTS
2	12/2022	PERMIT
3	08/2023	ENTITLEMENTS REV I
4	10/2023	ENTITLEMENTS REV 2

\_\_\_\_\_

07 / SHEET TITLE

## RENDERINGS





01 / ARCHITECT

### **64.NORTH** 719 N. FAIRFAX AVENUE, SUITE C LOS ANGELES, CA 90046 T 310 919 0919 / F 310 933 0550 64NORTH.COM

02 / CLIENT & TEAM

CLIENT / TRIPALINK DESIGN, INC. 2905 S VERMONT AVENUE, SUITE 202 LOS ANGELES, CALIFORNIA 90007 CIVIL ENGINEER / LFA 319 MAIN STREET EL SEGUNDO, CALIFORNIA 90245 (213) 239 9700 STRUCTURAL ENGINEER / IDG I0866 WIMER COUNTRY ROAD, LOS ANGELES, CA 91040 (323) 257-8854 OFFICE MECHANICAL, ELECTRICAL & PLUMBING ENGINEER / MEP CALIFORNIA ENGINEERING CORP 1920 MAIN ST. SUITE 980 IRVINE, CA 92614 EXTERIOR BUILDING MAINTENANCE / LFA 319 MAIN STREET EL SEGUNDO, CALIFORNIA 90245 (213) 239 9700 SURVEYOR / THE LAND SURVEYOR 1215 W. IMPERIAL HIGHWAY, SUIT 208 BREA, CA 92821 (714) 376-7123 SAM@THELANDSURVEYOR.COM



04 / KEY PLAN

 $\bigcirc$ 



05 / PROJECT NAME & ADDRESS

### 1531-1535 S. SAWTELLE BOULEVARD LOS ANGELES, CA 90025

06 / REVISIONS

О.	DATE	DESCRIPTION
I	12/2022	ENTITLEMENTS
2	12/2022	PERMIT
3	08/2023	ENTITLEMENTS REV I
1	10/2023	ENITITI EMENITS REV 2

07 / SHEET TITLE

## RENDERINGS






### **64NORTH** 719 N. FAIRFAX AVENUE, SUITE C LOS ANGELES, CA 90046 T 310 919 0919 / F 310 933 0550 64NORTH.COM


### 02 / CLIENT & TEAM

CLIENT / TRIPALINK DESIGN, INC. 2905 S VERMONT AVENUE, SUITE 202 LOS ANGELES, CALIFORNIA 90007 CIVIL ENGINEER / LFA 319 MAIN STREET EL SEGUNDO, CALIFORNIA 90245 (213) 239 9700 STRUCTURAL ENGINEER / IDG 10866 WIMER COUNTRY ROAD, LOS ANGELES, CA 91040 (323) 257-8854 OFFICE MECHANICAL, ELECTRICAL & PLUMBING ENGINEER / MEP CALIFORNIA ENGINEERING CORP 1920 MAIN ST. SUITE 980 IRVINE, CA 92614 EXTERIOR BUILDING MAINTENANCE / LFA 319 MAIN STREET EL SEGUNDO, CALIFORNIA 90245 (213) 239 9700 SURVEYOR / THE LAND SURVEYOR 1215 W. IMPERIAL HIGHWAY, SUIT 208 BREA, CA 92821 (714) 376-7123 SAM@THELANDSURVEYOR.COM

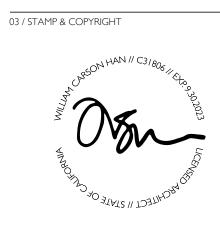

04 / KEY PLAN



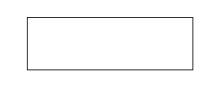

05 / PROJECT NAME & ADDRESS

### 1531-1535 S. SAWTELLE BOULEVARD LOS ANGELES, CA 90025

06 / REVISIONS

10.	DATE	DESCRIPTION
)	12/2022	entitlements
)2	12/2022	PERMIT
13	08/2023	ENTITLEMENTS REV I
)4	10/2023	ENTITLEMENTS REV 2

07 / SHEET TITLE

## RENDERINGS





01 / ARCHITECT

### **64.NORTH** 719 N. FAIRFAX AVENUE, SUITE C LOS ANGELES, CA 90046 T 310 919 0919 / F 310 933 0550 64NORTH.COM

02 / CLIENT & TEAM

CLIENT / TRIPALINK DESIGN, INC. 2905 S VERMONT AVENUE, SUITE 202 LOS ANGELES, CALIFORNIA 90007 CIVIL ENGINEER / LFA 319 MAIN STREET EL SEGUNDO, CALIFORNIA 90245 (213) 239 9700 STRUCTURAL ENGINEER / IDG 10866 WIMER COUNTRY ROAD, LOS ANGELES, CA 91040 (323) 257-8854 OFFICE MECHANICAL, ELECTRICAL & PLUMBING ENGINEER / MEP CALIFORNIA ENGINEERING CORP 1920 MAIN ST. SUITE 980 IRVINE, CA 92614 EXTERIOR BUILDING MAINTENANCE / LFA 319 MAIN STREET EL SEGUNDO, CALIFORNIA 90245 (213) 239 9700 SURVEYOR / THE LAND SURVEYOR 1215 W. IMPERIAL HIGHWAY, SUIT 208 BREA, CA 92821 (714) 376-7123 SAM@THELANDSURVEYORCOM

03 / STAMP & COPYRIGHT

04 / KEY PLAN

 $\bigcirc$ 

05 / PROJECT NAME & ADDRESS

### 1531-1535 S. SAWTELLE BOULEVARD LOS ANGELES, CA 90025

06 / REVISIONS

 NO.
 DATE
 DESCRIPTION

 01
 12/2022
 ENTITLEMENTS

 02
 12/2022
 PERMIT

 03
 08/2023
 ENTITLEMENTS REV 1

 04
 10/2023
 ENTITLEMENTS REV 2

07 / SHEET TITLE

## RENDERINGS



01 / ARCHITECT

## 64NORTH 719 N. FAIRFAX AVENUE, SUITE C LOS ANGELES, CA 90046 T 310 919 0919 / F 310 933 0550 64NORTH.COM

02 / CLIENT & TEAM

# CLIENT / TRIPALINK DESIGN, INC. 2905 S VERMONT AVENUE, SUITE 202 LOS ANGELES, CALIFORNIA 90007

CIVIL ENGINEER / LFA 319 MAIN STREET


EL SEGUNDO, CALIFORNIA 90245 (213) 239 9700 STRUCTURAL ENGINEER /

IDG 10866 WIMER COUNTRY ROAD, LOS ANGELES, CA 91040 (323) 257-8854 OFFICE

MECHANICAL, ELECTRICAL & PLUMBING ENGINEER / MEP CALIFORNIA ENGINEERING CORP 1920 MAIN ST. SUITE 980 IRVINE, CA 92614

EXTERIOR BUILDING MAINTENANCE / LFA 319 MAIN STREET EL SEGUNDO, CALIFORNIA 90245 (213) 239 9700

SURVEYOR / THE LAND SURVEYOR 1215 W. IMPERIAL HIGHWAY, SUIT 208 BREA, CA 92821 (714) 376-7123 SAM@THELANDSURVEYOR.COM

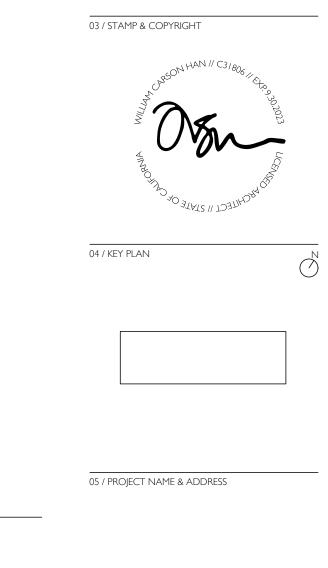

## 1531-1535 S. SAWTELLE BOULEVARD LOS ANGELES, CA 90025

06 / REVISIONS


NO.	DATE	DESCRIPTION
01	12/2022	ENITITLEMENTS
02	12/2022	PERMIT
03	06/2023	ENITITLEMENTS REV I
04	11/2023	ENITITLEMENTS REV 2
05	01/2024	ENITITLEMENTS REV 3

07 / SHEET TITLE

## SITE DIAGRAMS


08 / SHEET NUMBER



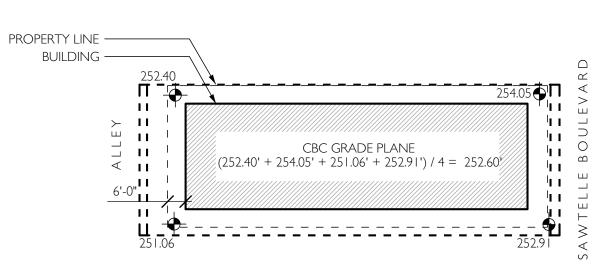

**GRADE PLANE (CBC 2019 - 202):** A REFERENCE PLANE REPRESENTING THE AVERAGE OF FINISHED GROUND LEVEL ADJOINING THE BUILDING AT THE EXTERIOR WALLS. WHERE THE FINISHED GROUND LEVEL SLOPES AWAY FROM THE EXTERIOR WALLS, THE REFERENCE PLANE SHALL BE ESTABLISHED BY THE LOWEST POINT WITHIN THE AREA BETWEEN THE BUILDING AND THE LOT LINE OR, WHERE THE LOT LINE IS MORE THAN 6 FEET FROM THE BUILDING, BETWEEN THE BUILDING AND A POINT 6 FEET FROM THE BUILDING.

CBC GRADE PLANE 02 CBC GRAE SCALE 1/32" = 1'-0"

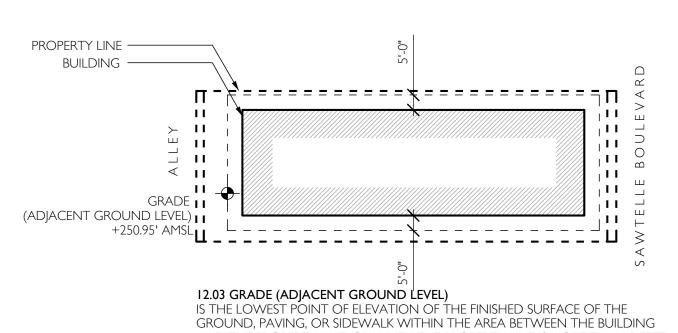

AND THE PROPERTY LINE, OR WHEN THE PROPERTY LINE IS MORE THAN 5 FEET FROM THE BUILDING, BETWEEN THE BUILDING AND A LINE 5 FEET FROM THE BUILDING. THIS DEFINITION DOES NOT APPLY TO ANY BUILDING OR STRUCTURE LOCATED WITHIN THE BOUNDARIES OF THE CENTURY CITY NORTH OR CENTURY CITY SOUTH SPECIFIC PLANS AND WHICH IS SUBJECTED TO LAMC SECTION 12.21.2.

GRADE (ADJACENT GROUND LEVEL) 01) SCALE 1/32" = 1'-0"



ALLOWABLE AREAS PER BUILDING	


LEVEL	TYPE	SF ALLOWED	SF PROVIDED	SF PARKING
LEVEL I	TYPE III-A	14,400	3,855	0
LEVEL 2	TYPE III-A	14,400	3,855	0
LEVEL 3	TYPE III-A	14,400	3,855	0
LEVEL 4	TYPE III-A	14,400	3,855	0
LEVEL 5	TYPE III-A	14,400	3,855	0
TOTAL		72,000	19,275	0

TABLE 506.2 ALLOVA/ABLE AREA FACTOR (A = NIS SL SL 3R, SL 3D, or SM as applicable) IN SOLIARE FEET a, b, j

ALLO	WABLE AREA FACTOR (A	t = NS, SI	I, ST3R, S	13D or S	oM as app	blicable) Il	n squa	RE FEE I	u, 0, j	
OCCUPANCY CLASSIFICATION		TYPE OF CONSTRUCTION								
	see footnotes	TYI	PEI	TY	ТҮРЕ ІІ Т		PE III	TYPE IV	TYPE V	
	JELTOOTNOTEJ	А	В	A	В	A	В	HT	А	В
	NS®	UL	UL	24,000	16,000	24,000	16,000	20,500	12,000	7,000
	\$13R	UL	UL	24,000	16,000	24,000	16,000	20,500	12,000	7,000
R-2	SX.	UL	UL	96,000	64,000	96,000	64,000	82,000	48,000	28,000
	S (without height increase)	UL	UL	72,000	48,000	72,000	48,000	61,500	36,000	21,000
	S (with height increase)	UL	KW//	24,000	16,000	24,000	16,000	20,500	12,000	7,000

06 CBC BUILDING HEIGHT SCALE 1/32" = 1'-0"

NFPA 13 FIRE SPRINKLERS PER 903.3.1.1

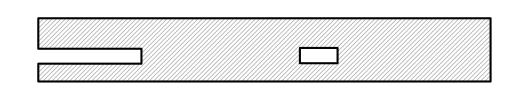

CLASSIFICATION			PEI	TYP	EII	TYP	EIII	TYPE IV	TYP	EV
	SEE FOOTNOTES	A	в	A	В	A	В	HT	A	в
										//////
						//////////////////////////////////////				

TABLE 504.3\*.7 ALLOWABLE BUILDING HEIGHT IN FEET ABOVE GRADE PLANE

TYPE OF CONSTRUCTION

07 BUILDING AREA DEFINITION SCALE 1/32" = 1'-0"

THE AREA INCLUDED WITHIN SURROUNDING EXTERIOR WALLS (OR EXTERIOR WALLS AND FIRE WALLS) EXCLUSIVE OF VENT SHAFTS AND COURTS. AREAS OF THE BUILDING NOT PROVIDED WITH SURROUNDING WALLS SHALL BE INCLUDED WITHIN THE HORIZONTAL PROJECTION OF THE ROOF OR FLOOR ABOVE.

AREA, BUILDING (CBC CHPT. 5 & 2):



# 05 BUILDING AREA CALCULATIONS SCALE 1/32" = 1'-0"

01 / ARCHITECT

## 64NORTH 719 N. FAIRFAX AVENUE, SUITE C LOS ANGELES, CA 90046 T 310 919 0919 / F 310 933 0550 64NORTH.COM

02 / CLIENT & TEAM

CLIENT / TRIPALINK DESIGN, INC. 2905 S VERMONT AVENUE, SUITE 202 LOS ANGELES, CALIFORNIA 90007
CIVIL ENGINEER / LFA 319 MAIN STREET EL SEGUNDO, CALIFORNIA 90245 (213) 239 9700
STRUCTURAL ENGINEER / IDG 10866 WIMER COUNTRY ROAD, LOS ANGELES, CA 91040 (323) 257-8854 OFFICE

MECHANICAL, ELECTRICAL & PLUMBING ENGINEER / MEP CALIFORNIA ENGINEERING CORP 1920 MAIN ST. SUITE 980 IRVINE, CA 92614 EXTERIOR BUILDING MAINTENANCE /

LFA 319 MAIN STREET EL SEGUNDO, CALIFORNIA 90245 (213) 239 9700

SURVEYOR / THE LAND SURVEYOR 1215 W. IMPERIAL HIGHWAY, SUIT 208 BREA, CA 92821 (714) 376-7123 SAM@THELANDSURVEYOR.COM




3,832 SF BUILDING AREA





 $\bigcirc$ 

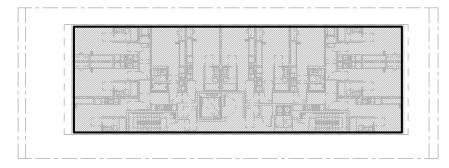



3,832 SF BUILDING AREA



1531-1535 S. SAWTELLE BOULEVARD LOS ANGELES, CA 90025

05 / PROJECT NAME & ADDRESS

06 / REVISIONS

NO.	DATE	DESCRIPTION
01	12/2022	ENITITLEMENTS
02	12/2022	PERMIT
03	06/2023	ENITITLEMENTS REV I
04	/2023	ENITITLEMENTS REV 2
05	01/2024	ENITITLEMENTS REV 3

07 / SHEET TITLE

BUILDING AREA DIAGRAMS

08 / SHEET NUMBER



				3-27 +254.14
			+2:2 2/*/+55	3.18
				-2'0'( +252.9)

3,819 SF BUILDING AREA



FLOOR AREA, FAR (LAMC ZONING CODE):

THE AREA IN SQUARE FEET CONFINED WITHIN THE EXTERIOR WALLS OF A BUILDING, BUT NOT INCLUDING THE AREA OF THE FOLLOWING: EXTERIOR WALLS, STAIRWAYS, SHAFTS, ROOMS HOUSING BUILDING-OPERATING EQUIPMENT OR MACHINERY, PARKING AREAS WITH ASOCIATED DRIVEWAYS AND RAMPS, SPACE DEDICATED TO BICYCLE PARKING, SPACE FOR THE LANDING AND STORAGE OF HELICOPTERS, AND BASEMENT STORAGE AREAS.


(LAMC SEC. 12.03 / LADBS BULLETIN P/BC-2002-021)



### FAR / FLOOR AREA RATIO

Level	FAR	
Basement		SF
LI	2,868	SF
L2	3,300	SF
L3	3,300	SF
L4	3,300	SF
L5	3,204	SF
Total, Proposed	15,972	SF
Buildable Area	4,922.0	SF
Ratio, Proposed	3.2	:1



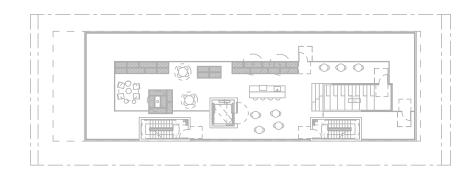

0 SF

06 FAR / ROOF SCALE 1/32" = 1'-0"

3,204 SF BUILDING AREA





01 / ARCHITECT


## 64NORTH 719 N. FAIRFAX AVENUE, SUITE C LOS ANGELES, CA 90046 T 310 919 0919 / F 310 933 0550 64NORTH.COM

02 / CLIENT & TEAM

CLIENT / TRIPALINK DESIGN, INC. 2905 S VERMONT AVENUE, SUITE 202 LOS ANGELES, CALIFORNIA 90007 CIVIL ENGINEER / LFA 319 MAIN STREET EL SEGUNDO, CALIFORNIA 90245 (213) 239 9700 STRUCTURAL ENGINEER / IDG 10866 WIMER COUNTRY ROAD, LOS ANGELES, CA 91040 (323) 257-8854 OFFICE MECHANICAL, ELECTRICAL & PLUMBING ENGINEER / MEP CALIFORNIA ENGINEERING CORP 1920 MAIN ST. SUITE 980 IRVINE, CA 92614 EXTERIOR BUILDING MAINTENANCE / LFA 319 MAIN STREET EL SEGUNDO, CALIFORNIA 90245 (213) 239 9700 SURVEYOR / THE LAND SURVEYOR 1215 W. IMPERIAL HIGHWAY, SUIT 208 BREA, CA 92821 (714) 376-7123 SAM@THELANDSURVEYOR.COM

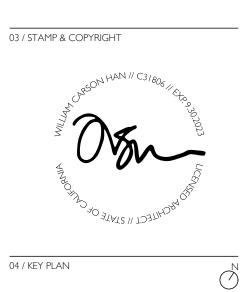

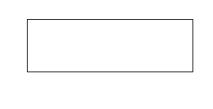

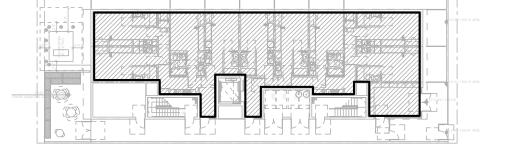

2,868 SF BUILDING AREA

3,300 SF BUILDING AREA

04 FAR / LEVELS 2-4 SCALE 1/32" = 1'-0"

03 FAR / LEVEL I SCALE 1/32" = 1'-0"

05 / PROJECT NAME & ADDRESS

## 1531-1535 S. SAWTELLE BOULEVARD LOS ANGELES, CA 90025


06 / REVISIONS

NO.	DATE	DESCRIPTION
01	12/2022	ENITITLEMENTS
02	12/2022	PERMIT
03	06/2023	ENITITLEMENTS REV I
04	11/2023	ENITITLEMENTS REV 2
05	01/2024	ENITITLEMENTS REV 3

07 / SHEET TITLE





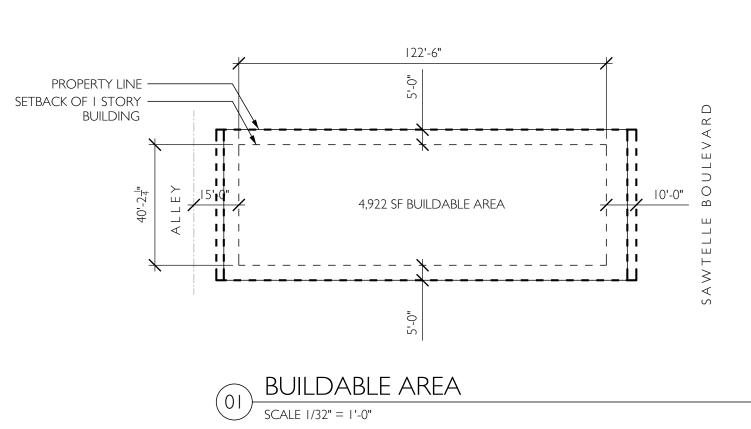



# EACH UNIT HAVING MORE THAN THREE HABITABLE ROOMS.

(A) COMMON OPEN SPACE: AS PROVIDED IN SECTION 12.22 C.20.(B),

(II) BE READILY ACCESSIBLE TO ALL THE RESIDENTS OF THE SITE,

1/15/03.)

RA\$3, R4, RA\$4, AND/OR R5 DENSITY REGARDLESS OF THE UNDERLYING ZONE. (AMENDED BY ORD. NO. 174,999, EFF. 1/15/03.)

ORD. NO. 184,505, EFF. 1/11/17.)

(4) NOTWITHSTANDING THE PROVISIONS SET FORTH IN THIS PARAGRAPH:

(I) RECREATION ROOMS AT LEAST 600 SQUARE FEET IN AREA FOR A DEVELOPMENT OF 16 OR MORE DWELLING UNITS, OR AT LEAST 400 SQUARE FEET IN AREA FOR A DEVELOPMENT OF FEWER THAN 16 DWELLING UNITS, MAY QUALIFY AS COMMON OPEN SPACE, BUT SHALL NOT QUALIFY FOR MORE THAN 25 PERCENT OF THE TOTAL REQUIRED ÙSABLE OPEN SPACE.

(II) ROOF DECKS IN DEVELOPMENTS BUILT AT AN R3 OR AN RAS3 DENSITY, REGARDLESS OF THE UNDERLYING ZONE, MAY BE USED AS COMMON OPEN SPACE, EXCLUDING THAT PORTION OF THE ROOF WITHIN TEN FEET FROM THE PARAPET WALL. (AMENDED BY ORD. NO. 174,999, EFF. 1/15/03.)

(III) ROOF DECKS IN DEVELOPMENTS BUILT AT AN R4, RAS4, AND/OR R5 DENSITY, REGARDLESS OF THE UNDERLYING ZONE, MAY BE USED IN THEIR ENTIRETY AS COMMON OPEN SPACE. (AMENDED BY ORD. NO. 174,999, EFF. 1/15/03.) (B) PRIVATE OPEN SPACE. PRIVATE OPEN SPACE IS AN OPEN SPACE AREA WHICH IS CONTIGUOUS TO AND IMMEDIATELY ACCESSIBLE FROM A SINGLE DWELLING UNIT AND WHICH MEETS ALL OF THE FOLLOWING

REQUIREMENTS OF THE ZONES HEREIN SPECIFIED: (I) IN THE RD 1.5 AND MORE RESTRICTIVE ZONES: () PRIVATE OPEN SPACE SHALL BE LOCATED AT GRADE LEVEL OR THE FIRST HABITABLE ROOM LEVEL AND BE OPEN TO THE SKY. STRUCTURES MAY PROJECT NO MORE THAN THREE FEET INTO THE PRIVATE OPEN SPACE AREA, PROVIDED THERE IS A MINIMUM EIGHT FOOT VERTICAL CLEARANCE UNDER THE PROJECTION, EXCEPT AS PROVIDED IN SECTION

12.22 C.20.(B); (II) PRIVATE OPEN SPACE SHALL BE ENCLOSED BY A SOLID FENCE AT LEAST FOUR FEET IN HEIGHT; AND (III) THE PRIVATE OPEN SPACE AREA SHALL HAVE NO HORIZONTAL DIMENSION LESS THAN EIGHT FEET, WHEN MEASURED PERPENDICULAR FROM ANY POINT ON EACH OF THE BOUNDARIES OF THE OPEN SPACE AREA AND CONTAIN A MINIMUM OF 100 SQUARE FEET OF WHICH NO MORE THAN 100 SQUARE FEET PER DWELLING UNIT SHALL

BE ATTRIBUTABLE TO THE TOTAL REQUIRED OPEN SPACE. (2) (AMENDED BY ORD. NO. 174,999, EFF. 1/15/03.) IN DEVELOPMENTS BUILT AT AN R3, RAS3, R4, RAS4, AND/OR R5 DÉNŠITY REGARDLESS OF THE UNDERLYING ZONÉ, PRIVATE OPEN SPACE MAY BE PROVIDED ABOVE THE FIRST

HABITABLE ROOM LEVEL. WHEN SO PROVIDED, IT SHALL: (I) CONTAIN A MINIMUM OF 50 SQUARE FEET OF WHICH NO MORE THAN 50 SQUARE FEET PER DWELLING UNIT SHALL BÉ ATTRIBUTABLE TO THE TOTAL RÉQUIRED USABLE OPEN SPACE;

(II) HAVE NO HORIZONTAL DIMENSION LESS THAN SIX FEET WHEN MEASURED PERPENDICULAR FROM ANY POINT ON EACH OF THE BOUNDARIES OF THE OPEN SPACE AREA; AND (III) PROVIDE A MINIMUM EIGHT FOOT VERTICAL CLEARANCE UNDER ANY PROJECTION, EXCEPT AS PROVIDED IN

SECTION 12.22 C.20.(B); AND (IV) THAT PORTION OF A BALCONY WHICH EXTENDS OR PROJECTS INTO A REQUIRED FRONT YARD IN COMPLIANCE WITH SECTION 12.22 C.20.(D) MAY QUALIFY AS USABLE OPEN SPACE PROVIDED IT MEETS EACH OF THE ABOVE SPECIFIED REQUIREMENTS SET FORTH IN THIS SUBPARAGRAPH.



### OPEN SPACE DEFINITION / LAMC

THE DIRECTOR OF PLANNING OR THE DIRECTOR'S DESIGNEE SHALL HAVE THE AUTHORITY TO REVIEW AND APPROVE OR DISAPPROVE ALL PROPOSED LANDSCAPE PLANS SUBMITTED IN COMPLIANCE WITH THIS PARAGRAPH.

(3) A MINIMUM OF 25 PERCENT OF THE COMMON OPEN SPACE AREA SHALL BE PLANTED WITH GROUND COVER, (3) A PININITON OF 25 FERCENT OF THE CONTINUON OFEN SPACE AREA SHALL BE PLANTED WITH GROUND COVER, SHRUBS OR TREES. AT LEAST ONE 24-INCH BOX TREE FOR EVERY FOUR DWELLING UNITS SHALL BE PROVIDED ON SITE AND MAY INCLUDE STREET TREES IN THE PARKWAY. FOR A SURFACE AREA NOT LOCATED DIRECTLY ON FINISHED GRADE THAT IS USED FOR COMMON OPEN SPACE, AND LOCATED AT GROUND LEVEL OR THE FIRST HABITABLE ROOM LEVEL, SHRUBS AND/OR TREES SHALL BE CONTAINED WITHIN PERMANENT PLANTERS AT LEAST 30-INCHES IN DEPTH, AND LAWN OR GROUND COVER SHALL BE AT LEAST 12-INCHES IN DEPTH. ALL REQUIRED LANDSCAPED AREAS SHALL BE EQUIPPED WITH AN AUTOMATIC IRRIGATION SYSTEM AND BE PROPERLY DRAINED.

(2) COMMON OPEN SPACE AREAS SHALL INCORPORATE RECREATIONAL AMENITIES SUCH AS SWIMMING POOLS, SPAS, PICNIC TABLES, BENCHES, CHILDREN'S PLAY AREAS, BALL COURTS, BARBECUE AREAS AND SITTING AREAS. (AMENDED BY

(IV) CONSTITUTE AT LEAST 50% OF THE TOTAL REQUIRED USABLE OPEN SPACE IN DEVELOPMENTS BUILT AT AN R3, RAS3, R4, RAS4, AND/OR R5 DENSITY REGARDLESS OF THE UNDERLYING ZONE. (AMENDED BY ORD. NO. 174,999, EFF. (V) BE LOCATED AT THE GRADE LEVEL OR FIRST HABITABLE ROOM LEVEL, EXCEPT IN DEVELOPMENTS BUILT AT AN R3,

(III) HAVE A MINIMUM AREA OF 400 SQ. FT. WITH NO HORIZONTAL DIMENSION LESS THAN 15 FEET WHEN MEASURED PERPENDICULAR FROM ANY POINT ON EACH OF THE BOUNDARIES OF THE OPEN SPACE AREA,

(I) COMMON OPEN SPACE SHALL MEET EACH OF THE FOLLOWING REQUIREMENTS: (I) BE OPEN TO THE SKY AND HAVE NO STRUCTURES THAT PROJECT INTO THE COMMON OPEN SPACE AREA, EXCEPT


AS OTHERWISE PROVIDED FOR HEREIN, SHALL NOT QUALIFY AS USABLE OPEN SPACE.

FOR PURPOSES OF THIS SUBSECTION, USABLE OPEN SPACE SHALL MEAN AN AREA WHICH IS DESIGNED AND INTENDED TO BE USED FOR ACTIVE OR PASSIVE RECREATION. USABLE OPEN SPACE MAY CONSIST OF PRIVATE AND/OR COMMON AREA AS FURTHER DEFINED AND REGULATED HEREIN. PARKING AREAS, INCLUDING ACCESS AISLES, DRIVEWAYS, AND REQUIRED FRONT AND SIDE YARDS, OPEN SPACE AREAS LOCATED ABOVE THE FIRST HABITABLE ROOM LEVEL, EXCEPT

NEW CONSTRUCTION (RESULTING IN ADDITIONAL FLOOR AREA AND ADDITIONAL UNITS) OF A BUILDING OR GROUP OF BUILDINGS CONTAINING SIX OR MORE DWELLING UNITS ON A LOT SHALL PROVIDE AT A MINIMUM THE FOLLOWING USABLE OPEN SPACE PER DWELLING UNIT: 100 SQUARE FEET FOR EACH UNIT HAVING LESS THAN THREE HABITABLE ROOMS; 125 SQUARE FEET FOR EACH UNIT HAVING THREE HABITABLE ROOMS; AND 175 SQUARE FEET FOR

OPEN SPACE CALCULATION

MIN. 394 SF LANDSCAPED OPEN SPACE REQUIRED (25%) 394 SF LANDSCAPED OPEN SPACE PROVIDED

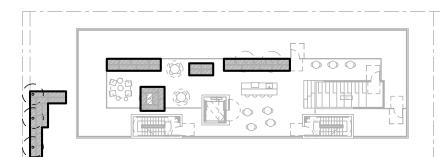

OPEN SPACE quired

Unit Type

Subtotal

otal. Required

**Recreation Room** 

vided

Total

Level I

Rooftop Total

TREES

eauired

Less Than 3 Hab. Rooms (Studio & I-Beds)

More Than 3 Hab. Rooms (3+ Bedrooms)

3 Habitable Rooms (2-Beds)

Interior Common Spaces

Maximum (25% of Total)

Exterior Common Spaces

Planted (25% of Total)

Total, Provided

I Tree Per 4 Units

Trees on Site

( 05 )-

No. Units SF Req. Per Total Req.

100

125

175

0 SF

0 SF

1,575 SF 1,575 SF

1,575 SF

1,632 SF 394 SF

394 SF

364 SF

817 SF

1,575 SF

394 SF

1,575 SF





OPEN SPACE LANDSCAPE SCALE 1/32" = 1'-0"

01 / ARCHITECT

#### 64NORTH 719 N. FAIRFAX AVENUE, SUITE C LOS ANGELES, CA 90046 T 310 919 0919 / F 310 933 0550 64NORTH.COM

02 / CLIENT & TEAM

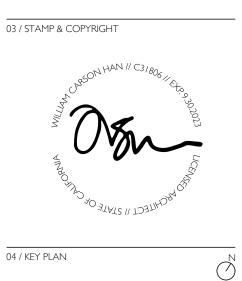

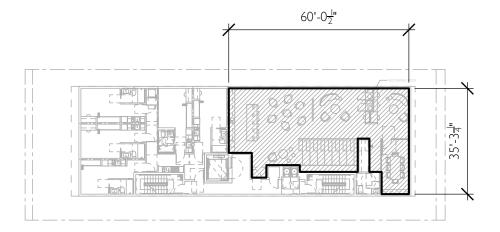

I,632 SF INTERIOR COMMON OPEN SPACE PROVIDED.

29'-2<u>4</u>"

817 SF EXTERIOR COMMON OPEN SPACE

SCALE 1/32" = 1'-0"

OPEN SPACE / ROOF LEVEL

10'-0

(02)-

39'-5

OPEN SPACE / LEVEL 5 SCALE 1/32" = 1'-0"

05 / PROJECT NAME & ADDRESS

#### 1531-1535 S. SAWTELLE BOULEVARD LOS ANGELES, CA 90025

06 / REVISIONS

NO.	DATE	DESCRIPTION
01	12/2022	ENITITLEMENTS
02	12/2022	PERMIT
03	06/2023	ENITITLEMENTS REV I
04	/2023	ENITITLEMENTS REV 2
05	01/2024	ENITITLEMENTS REV 3

07 / SHEET TITLE

### OPEN SPACE DIAGRAM


08 / SHEET NUMBER



15'-!	5 <u>8</u> "				
					(17.2) + 25.0 (17.2) + 25.0 (17.2) + 25.0 (17.2) + 25.0

365 SF EXTERIOR COMMON OPEN SPACE


OPEN SPACE / GROUND LEVEL SCALE 1/32" = 1'-0"

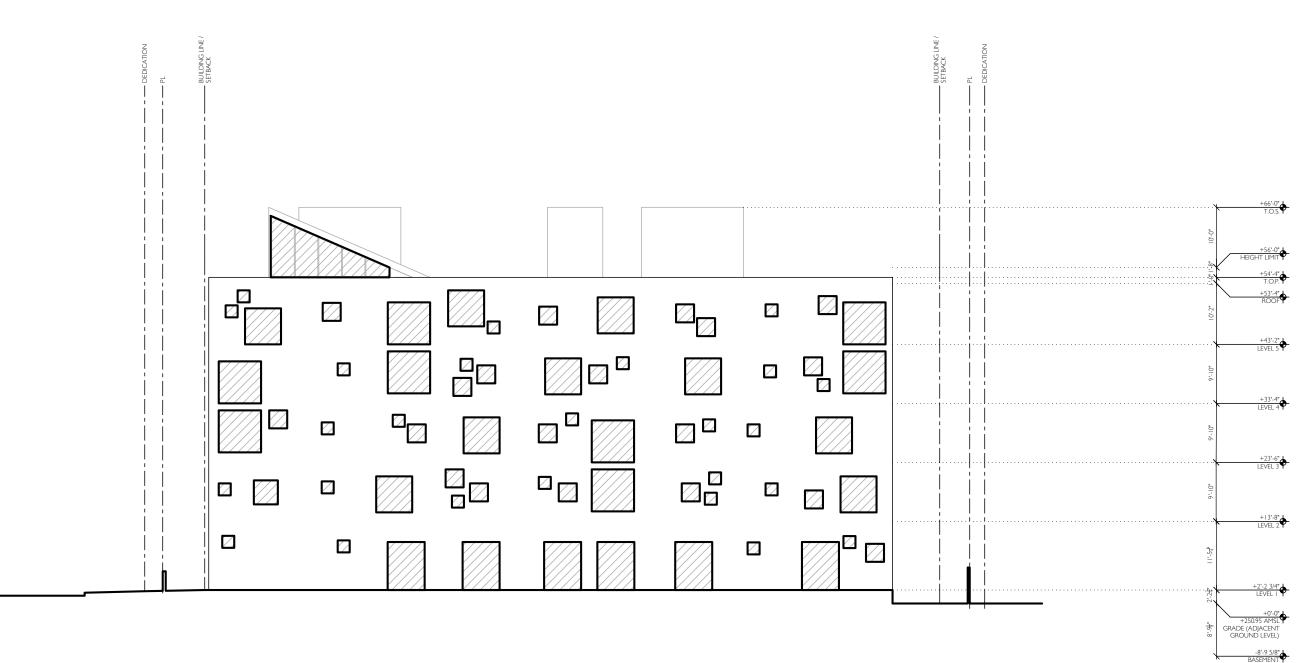

#### OPENINGS


FLOOR	TOTAL SF	ALLOWABLE %	ALLOWABLE SF	PROPOSED SF
01	1303 SF	25%	325 SF	253 SF
02	1120 SF	25%	280 SF	210 SF
03	1120 SF	25%	280 SF	226 SF
04	1120 SF	25%	280 SF	276 SF
05	1272 SF	25%	318 SF	267 SF
ROOF	156 SF	75%	117 SF	I I 7 SF



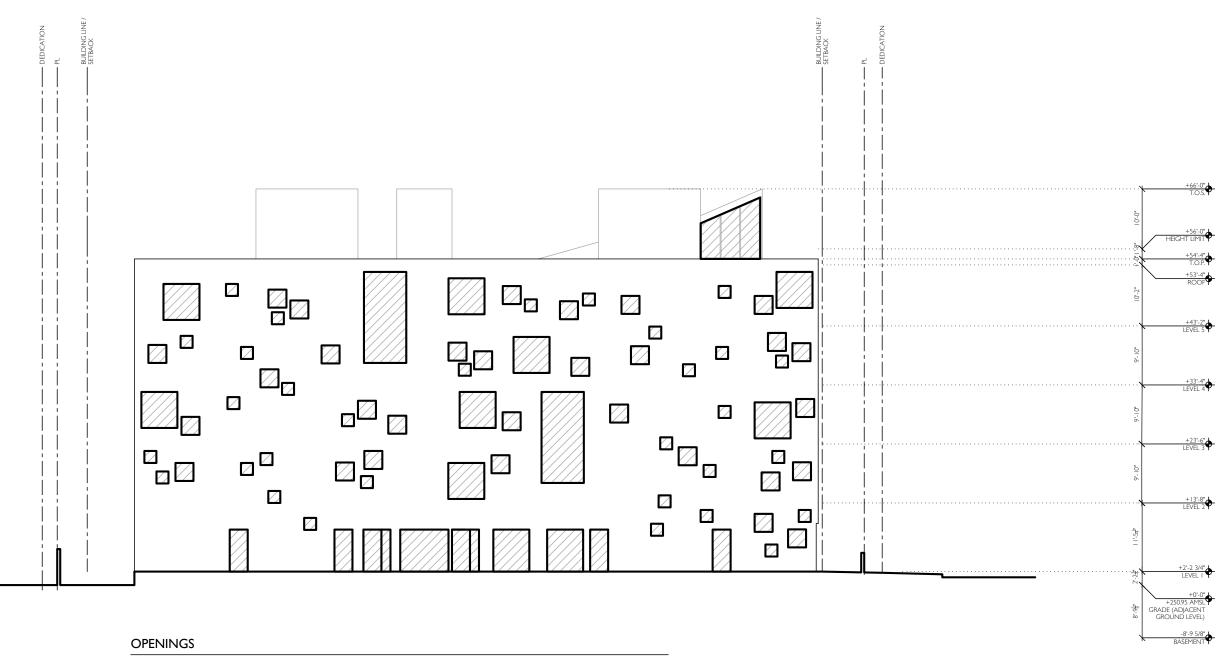

OPENINGS				
FLOOR	TOTAL SF	ALLOWABLE %	ALLOWABLE SF	PROPOSED SF
01	1300 SF	25%	325 SF	325 SF
02	1127 SF	25%	281 SF	278 SF
03	1127 SF	25%	281 SF	273 SF
04	1127 SF	25%	281 SF	277 SF
05	1127 SF	25%	281 SF	276 SF
ROOF	242 SF	UNLIMITED	UNLIMITED	80 SF




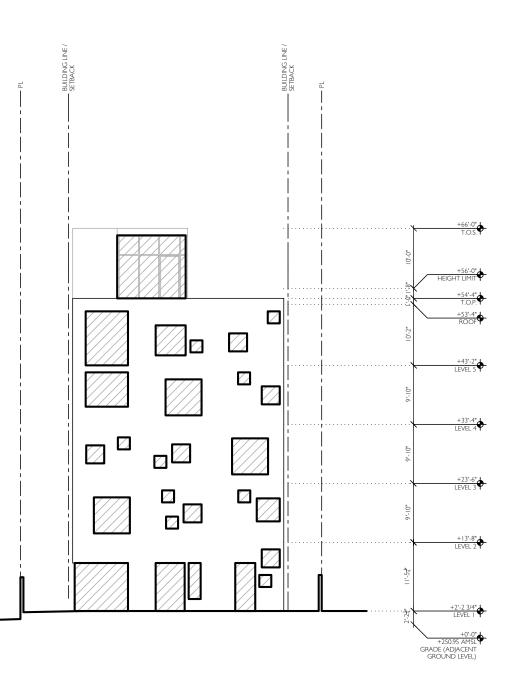

OPENINGS


FLOOR	TOTAL SF	ALLOWABLE %	ALLOWABLE SF	PROPOSED SF
01	377 SF	UNLIMITED	UNLIMITED	160 SF
02	359 SF	UNLIMITED	UNLIMITED	71 SF
03	359 SF	UNLIMITED	UNLIMITED	62 SF
04	359 SF	UNLIMITED	UNLIMITED	89 SF
05	408 SF	UNLIMITED	UNLIMITED	105 SF
ROOF	137 SF	UNLIMITED	UNLIMITED	104 SF

WEST ELEVATION 03 SCALE I/16" = 1'-0"

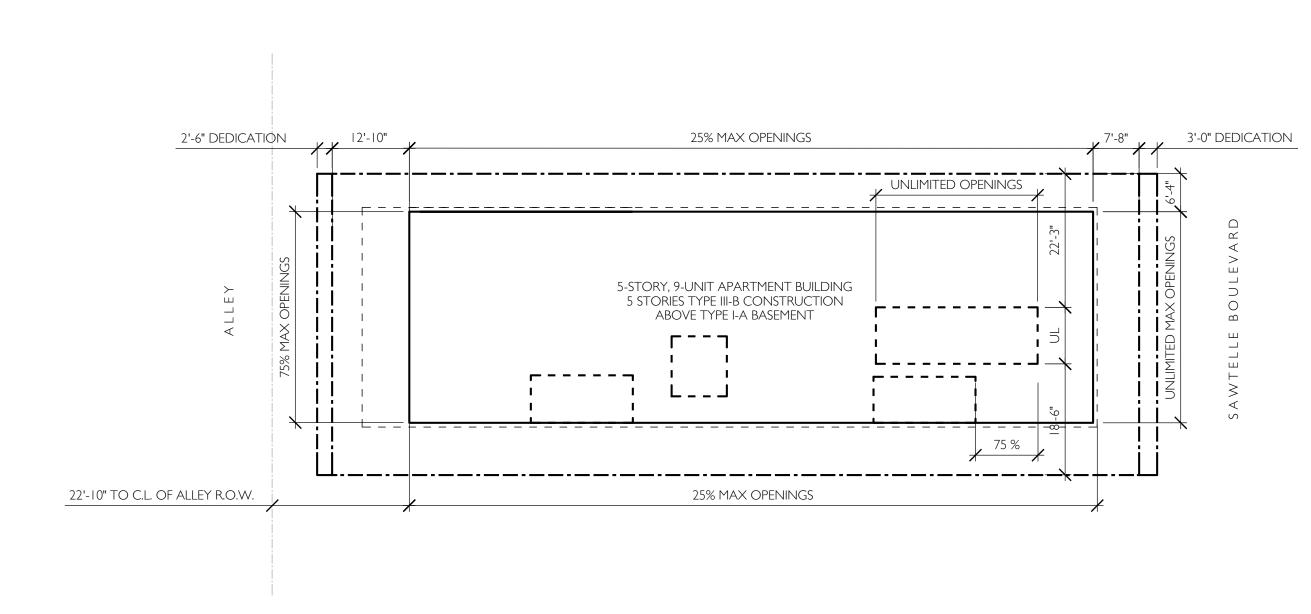

## 64NORTH 719 N. FAIRFAX AVENUE, SUITE C LOS ANGELES, CA 90046 T 310 919 0919 / F 310 933 0550 64NORTH.COM

02 / CLIENT & TEAM

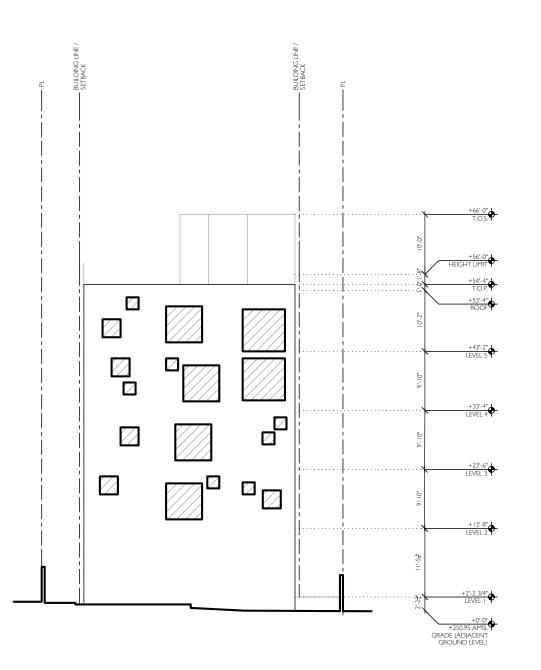


### CLIENT / TRIPALINK DESIGN, INC. 2905 S VERMONT AVENUE, SUITE 202 LOS ANGELES, CALIFORNIA 90007 CIVIL ENGINEER / LFA 319 MAIN STREET EL SEGUNDO, CALIFORNIA 90245 (213) 239 9700 STRUCTURAL ENGINEER / IDG 10866 WIMER COUNTRY ROAD, LOS ANGELES, CA 91040 (323) 257-8854 OFFICE MECHANICAL, ELECTRICAL & PLUMBING ENGINEER / MEP CALIFORNIA ENGINEERING CORP 1920 MAIN ST. SUITE 980 IRVINE, CA 92614 EXTERIOR BUILDING MAINTENANCE / LFA 319 MAIN STREET EL SEGUNDO, CALIFORNIA 90245 (213) 239 9700 SURVEYOR / THE LAND SURVEYOR 1215 W. IMPERIAL HIGHWAY, SUIT 208 BREA, CA 92821 (714) 376-7123 SAM@THELANDSURVEYOR.COM

### OPENINGS

FLOOR	TOTAL SF	ALLOWABLE %	ALLOWABLE SF	PROPOSED SF
01	421 SF	75%	315 SF	0 SF
02	304 SF	75%	228 SF	62 SF
03	304 SF	75%	228 SF	53 SF
04	304 SF	75%	228 SF	109 SF
05	392 SF	75%	294 SF	93 SF
ROOF	217 SF	UNLIMITED	UNLIMITED	0 SF



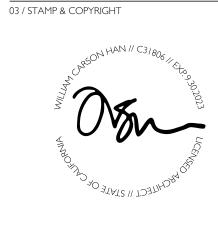

04 / KEY PLAN

 $\bigcirc$ 



05 / PROJECT NAME & ADDRESS

## 1531-1535 S. SAWTELLE BOULEVARD LOS ANGELES, CA 90025

06 / REVISIONS

NO.	DATE	DESCRIPTION
01	12/2022	ENITITLEMENTS
02	12/2022	PERMIT
03	06/2023	ENITITLEMENTS REV I
04	/2023	ENITITLEMENTS REV 2
05	01/2024	ENITITLEMENTS REV 3
-		

07 / SHEET TITLE


ALLOWABLE OPENINGS DIAGRAMS


08 / SHEET NUMBER



ALLOWABLE OPENINGS PLAN 01 SCALE I/I6" = I'-0"

3,855 SF BUILDING AREA

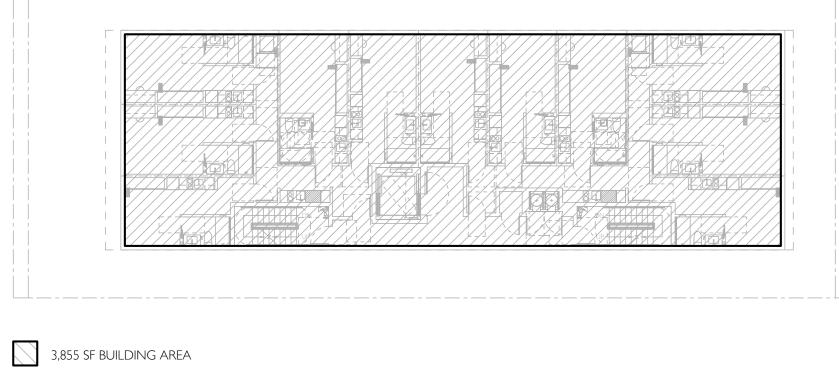

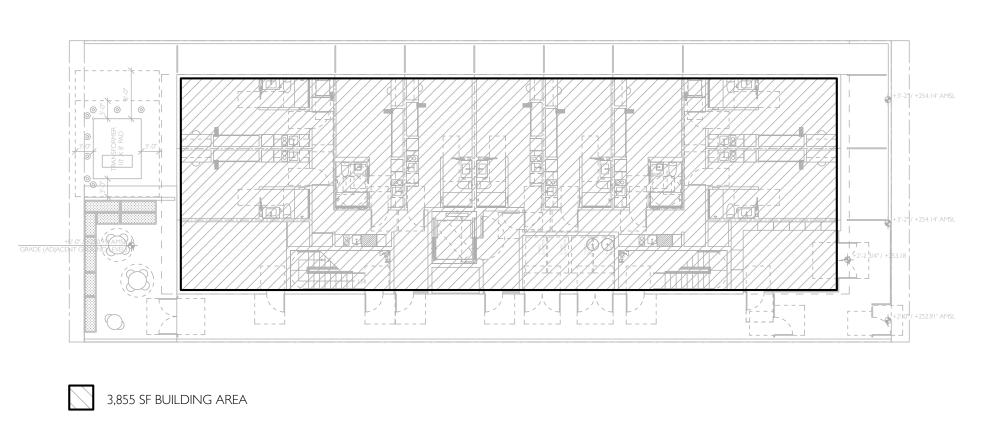

LEVEL	TYPE	SF PROVIDED	
LEVEL I	TYPE III-A	3,855	
LEVEL 2	TYPE III-A	3,855	
LEVEL 3	TYPE III-A	3,855	
LEVEL 4	TYPE III-A	3,855	
LEVEL 5	TYPE III-A	3,855	
TOTAL		19,275	

02 / CLIENT & TEAM

CLIENT / TRIPALINK DESIGN, INC. 2905 S VERMONT AVENUE, SUITE 202 LOS ANGELES, CALIFORNIA 90007

CIVIL ENGINEER / LFA 319 MAIN STREET EL SEGUNDO, CALIFORNIA 90245 (213) 239 9700


STRUCTURAL ENGINEER / IDG 10866 WIMER COUNTRY ROAD, LOS ANGELES, CA 91040 (323) 257-8854 OFFICE

MECHANICAL, ELECTRICAL & PLUMBING ENGINEER / MEP CALIFORNIA ENGINEERING CORP 1920 MAIN ST. SUITE 980 IRVINE, CA 92614

EXTERIOR BUILDING MAINTENANCE / LFA 319 MAIN STREET EL SEGUNDO, CALIFORNIA 90245 (213) 239 9700

SURVEYOR / THE LAND SURVEYOR 1215 W. IMPERIAL HIGHWAY, SUIT 208 BREA, CA 92821 (714) 376-7123 SAM@THELANDSURVEYOR.COM

03 / STAMP & COPYRIGHT

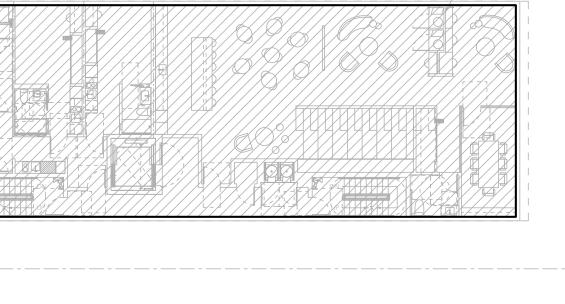





02 BUILDING AREA / LEVEL 2-4 SCALE I/16" = 1'-0"

04 / KEY PLAN  $\bigcirc$ 



05 / PROJECT NAME & ADDRESS

## 1531-1535 S. SAWTELLE BOULEVARD LOS ANGELES, CA 90025

06 / REVISIONS


NO.	DATE	DESCRIPTION
01	12/2022	ENITITLEMENTS
02	12/2022	PERMIT
03	06/2023	ENITITLEMENTS REV I
04	11/2023	ENITITLEMENTS REV 2
05	01/2024	ENITITLEMENTS REV 3

07 / SHEET TITLE

BUILDING AREA ANALYSIS





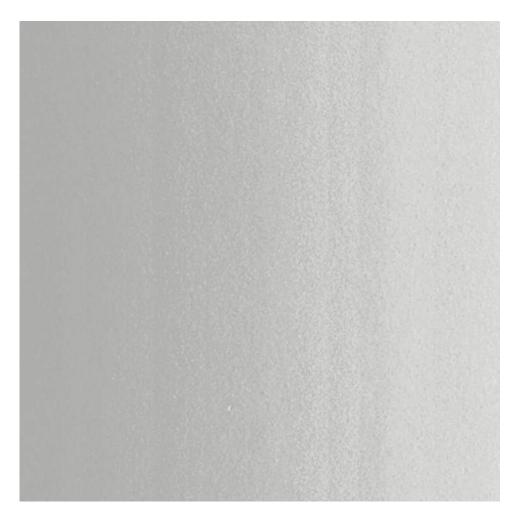

01 / SIDING / FC-1 FIBER CEMENT PANELS -HARDIE BOARD VERTICAL SIDING COLOR: ARCTIC WHITE



02 / SIDING / FC-2 FIBER CEMENT PANELS -COLOR: IRON GRAY



04 / WINDOWS / MT-2 ALUMINUM COLOR: ANODIZED CHARCOAL






03 / WINDOW HOODS / MT-I PAINTED METAL WINDOW HOODS COLOR: RED, WHITE




METAL PAINT COLOR: DUNN EDWARDS DET412 - RED HEART THROB



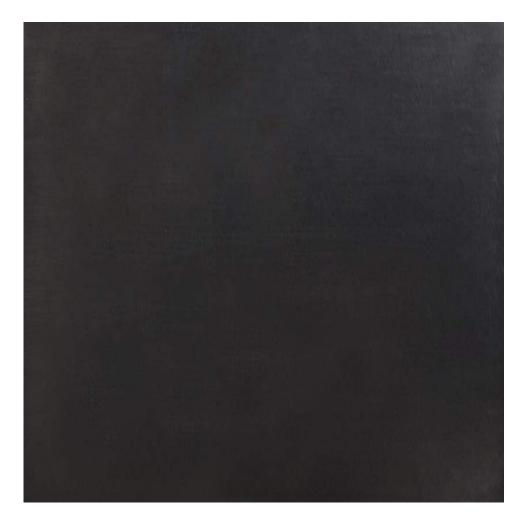

05 / METAL FENCE / MT-3 ALUMINUM COLOR: ANODIZED CHARCOAL



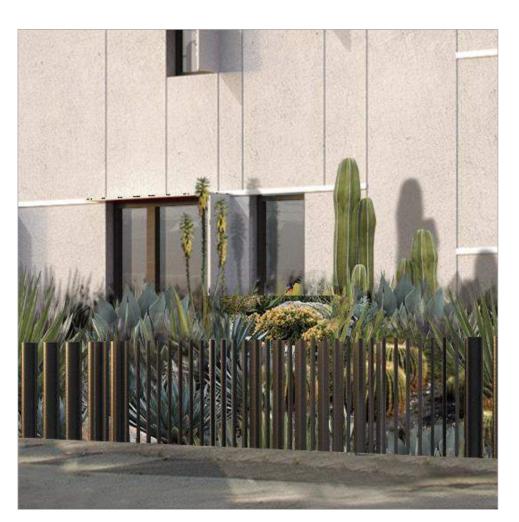



64NORTH 719 N. FAIRFAX AVENUE, SUITE C LOS ANGELES, CA 90046 T 310 919 0919 / F 310 933 0550 64NORTH.COM

02 / CLIENT & TEAM

01 / ARCHITECT

CLIENT / TRIPALINK DESIGN, INC. 2905 S VERMONT AVENUE, SUITE 202 LOS ANGELES, CALIFORNIA 90007 CIVIL ENGINEER / LFA 319 MAIN STREET EL SEGUNDO, CALIFORNIA 90245 (213) 239 9700 STRUCTURAL ENGINEER / IDG 10866 WIMER COUNTRY ROAD, LOS ANGELES, CA 91040 (323) 257-8854 OFFICE MECHANICAL, ELECTRICAL & PLUMBING ENGINEER / MEP CALIFORNIA ENGINEERING CORP 1920 MAIN ST. SUITE 980 IRVINE, CA 92614 EXTERIOR BUILDING MAINTENANCE / LFA 319 MAIN STREET EL SEGUNDO, CALIFORNIA 90245 (213) 239 9700 SURVEYOR / THE LAND SURVEYOR 1215 W. IMPERIAL HIGHWAY, SUIT 208 BREA, CA 92821 (714) 376-7123 SAM@THELANDSURVEYOR.COM

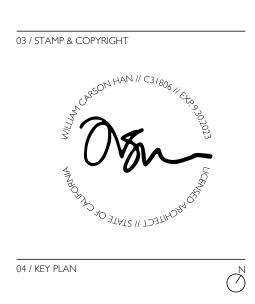

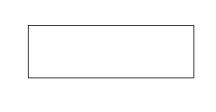

05 / PROJECT NAME & ADDRESS

1531-1535 S. SAWTELLE BOULEVARD LOS ANGELES, CA 90025


06 / REVISIONS

NO.	DATE	DESCRIPTION
01	12/2022	ENITITLEMENTS
02	12/2022	PERMIT
03	06/2023	ENITITLEMENTS REV I
04	/2023	ENITITLEMENTS REV 2
05	01/2024	ENITITLEMENTS REV 3

07 / SHEET TITLE






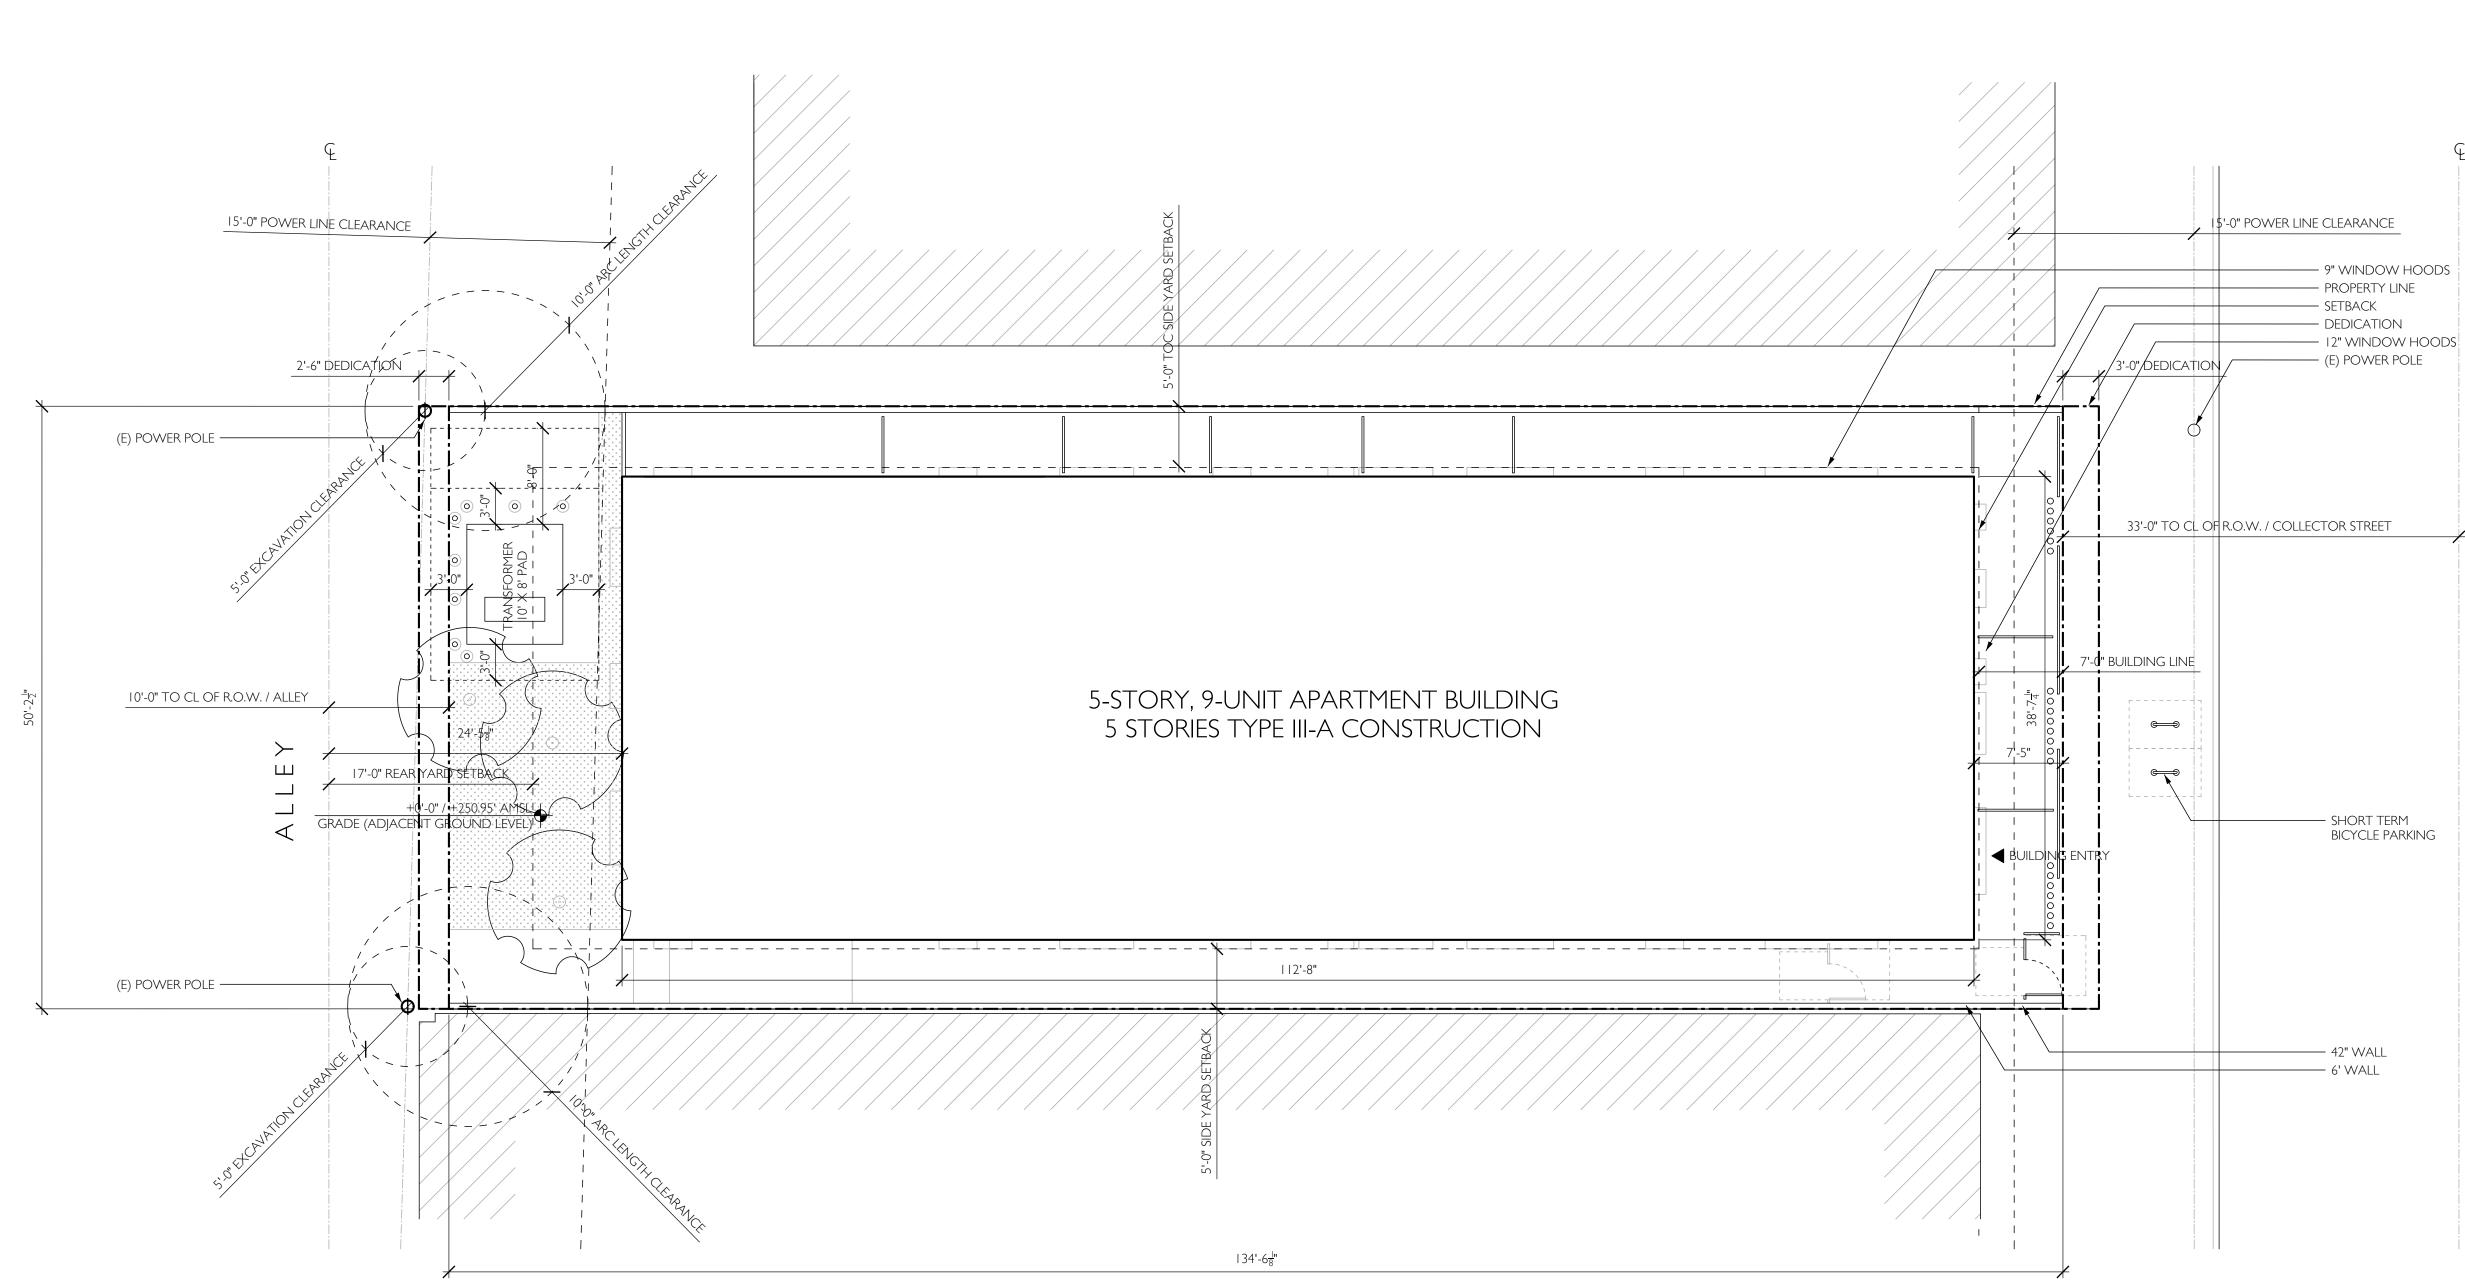


02 / CLIENT & TEAM

## CLIENT / TRIPALINK DESIGN, INC. 2905 S VERMONT AVENUE, SUITE 202 LOS ANGELES, CALIFORNIA 90007 CIVIL ENGINEER / LFA 319 MAIN STREET EL SEGUNDO, CALIFORNIA 90245 (213) 239 9700 STRUCTURAL ENGINEER / IDG 10866 WIMER COUNTRY ROAD, LOS ANGELES, CA 91040 (323) 257-8854 OFFICE MECHANICAL, ELECTRICAL & PLUMBING ENGINEER / MEP CALIFORNIA ENGINEERING CORP 1920 MAIN ST. SUITE 980 IRVINE, CA 92614 EXTERIOR BUILDING MAINTENANCE / LFA 319 MAIN STREET EL SEGUNDO, CALIFORNIA 90245 (213) 239 9700 SURVEYOR / THE LAND SURVEYOR 1215 W. IMPERIAL HIGHWAY, SUIT 208 BREA, CA 92821 (714) 376-7123 SAM@THELANDSURVEYOR.COM

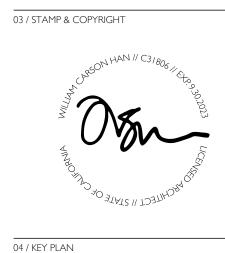



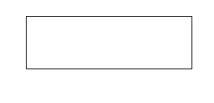

05 / PROJECT NAME & ADDRESS

## 1531-1535 S. SAWTELLE BOULEVARD LOS ANGELES, CA 90025

06 / REVISIONS

NO.	DATE	DESCRIPTION
01	12/2022	ENITITLEMENTS
02	12/2022	PERMIT
03	06/2023	ENITITLEMENTS REV I
04	11/2023	ENITITLEMENTS REV 2
05	01/2024	ENITITLEMENTS REV 3

07 / SHEET TITLE




08 / SHEET NUMBER



 $\square$  $\propto$  $\triangleleft$ >ш  $\supset$ Ο В Ш  $\leq$ SA



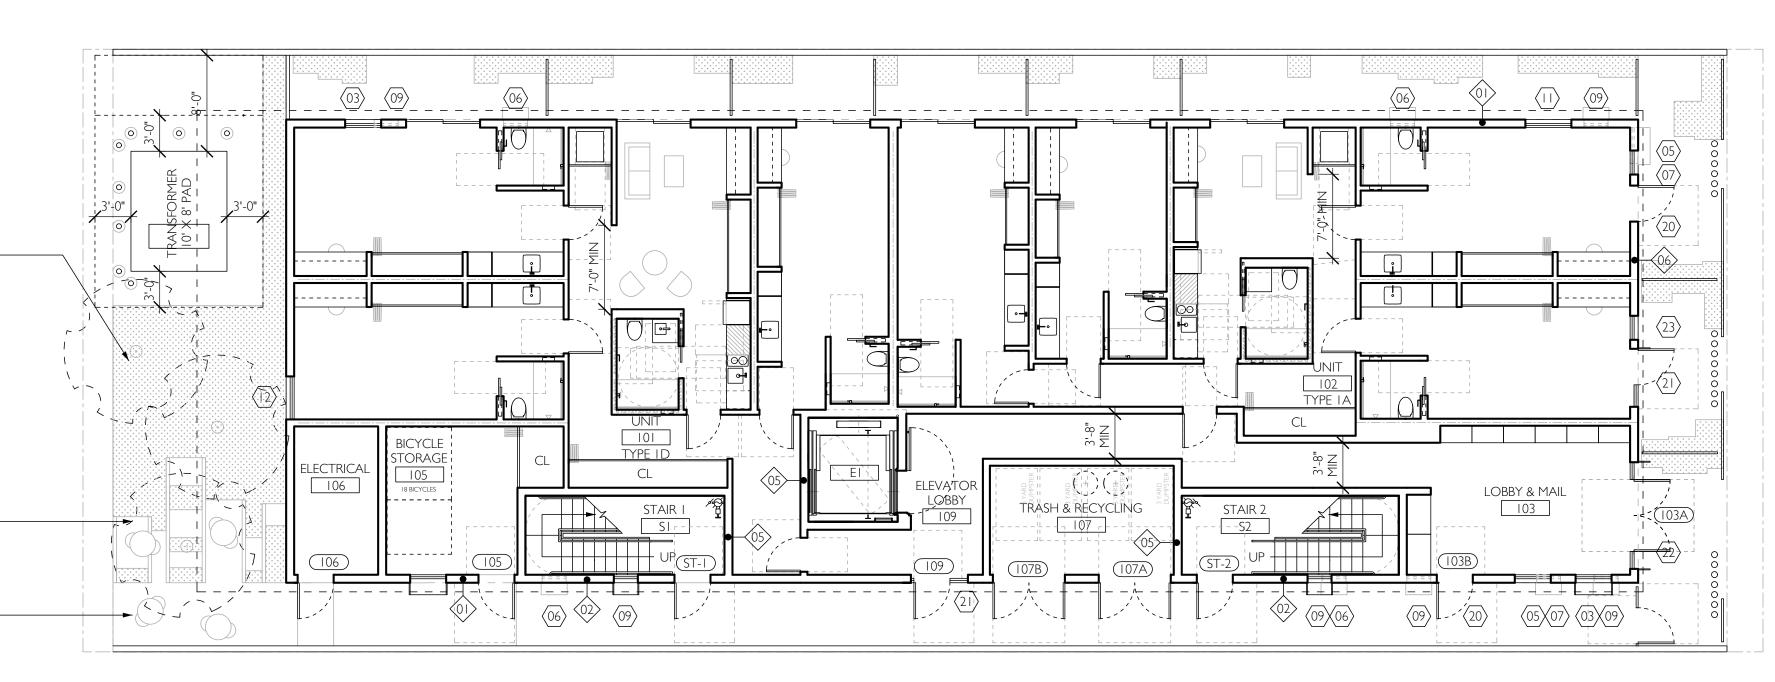

IN-GROUND LID PLANTER -----



01 (A303)

(01 (A401)

ON-SITE SHADE TREES —

COMMON OPEN SPACE SEATING —



01 A301

## 64NORTH 719 N. FAIRFAX AVENUE, SUITE C LOS ANGELES, CA 90046 T 310 919 0919 / F 310 933 0550 64NORTH.COM

02 / CLIENT & TEAM

## CLIENT / TRIPALINK DESIGN, INC. 2905 S VERMONT AVENUE, SUITE 202 LOS ANGELES, CALIFORNIA 90007

CIVIL ENGINEER / LFA 319 MAIN STREET EL SEGUNDO, CALIFORNIA 90245 (213) 239 9700

STRUCTURAL ENGINEER / IDG 10866 WIMER COUNTRY ROAD, LOS ANGELES, CA 91040 (323) 257-8854 OFFICE

MECHANICAL, ELECTRICAL & PLUMBING ENGINEER / MEP CALIFORNIA ENGINEERING CORP 1920 MAIN ST. SUITE 980 IRVINE, CA 92614 EXTERIOR BUILDING MAINTENANCE / LFA 319 MAIN STREET EL SEGUNDO, CALIFORNIA 90245 (213) 239 9700

SURVEYOR / THE LAND SURVEYOR 1215 W. IMPERIAL HIGHWAY, SUIT 208 BREA, CA 92821 (714) 376-7123 SAM@THELANDSURVEYOR.COM




04 / KEY PLAN

01 A401

(A40)



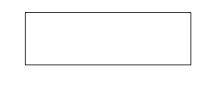

05 / PROJECT NAME & ADDRESS

## 1531-1535 S. SAWTELLE BOULEVARD LOS ANGELES, CA 90025

06 / REVISIONS

DATE	DESCRIPTION
12/2022	ENITITLEMENTS
12/2022	PERMIT
06/2023	ENITITLEMENTS REV I
11/2023	ENITITLEMENTS REV 2
01/2024	ENITITLEMENTS REV 3
	12/2022 12/2022 06/2023 11/2023

07 / SHEET TITLE




08 / SHEET NUMBER





02 A303



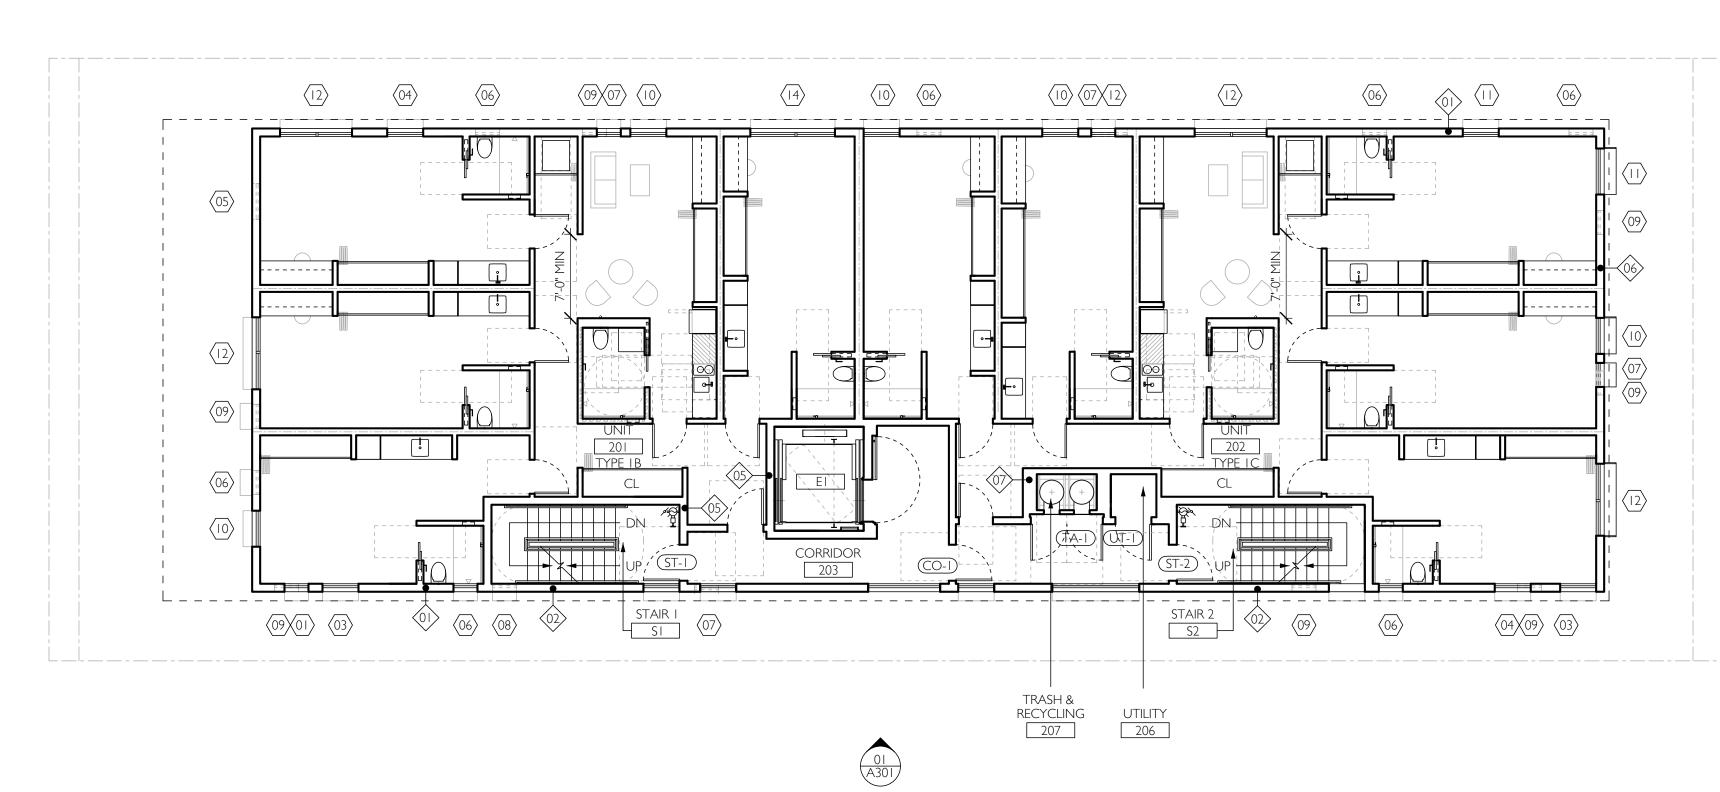

01 A303

01 A401

01 A401

01 A302

## 64NORTH 719 N. FAIRFAX AVENUE, SUITE C LOS ANGELES, CA 90046 T 310 919 0919 / F 310 933 0550 64NORTH.COM

02 / CLIENT & TEAM


## CLIENT / TRIPALINK DESIGN, INC. 2905 S VERMONT AVENUE, SUITE 202 LOS ANGELES, CALIFORNIA 90007

CIVIL ENGINEER / LFA 319 MAIN STREET EL SEGUNDO, CALIFORNIA 90245 (213) 239 9700

STRUCTURAL ENGINEER / IDG 10866 WIMER COUNTRY ROAD, LOS ANGELES, CA 91040 (323) 257-8854 OFFICE

MECHANICAL, ELECTRICAL & PLUMBING ENGINEER / MEP CALIFORNIA ENGINEERING CORP 1920 MAIN ST. SUITE 980 IRVINE, CA 92614 EXTERIOR BUILDING MAINTENANCE / LFA 319 MAIN STREET EL SEGUNDO, CALIFORNIA 90245 (213) 239 9700


SURVEYOR / THE LAND SURVEYOR 1215 W. IMPERIAL HIGHWAY, SUIT 208 BREA, CA 92821 (714) 376-7123 SAM@THELANDSURVEYOR.COM

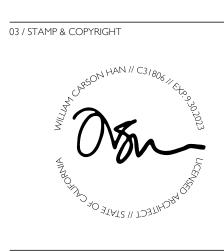

04 / KEY PLAN

01 A401

 $\bigcirc$ 

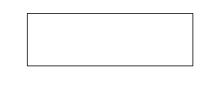

05 / PROJECT NAME & ADDRESS

## 1531-1535 S. SAWTELLE BOULEVARD LOS ANGELES, CA 90025

06 / REVISIONS

NO.	DATE	DESCRIPTION
01	12/2022	enititlements
02	12/2022	PERMIT
03	06/2023	ENITITLEMENTS REV I
04	11/2023	ENITITLEMENTS REV 2
05	01/2024	ENITITLEMENTS REV 3

07 / SHEET TITLE



08 / SHEET NUMBER






 $\begin{pmatrix} 02\\ A303 \end{pmatrix}$ 

A303



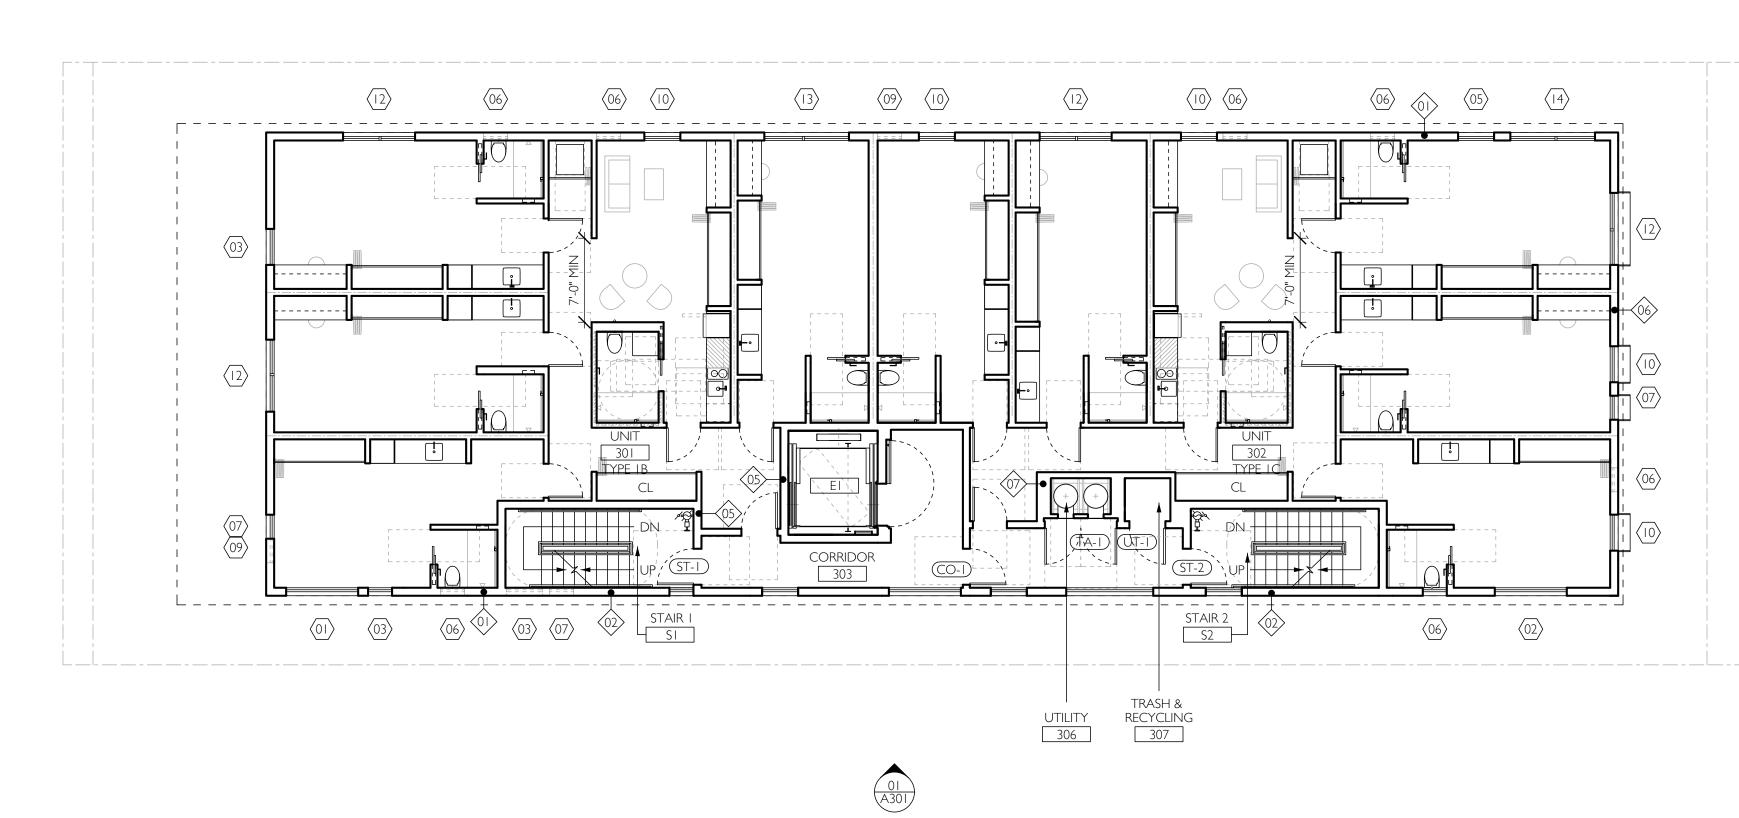

01 A302

 $\langle 12 \rangle$ 

A401

(01 (A401)

01 (A303)

## 64NORTH 719 N. FAIRFAX AVENUE, SUITE C LOS ANGELES, CA 90046 T 310 919 0919 / F 310 933 0550 64NORTH.COM

02 / CLIENT & TEAM


## CLIENT / TRIPALINK DESIGN, INC. 2905 S VERMONT AVENUE, SUITE 202 LOS ANGELES, CALIFORNIA 90007

CIVIL ENGINEER / LFA 319 MAIN STREET EL SEGUNDO, CALIFORNIA 90245 (213) 239 9700

STRUCTURAL ENGINEER / IDG 10866 WIMER COUNTRY ROAD, LOS ANGELES, CA 91040 (323) 257-8854 OFFICE


MECHANICAL, ELECTRICAL & PLUMBING ENGINEER / MEP CALIFORNIA ENGINEERING CORP 1920 MAIN ST. SUITE 980 IRVINE, CA 92614 EXTERIOR BUILDING MAINTENANCE / LFA 319 MAIN STREET EL SEGUNDO, CALIFORNIA 90245 (213) 239 9700

SURVEYOR / THE LAND SURVEYOR 1215 W. IMPERIAL HIGHWAY, SUIT 208 BREA, CA 92821 (714) 376-7123 SAM@THELANDSURVEYOR.COM

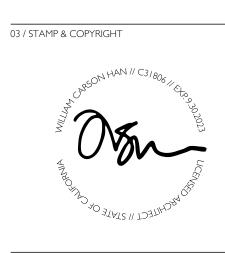

04 / KEY PLAN

 $\bigcirc$ 

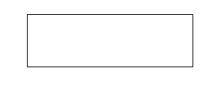

05 / PROJECT NAME & ADDRESS

## 1531-1535 S. SAWTELLE BOULEVARD LOS ANGELES, CA 90025

06 / REVISIONS

NO.	DATE	DESCRIPTION
01	12/2022	enititlements
02	12/2022	PERMIT
03	06/2023	ENITITLEMENTS REV I
04	11/2023	ENITITLEMENTS REV 2
05	01/2024	ENITITLEMENTS REV 3
-		

07 / SHEET TITLE



08 / SHEET NUMBER






(02) (A303)

 $\sim$ 



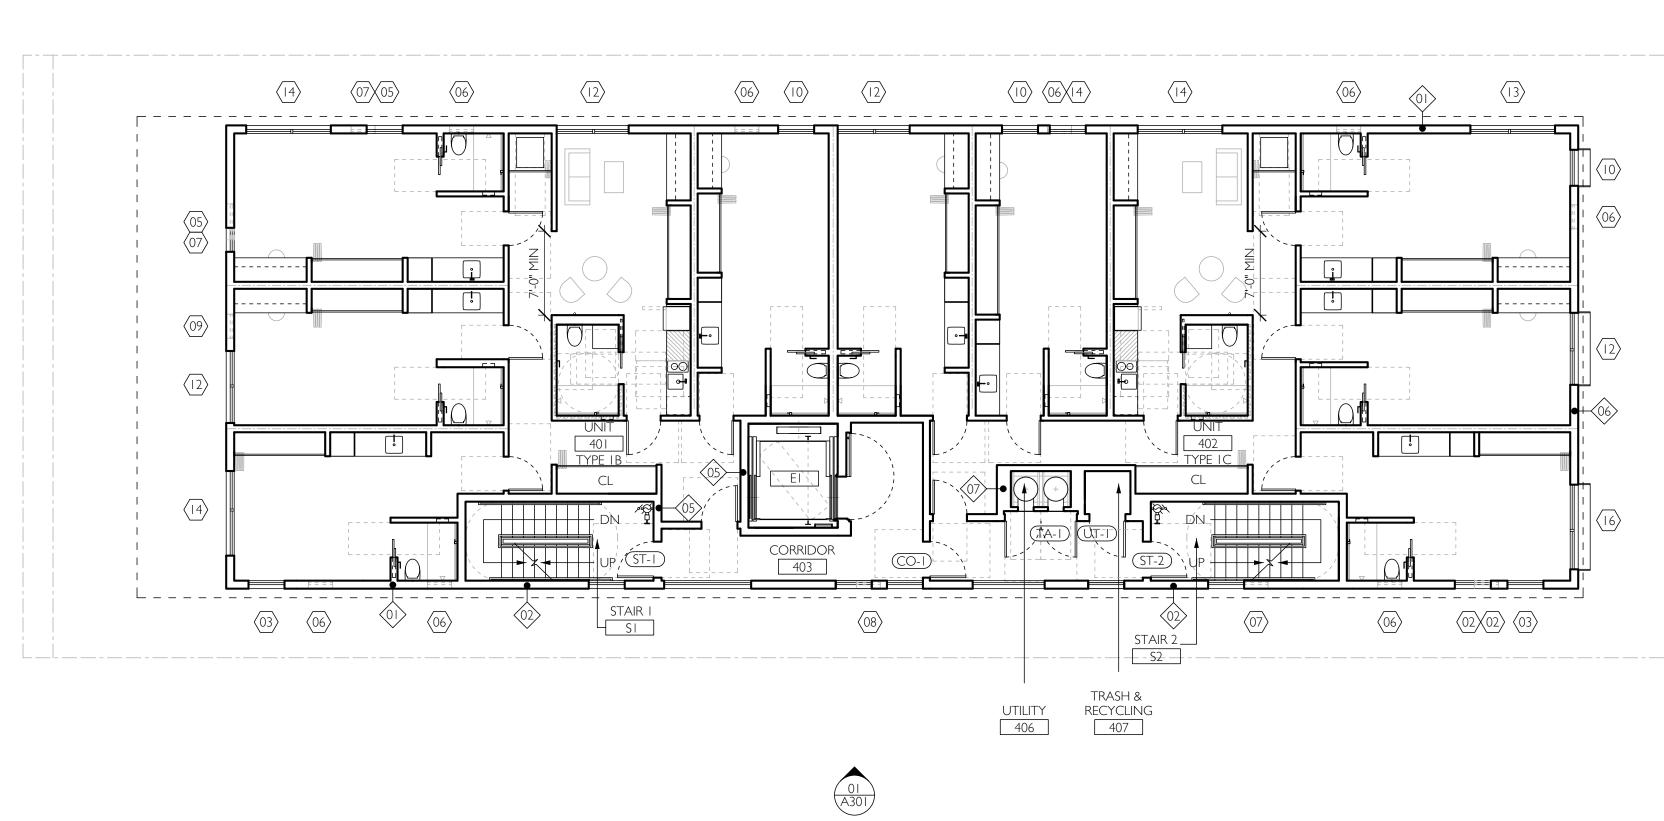

01 (A303)

01 A401

01 A401

01 A302

## 64NORTH 719 N. FAIRFAX AVENUE, SUITE C LOS ANGELES, CA 90046 T 310 919 0919 / F 310 933 0550 64NORTH.COM

02 / CLIENT & TEAM


## CLIENT / TRIPALINK DESIGN, INC. 2905 S VERMONT AVENUE, SUITE 202 LOS ANGELES, CALIFORNIA 90007

CIVIL ENGINEER / LFA 319 MAIN STREET EL SEGUNDO, CALIFORNIA 90245 (213) 239 9700

STRUCTURAL ENGINEER / IDG 10866 WIMER COUNTRY ROAD, LOS ANGELES, CA 91040 (323) 257-8854 OFFICE

MECHANICAL, ELECTRICAL & PLUMBING ENGINEER / MEP CALIFORNIA ENGINEERING CORP 1920 MAIN ST. SUITE 980 IRVINE, CA 92614 EXTERIOR BUILDING MAINTENANCE / LFA 319 MAIN STREET EL SEGUNDO, CALIFORNIA 90245 (213) 239 9700

SURVEYOR / THE LAND SURVEYOR 1215 W. IMPERIAL HIGHWAY, SUIT 208 BREA, CA 92821 (714) 376-7123 SAM@THELANDSURVEYOR.COM

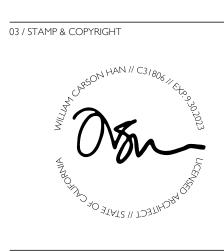

04 / KEY PLAN

 $\bigcirc$ 



05 / PROJECT NAME & ADDRESS

## 1531-1535 S. SAWTELLE BOULEVARD LOS ANGELES, CA 90025

06 / REVISIONS

NO.	DATE	DESCRIPTION
01	12/2022	ENITITLEMENTS
02	12/2022	PERMIT
03	06/2023	ENITITLEMENTS REV I
04	11/2023	ENITITLEMENTS REV 2
05	01/2024	ENITITLEMENTS REV 3


07 / SHEET TITLE



08 / SHEET NUMBER





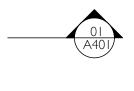








01 LEVEL 4 FLOOR PLAN SCALE 1/8" = 1'-0"



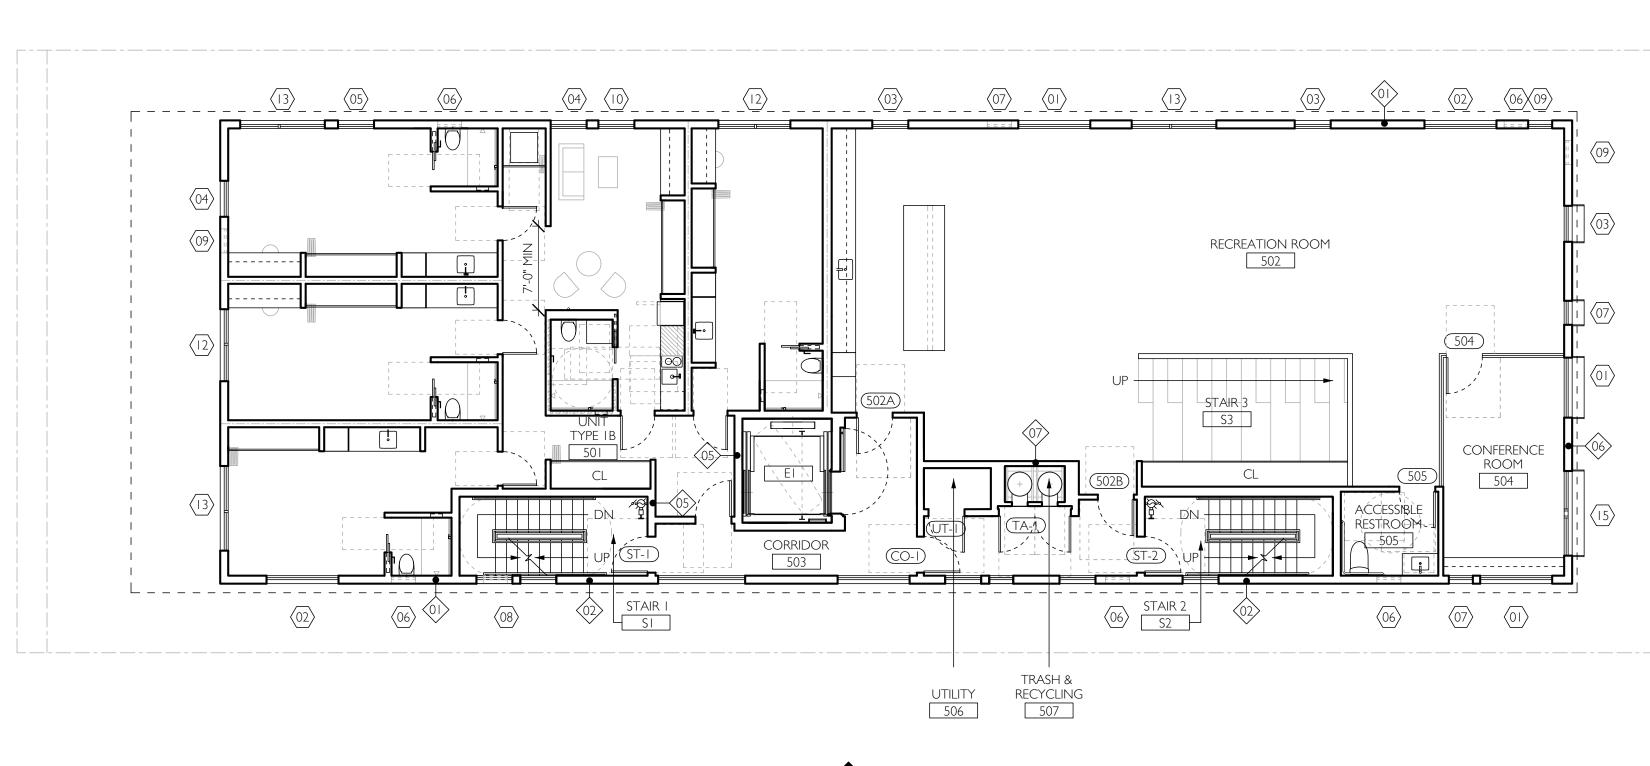

01 A303

01 A401

01 A302

01 A301

## 64NORTH 719 N. FAIRFAX AVENUE, SUITE C LOS ANGELES, CA 90046 T 310 919 0919 / F 310 933 0550 64NORTH.COM

02 / CLIENT & TEAM


## CLIENT / TRIPALINK DESIGN, INC. 2905 S VERMONT AVENUE, SUITE 202 LOS ANGELES, CALIFORNIA 90007

CIVIL ENGINEER / LFA 319 MAIN STREET EL SEGUNDO, CALIFORNIA 90245 (213) 239 9700

STRUCTURAL ENGINEER / IDG 10866 WIMER COUNTRY ROAD, LOS ANGELES, CA 91040 (323) 257-8854 OFFICE


MECHANICAL, ELECTRICAL & PLUMBING ENGINEER / MEP CALIFORNIA ENGINEERING CORP 1920 MAIN ST. SUITE 980 IRVINE, CA 92614 EXTERIOR BUILDING MAINTENANCE / LFA 319 MAIN STREET EL SEGUNDO, CALIFORNIA 90245 (213) 239 9700

SURVEYOR / THE LAND SURVEYOR 1215 W. IMPERIAL HIGHWAY, SUIT 208 BREA, CA 92821 (714) 376-7123 SAM@THELANDSURVEYOR.COM

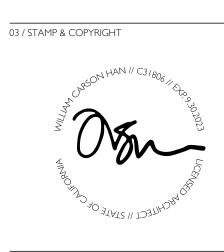

04 / KEY PLAN



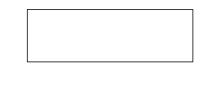

05 / PROJECT NAME & ADDRESS

## 1531-1535 S. SAWTELLE BOULEVARD LOS ANGELES, CA 90025

06 / REVISIONS

NO.	DATE	DESCRIPTION
01	12/2022	enititlements
02	12/2022	PERMIT
03	06/2023	ENITITLEMENTS REV I
04	11/2023	ENITITLEMENTS REV 2
05	01/2024	ENITITLEMENTS REV 3
-		


07 / SHEET TITLE



08 / SHEET NUMBER






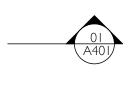







01 LEVEL 5 FLOOR PLAN SCALE 1/8" = 1'-0"

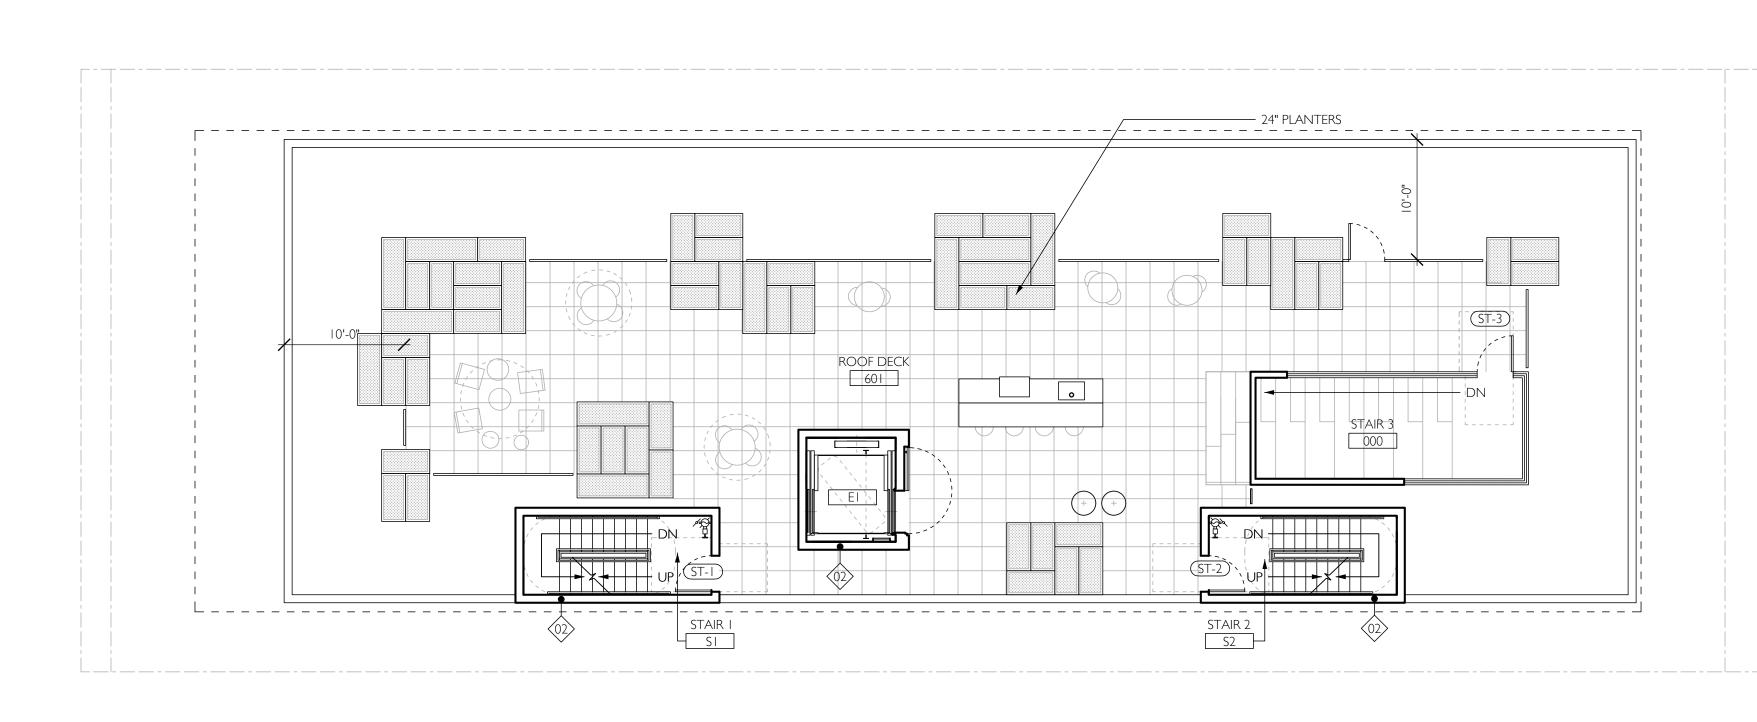

01 A302

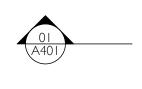

01 (A303)

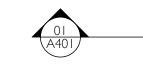

01 A301

## 64NORTH 719 N. FAIRFAX AVENUE, SUITE C LOS ANGELES, CA 90046 T 310 919 0919 / F 310 933 0550 64NORTH.COM

02 / CLIENT & TEAM

# CLIENT / TRIPALINK DESIGN, INC. 2905 S VERMONT AVENUE, SUITE 202 LOS ANGELES, CALIFORNIA 90007

CIVIL ENGINEER / LFA 319 MAIN STREET EL SEGUNDO, CALIFORNIA 90245 (213) 239 9700

STRUCTURAL ENGINEER / IDG 10866 WIMER COUNTRY ROAD, LOS ANGELES, CA 91040 (323) 257-8854 OFFICE

MECHANICAL, ELECTRICAL & PLUMBING ENGINEER / MEP CALIFORNIA ENGINEERING CORP 1920 MAIN ST. SUITE 980 IRVINE, CA 92614 EXTERIOR BUILDING MAINTENANCE / LFA 319 MAIN STREET EL SEGUNDO, CALIFORNIA 90245 (213) 239 9700

SURVEYOR / THE LAND SURVEYOR 1215 W. IMPERIAL HIGHWAY, SUIT 208 BREA, CA 92821 (714) 376-7123 SAM@THELANDSURVEYOR.COM



04 / KEY PLAN

01 A401

 $\bigcirc$ 



05 / PROJECT NAME & ADDRESS

## 1531-1535 S. SAWTELLE BOULEVARD LOS ANGELES, CA 90025

06 / REVISIONS

NO.	DATE	DESCRIPTION
01	12/2022	enititlements
02	12/2022	PERMIT
03	06/2023	ENITITLEMENTS REV I
04	11/2023	ENITITLEMENTS REV 2
05	01/2024	ENITITLEMENTS REV 3

07 / SHEET TITLE

ROOF Floor PLAN

08 / SHEET NUMBER





(02) (A303)

 $\sim$ 



#### ELEVATION FINSH LEGEND

### TAG TYPE

- \_\_\_\_ FIBER CEMENT PANELS - HARDIE BOARD VERTICAL SIDING - ARCTIC WHITE FC-1
- FIBER CEMENT PANELS HARDIE BOARD VERTICAL SIDING IRON GRAY FC-2
- MT-I PAINTED METAL WINDOW HOODS - RED / WHITE
- MT-2 ALUMINUM WINDOW MULLIONS - ANODIZED CHARCOAL
- MT-3 PAINTED METAL FENCE - ANODIZED CHARCOAL



## 64NORTH 719 N. FAIRFAX AVENUE, SUITE C LOS ANGELES, CA 90046 T 310 919 0919 / F 310 933 0550 64NORTH.COM

02 / CLIENT & TEAM

## CLIENT / TRIPALINK DESIGN, INC. 2905 S VERMONT AVENUE, SUITE 202 LOS ANGELES, CALIFORNIA 90007

CIVIL ENGINEER / LFA 319 MAIN STREET EL SEGUNDO, CALIFORNIA 90245 (213) 239 9700


STRUCTURAL ENGINEER /


IDG 10866 WIMER COUNTRY ROAD, LOS ANGELES, CA 91040 (323) 257-8854 OFFICE

MECHANICAL, ELECTRICAL & PLUMBING ENGINEER / MEP CALIFORNIA ENGINEERING CORP 1920 MAIN ST. SUITE 980 IRVINE, CA 92614 EXTERIOR BUILDING MAINTENANCE /

LFA 319 MAIN STREET EL SEGUNDO, CALIFORNIA 90245 (213) 239 9700

SURVEYOR / THE LAND SURVEYOR 1215 W. IMPERIAL HIGHWAY, SUIT 208 BREA, CA 92821 (714) 376-7123 SAM@THELANDSURVEYOR.COM

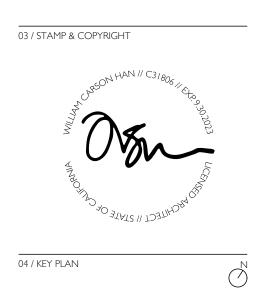

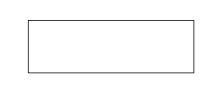

05 / PROJECT NAME & ADDRESS

1531-1535 S. SAWTELLE BOULEVARD LOS ANGELES, CA 90025

06 / REVISIONS


NO.	DATE	DESCRIPTION	
01	12/2022	enititlements	
02	12/2022	PERMIT	
03	06/2023	ENITITLEMENTS REV I	
04	11/2023	ENITITLEMENTS REV 2	
05	01/2024	ENITITLEMENTS REV 3	

07 / SHEET TITLE

# south elevations

08 / SHEET NUMBER



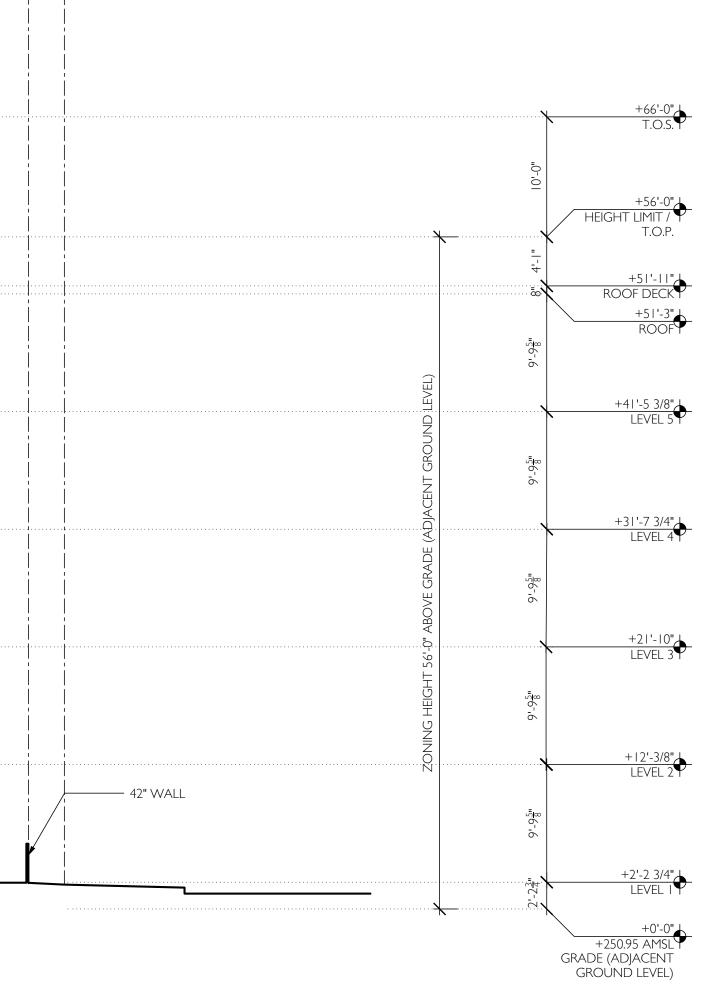


Ц

© 64NORTH ARCHITECTURE, LTD.

#### ELEVATION FINSH LEGEND

### TAG TYPE

- \_\_\_\_ FIBER CEMENT PANELS - HARDIE BOARD VERTICAL SIDING - ARCTIC WHITE FC-1
- FIBER CEMENT PANELS HARDIE BOARD VERTICAL SIDING IRON GRAY FC-2
- PAINTED METAL WINDOW HOODS RED / WHITE MT-I
- MT-2 ALUMINUM WINDOW MULLIONS - ANODIZED CHARCOAL
- MT-3 PAINTED METAL FENCE - ANODIZED CHARCOAL

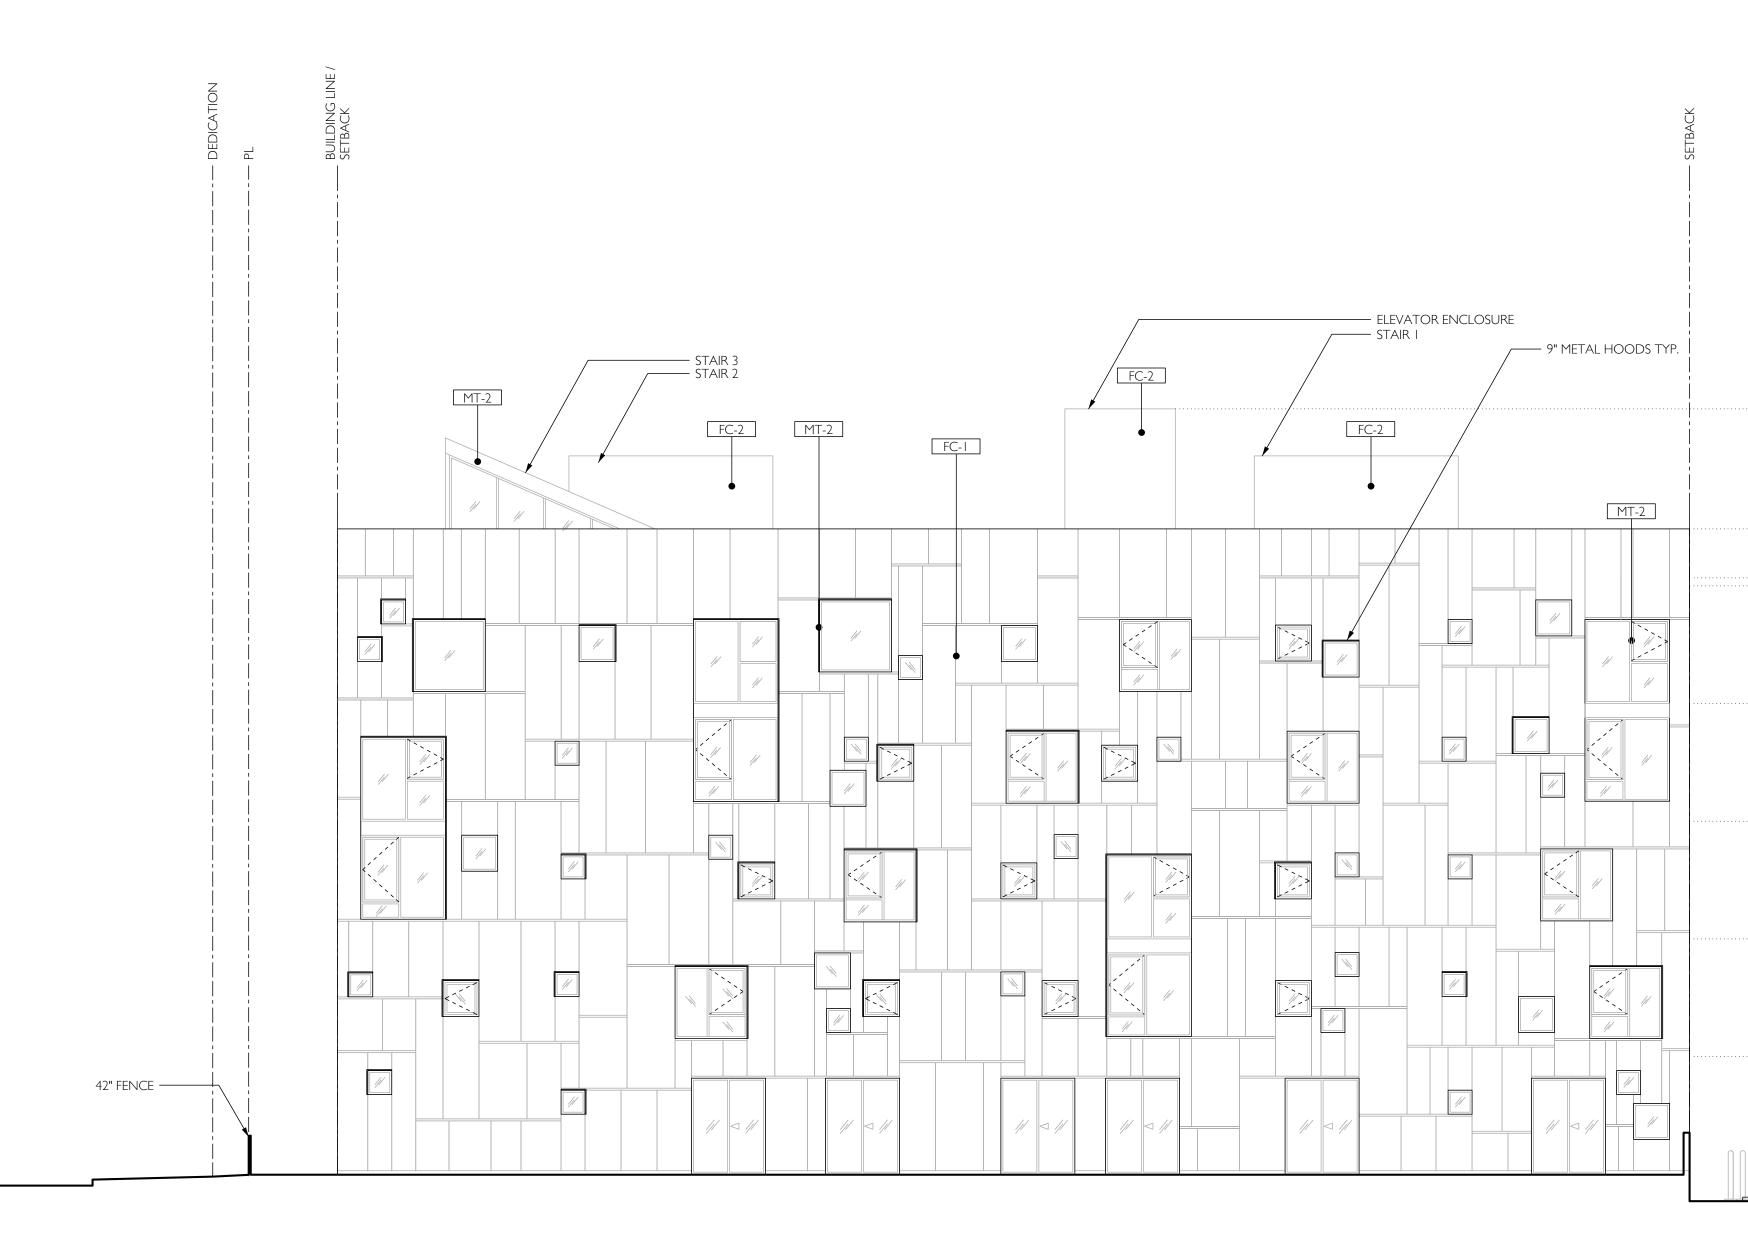



08 / SHEET NUMBER

# NORTH

07 / SHEET TITLE

NO. DATE DESCRIPTION 01 12/2022 ENITITLEMENTS 02 12/2022 PERMIT 03 06/2023 ENITITLEMENTS REV I 04 11/2023 ENITITLEMENTS REV 2 05 01/2024 ENITITLEMENTS REV 3


06 / REVISIONS

1531-1535 S. SAWTELLE BOULEVARD LOS ANGELES, CA 90025

05 / PROJECT NAME & ADDRESS

04 / KEY PLAN  $\bigcirc$ 



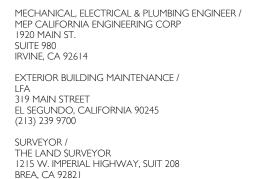

CIVIL ENGINEER / LFA 319 MAIN STREET EL SEGUNDO, CALIFORNIA 90245 (213) 239 9700

CLIENT / TRIPALINK DESIGN, INC. 2905 S VERMONT AVENUE, SUITE 202 LOS ANGELES, CALIFORNIA 90007

STRUCTURAL ENGINEER /

01 / ARCHITECT


64NORTH

02 / CLIENT & TEAM

719 N. FAIRFAX AVENUE, SUITE C LOS ANGELES, CA 90046 T 310 919 0919 / F 310 933 0550 64NORTH.COM

IDG 10866 WIMER COUNTRY ROAD, LOS ANGELES, CA 91040 (323) 257-8854 OFFICE

SURVEYOR / THE LAND SURVEYOR 1215 W. IMPERIAL HIGHWAY, SUIT 208 BREA, CA 92821 (714) 376-7123 SAM@THELANDSURVEYOR.COM

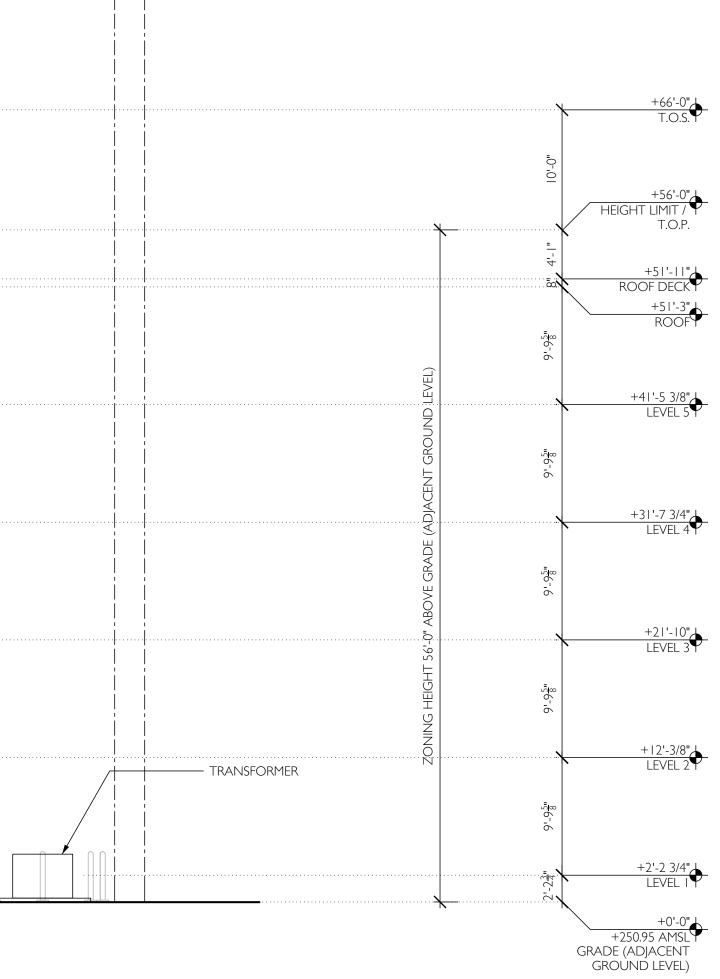


# 01 NORTH ELEVATION SCALE 1/8" = 1'-0"




EVATION FINSH LEGEND

TYPE .G

- FIBER CEMENT PANELS HARDIE BOARD VERTICAL SIDING ARCTIC WHITE
- FIBER CEMENT PANELS HARDIE BOARD VERTICAL SIDING IRON GRAY
- PAINTED METAL WINDOW HOODS RED / WHITE
- ALUMINUM WINDOW MULLIONS ANODIZED CHARCOAL
- PAINTED METAL FENCE ANODIZED CHARCOAL

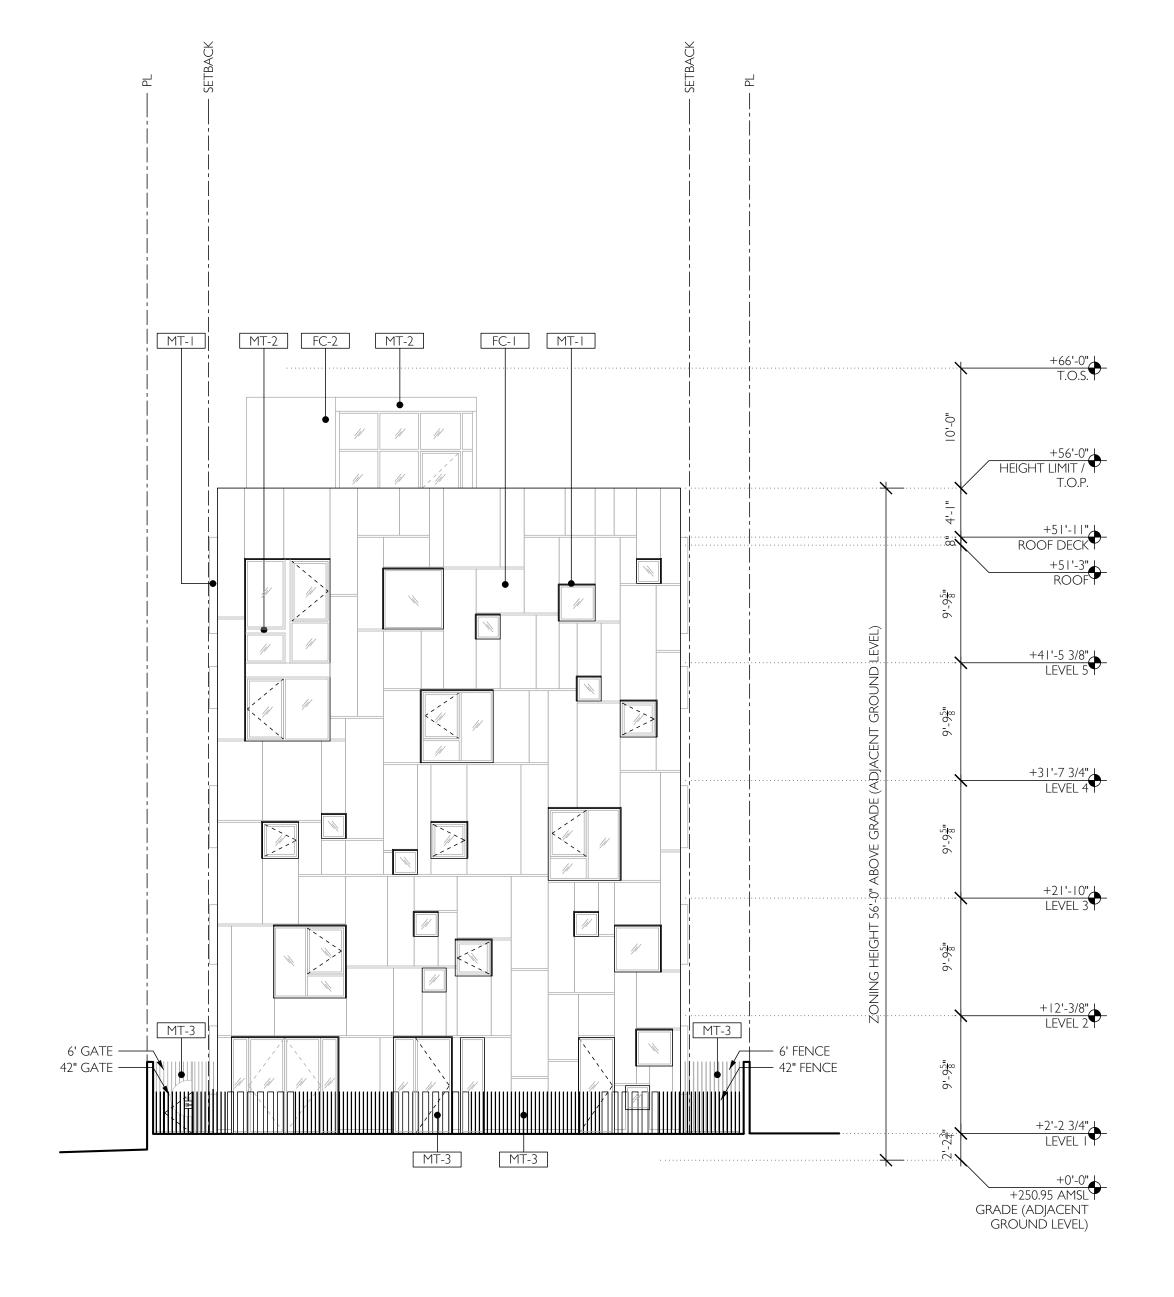

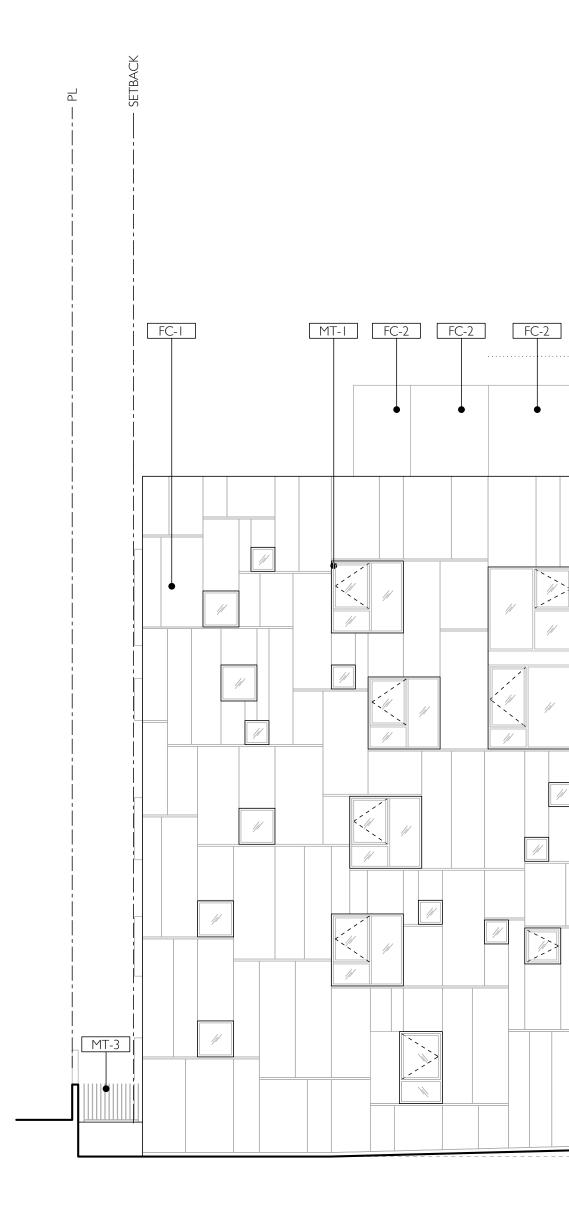

## 64NORTH 719 N. FAIRFAX AVENUE, SUITE C LOS ANGELES, CA 90046 T 310 919 0919 / F 310 933 0550 64NORTH.COM

02 / CLIENT & TEAM

## CLIENT / TRIPALINK DESIGN, INC. 2905 S VERMONT AVENUE, SUITE 202 LOS ANGELES, CALIFORNIA 90007

CIVIL ENGINEER / LFA 319 MAIN STREET EL SEGUNDO, CALIFORNIA 90245 (213) 239 9700


STRUCTURAL ENGINEER /


IDG 10866 WIMER COUNTRY ROAD, LOS ANGELES, CA 91040 (323) 257-8854 OFFICE

MECHANICAL, ELECTRICAL & PLUMBING ENGINEER / MEP CALIFORNIA ENGINEERING CORP 1920 MAIN ST. SUITE 980 IRVINE, CA 92614 EXTERIOR BUILDING MAINTENANCE /

LFA 319 MAIN STREET EL SEGUNDO, CALIFORNIA 90245 (213) 239 9700

SURVEYOR / THE LAND SURVEYOR 1215 W. IMPERIAL HIGHWAY, SUIT 208 BREA, CA 92821 (714) 376-7123 SAM@THELANDSURVEYOR.COM

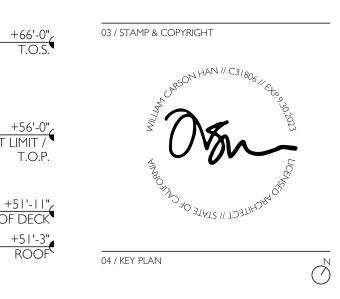

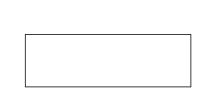

05 / PROJECT NAME & ADDRESS

1531-1535 S. SAWTELLE BOULEVARD LOS ANGELES, CA 90025

06 / F	REVISIONS	
NO.	DATE	DESCRIPTION
01	12/2022	enititlements
02	12/2022	PERMIT

NO.	DAIE	DESCRIPTION
ЭI	12/2022	enititlements
02	12/2022	PERMIT
03	06/2023	ENITITLEMENTS REV I
04	11/2023	ENITITLEMENTS REV 2
05	01/2024	ENITITLEMENTS REV 3

+250.95 AMSL GRADE (ADJACENT GROUND LEVEL)


07 / SHEET TITLE







01 WEST ELEVATION SCALE 1/8" = 1'-0"

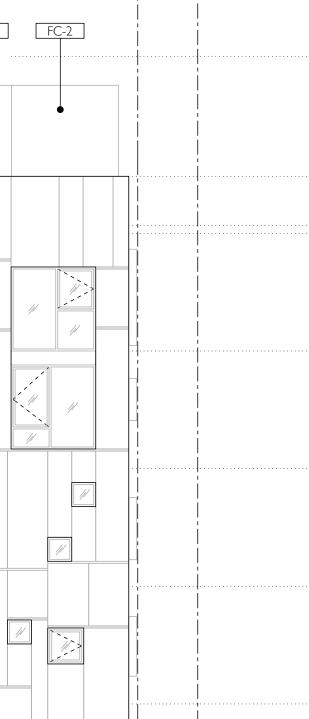

MT-3


r∦ H •

/---- 6' GATE

	"0- 10-	+56'-0"
د	<u></u>	+56'-0" HEIGHT LIMIT / T.O.P.
	8. 	
(T	99 88-1	+51'-3" ROOF
AD LEVE		+41'-5 3/8" LEVEL 5
CENT GROUN	99 895-	
√(O) ∃	<b>`</b>	+31'-7 3/4" LEVEL 4
ZONING HEIGHT 56'-0" ABOVE GRADE (ADJACENT GROUND !LEVEL)	9- -9	
56'-0"	<b>`</b>	+21'-10" LEVEL 3
NING HEIGHT	9-95 86-10	
0 N	<b>`</b>	+12'-3/8" LEVEL 2
	-9 -19	
	2'-2 <del>4</del> "	+2'-2 3/4" LEVEL I
۷۷	κ	+0'-0" +250.95 AMSL



© 64NORTH ARCHITECTURE, LTD.

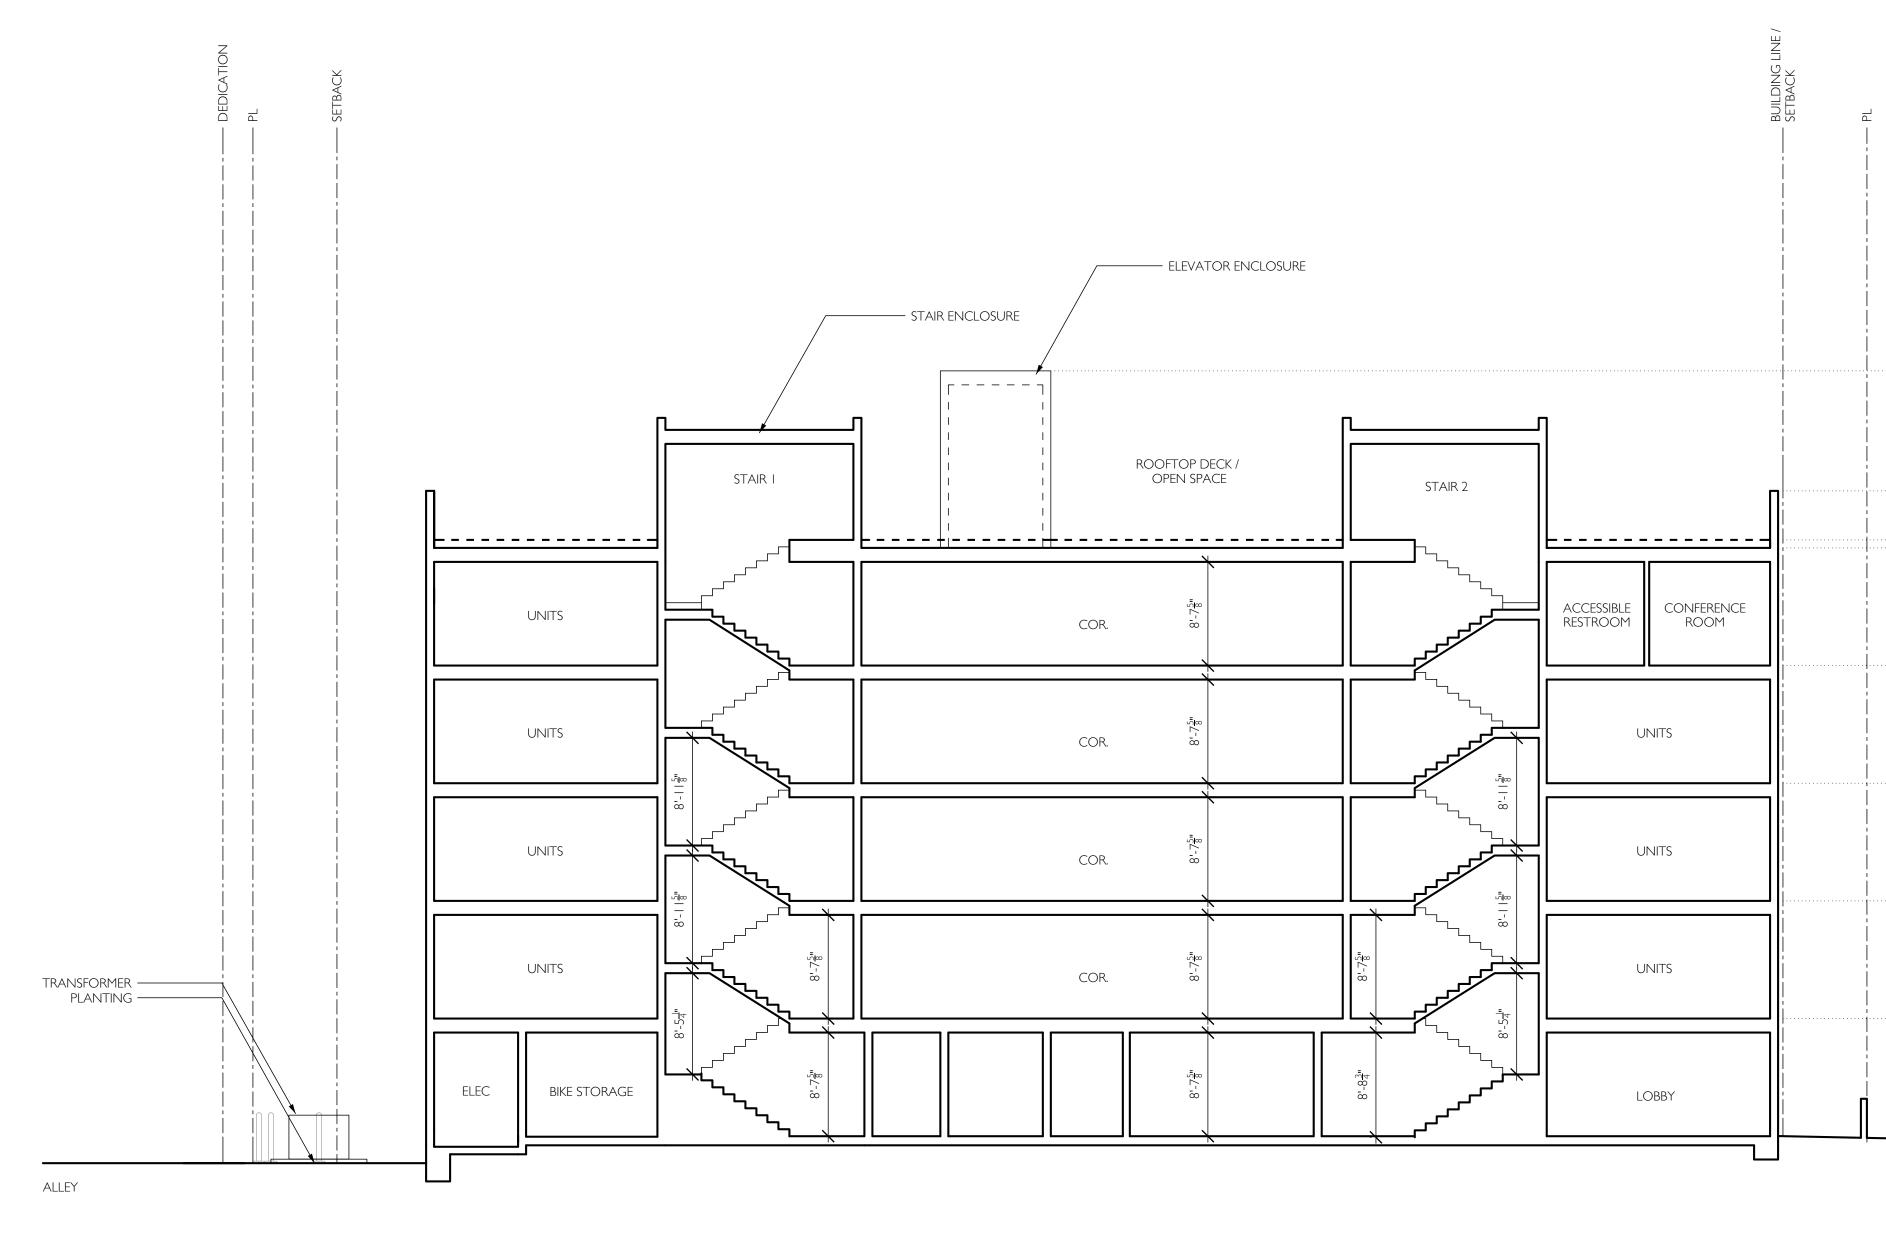

02 / CLIENT & TEAM

## CLIENT / TRIPALINK DESIGN, INC. 2905 S VERMONT AVENUE, SUITE 202 LOS ANGELES, CALIFORNIA 90007


CIVIL ENGINEER / LFA 319 MAIN STREET EL SEGUNDO, CALIFORNIA 90245 (213) 239 9700

STRUCTURAL ENGINEER / IDG IDG I0866 WIMER COUNTRY ROAD, LOS ANGELES, CA 91040 (323) 257-8854 OFFICE

MECHANICAL, ELECTRICAL & PLUMBING ENGINEER / MEP CALIFORNIA ENGINEERING CORP 1920 MAIN ST. SUITE 980 IRVINE, CA 92614 EXTERIOR BUILDING MAINTENANCE /

LFA 319 MAIN STREET EL SEGUNDO, CALIFORNIA 90245 (213) 239 9700

SURVEYOR / THE LAND SURVEYOR 1215 W. IMPERIAL HIGHWAY, SUIT 208 BREA, CA 92821 (714) 376-7123 SAM@THELANDSURVEYOR.COM

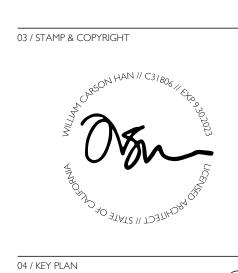

 $\bigcirc$ 



05 / PROJECT NAME & ADDRESS

## 1531-1535 S. SAWTELLE BOULEVARD LOS ANGELES, CA 90025


06 / REVISIONS


NO.	DATE	DESCRIPTION
01	12/2022	ENITITLEMENTS
02	12/2022	PERMIT
03	06/2023	ENITITLEMENTS REV I
04	11/2023	ENITITLEMENTS REV 2
05	01/2024	ENITITLEMENTS REV 3

07 / SHEET TITLE

### BUILDING sections



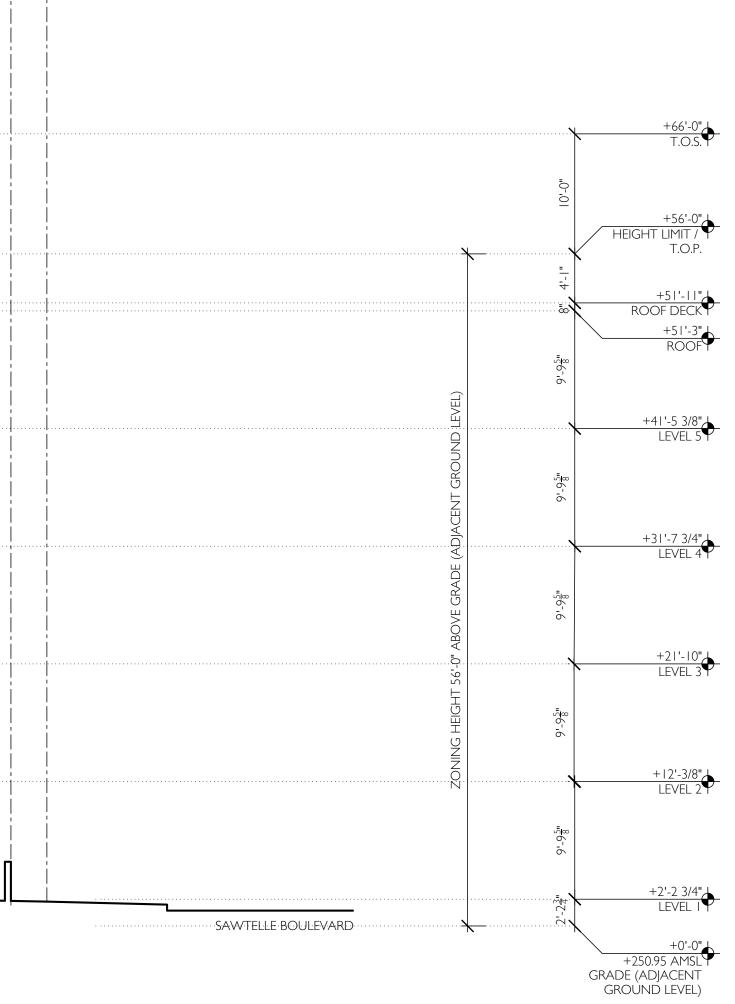

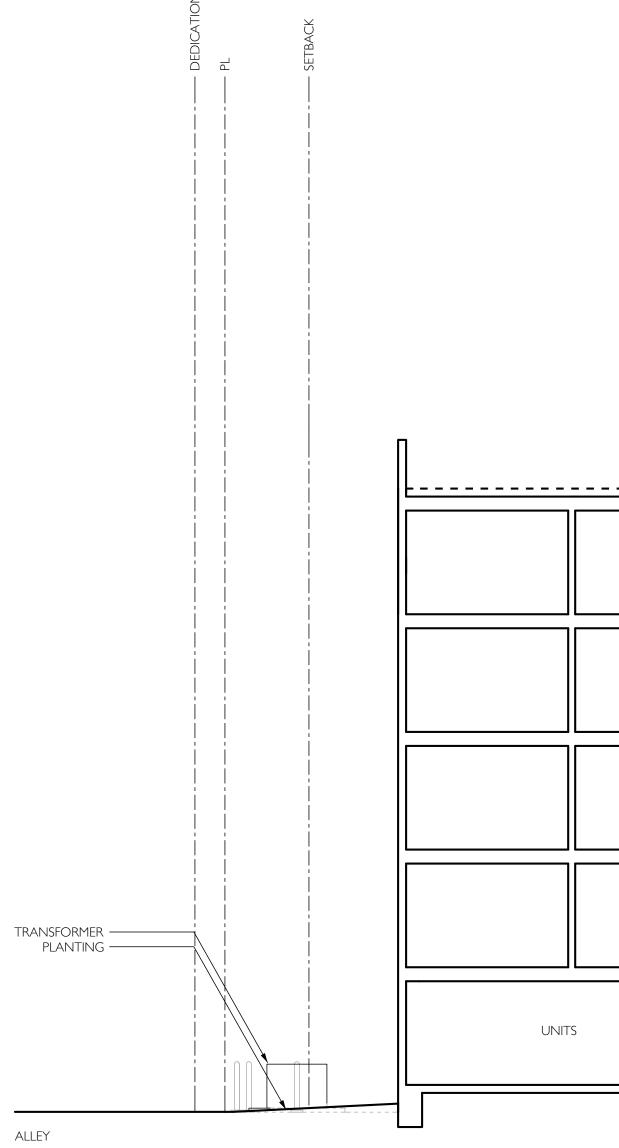

		 DFTOP DECK / DPEN SPACE	 	STAIR 3 000	
COR.	8 <sup>-75</sup>	UNITS	CREATION ROOM		CL CONFERENCE ROOM
COR.	8'-7 <u>5</u> "	UNITS		COR.	UNITS
COR.	8,-7 <sup>5</sup> "	UNITS		COR.	UNITS
COR.	8,-7 <sup>5</sup> "	UNITS		COR.	UNITS
COR.	8'-7 <u>5</u> "	UNITS		COR.	UNITS

02 / CLIENT & TEAM

## CLIENT / TRIPALINK DESIGN, INC. 2905 S VERMONT AVENUE, SUITE 202 LOS ANGELES, CALIFORNIA 90007

CIVIL ENGINEER / LFA 319 MAIN STREET EL SEGUNDO, CALIFORNIA 90245 (213) 239 9700

STRUCTURAL ENGINEER / IDG 10866 WIMER COUNTRY ROAD, LOS ANGELES, CA 91040 (323) 257-8854 OFFICE

MECHANICAL, ELECTRICAL & PLUMBING ENGINEER / MEP CALIFORNIA ENGINEERING CORP 1920 MAIN ST. SUITE 980 IRVINE, CA 92614 EXTERIOR BUILDING MAINTENANCE /

LFA 319 MAIN STREET EL SEGUNDO, CALIFORNIA 90245 (213) 239 9700

SURVEYOR / THE LAND SURVEYOR 1215 W. IMPERIAL HIGHWAY, SUIT 208 BREA, CA 92821 (714) 376-7123 SAM@THELANDSURVEYOR.COM





05 / PROJECT NAME & ADDRESS

## 1531-1535 S. SAWTELLE BOULEVARD LOS ANGELES, CA 90025

06 / REVISIONS


NO.	DATE	DESCRIPTION
01	12/2022	ENITITLEMENTS
02	12/2022	PERMIT
03	06/2023	ENITITLEMENTS REV I
04	/2023	ENITITLEMENTS REV 2
05	01/2024	ENITITLEMENTS REV 3

07 / SHEET TITLE

# BUILDING SECTIONS

08 / SHEET NUMBER




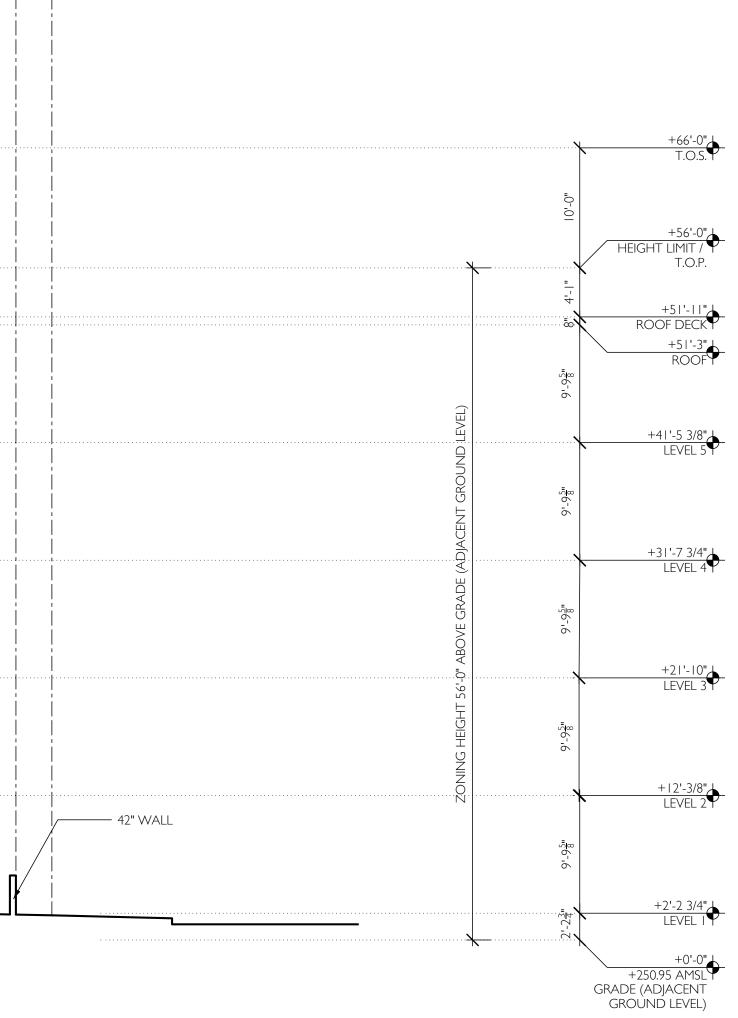

BUILDING SETBACK

Ц

01 LONGITUDINAL SECTION SCALE 1/8" = 1'-0"

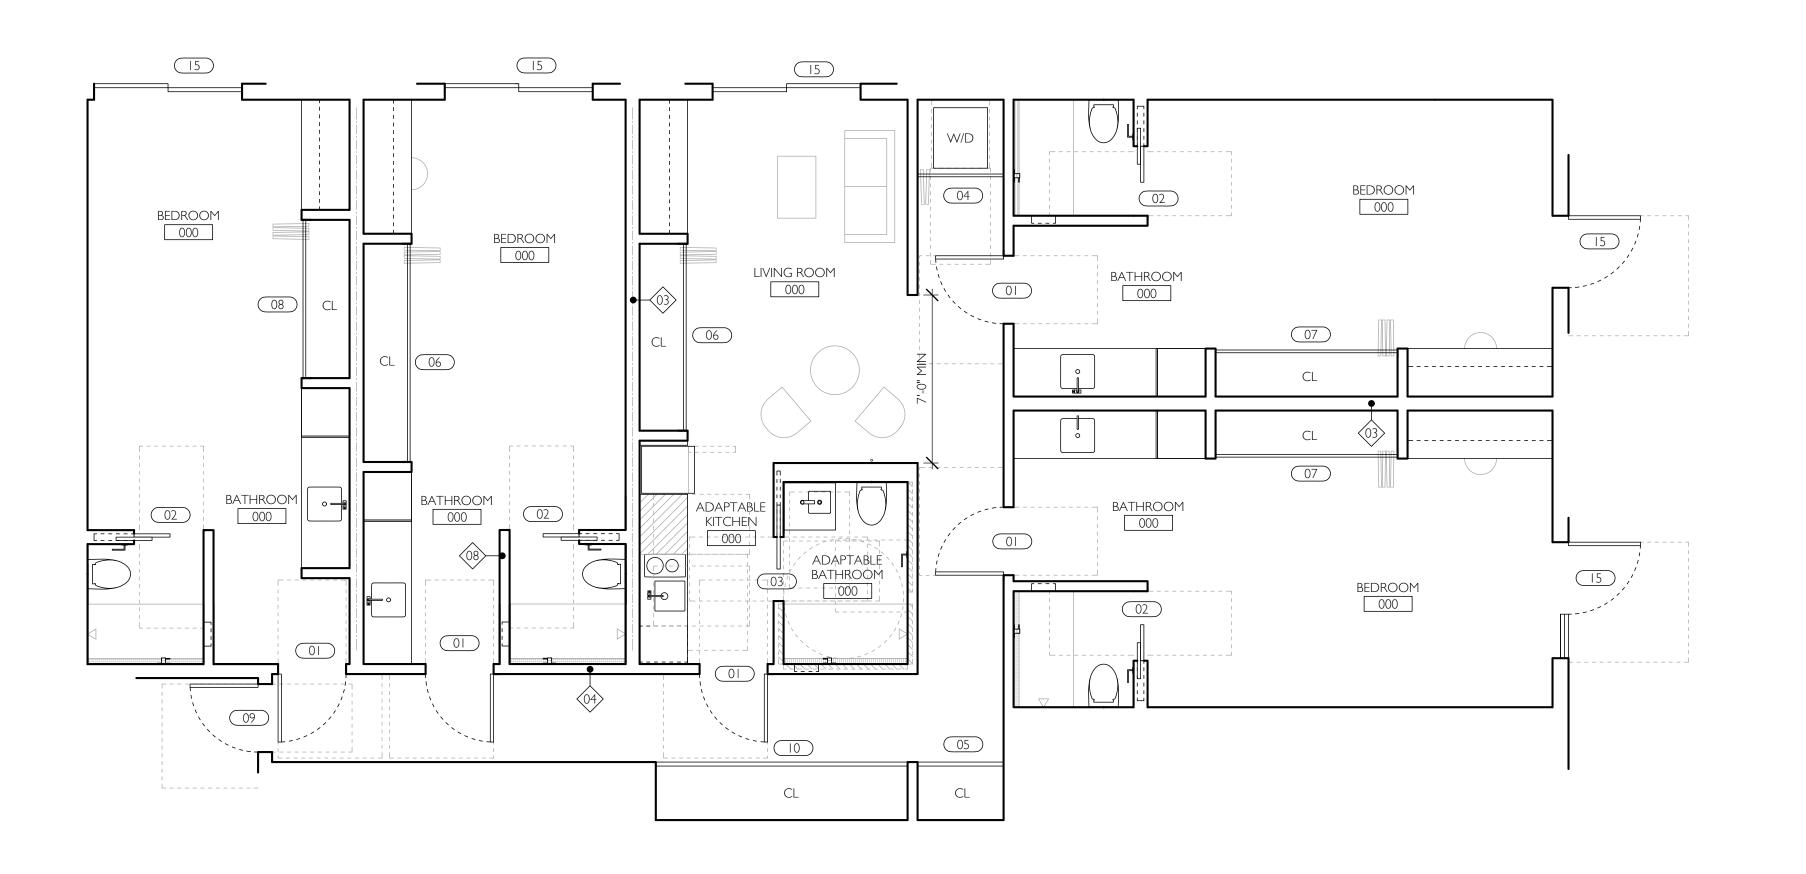

02 / CLIENT & TEAM

#### CLIENT / TRIPALINK DESIGN, INC. 2905 S VERMONT AVENUE, SUITE 202 LOS ANGELES, CALIFORNIA 90007


CIVIL ENGINEER / LFA 319 MAIN STREET EL SEGUNDO, CALIFORNIA 90245 (213) 239 9700

STRUCTURAL ENGINEER / IDG 10866 WIMER COUNTRY ROAD, LOS ANGELES, CA 91040 (323) 257-8854 OFFICE

(323) 237-8634 OFFICE MECHANICAL, ELECTRICAL & PLUMBING ENGINEER / MEP CALIFORNIA ENGINEERING CORP 1920 MAIN ST. SUITE 980 IRVINE, CA 92614 EXTERIOR BUILDING MAINTENANCE / LFA


LFA 319 MAIN STREET EL SEGUNDO, CALIFORNIA 90245 (213) 239 9700

SURVEYOR / THE LAND SURVEYOR 1215 W. IMPERIAL HIGHWAY, SUIT 208 BREA, CA 92821 (714) 376-7123 SAM@THELANDSURVEYOR.COM

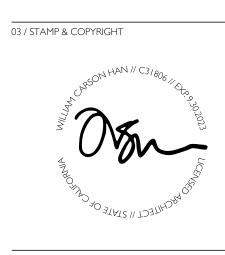

04 / KEY PLAN

 $\bigcirc$ 

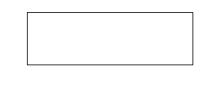

05 / PROJECT NAME & ADDRESS

### 1531-1535 S. SAWTELLE BOULEVARD LOS ANGELES, CA 90025

06 / REVISIONS

NO.	DATE	DESCRIPTION
01	12/2022	enititlements
02	12/2022	PERMIT
03	06/2023	ENITITLEMENTS REV I
04	11/2023	ENITITLEMENTS REV 2
05	01/2024	ENITITLEMENTS REV 3

07 / SHEET TITLE


UNIT PLANS


08 / SHEET NUMBER





© 64NORTH ARCHITECTURE, LTD.

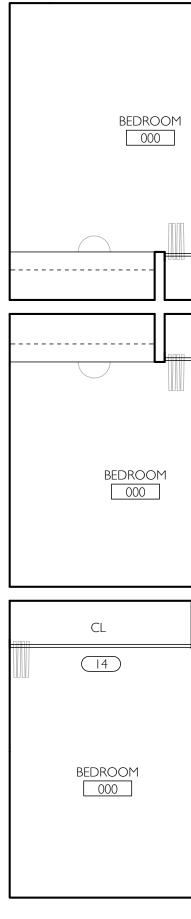

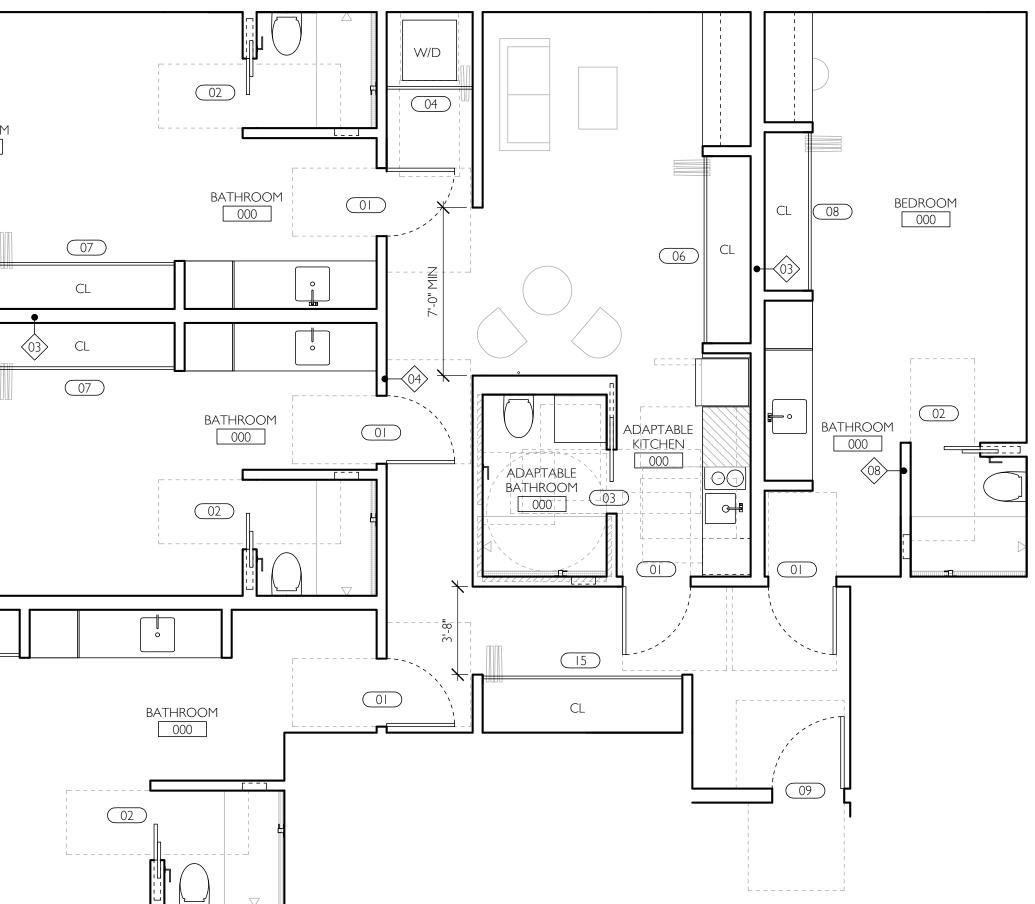

02 / CLIENT & TEAM


# CLIENT / TRIPALINK DESIGN, INC. 2905 S VERMONT AVENUE, SUITE 202 LOS ANGELES, CALIFORNIA 90007

CIVIL ENGINEER / LFA 319 MAIN STREET EL SEGUNDO, CALIFORNIA 90245 (213) 239 9700

STRUCTURAL ENGINEER / IDG IDG I0866 WIMER COUNTRY ROAD, LOS ANGELES, CA 91040 (323) 257-8854 OFFICE

MECHANICAL, ELECTRICAL & PLUMBING ENGINEER / MEP CALIFORNIA ENGINEERING CORP 1920 MAIN ST. SUITE 980 IRVINE, CA 92614 EXTERIOR BUILDING MAINTENANCE / LFA 319 MAIN STREET EL SEGUNDO, CALIFORNIA 90245 (213) 239 9700

SURVEYOR / THE LAND SURVEYOR 1215 W. IMPERIAL HIGHWAY, SUIT 208 BREA, CA 92821 (714) 376-7123 SAM@THELANDSURVEYOR.COM

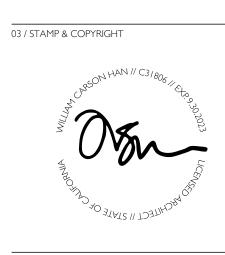

04 / KEY PLAN

 $\bigcirc$ 



05 / PROJECT NAME & ADDRESS

## 1531-1535 S. SAWTELLE BOULEVARD LOS ANGELES, CA 90025

06 / REVISIONS

 
 NO.
 DATE
 DESCRIPTION

 01
 12/2022
 ENITITLEMENTS

 02
 12/2022
 PERMIT
 03 06/2023 ENITITLEMENTS REV I 04 I I/2023 ENITITLEMENTS REV 2


05 01/2024 ENITITLEMENTS REV 3

07 / SHEET TITLE

### UNIT PLANS





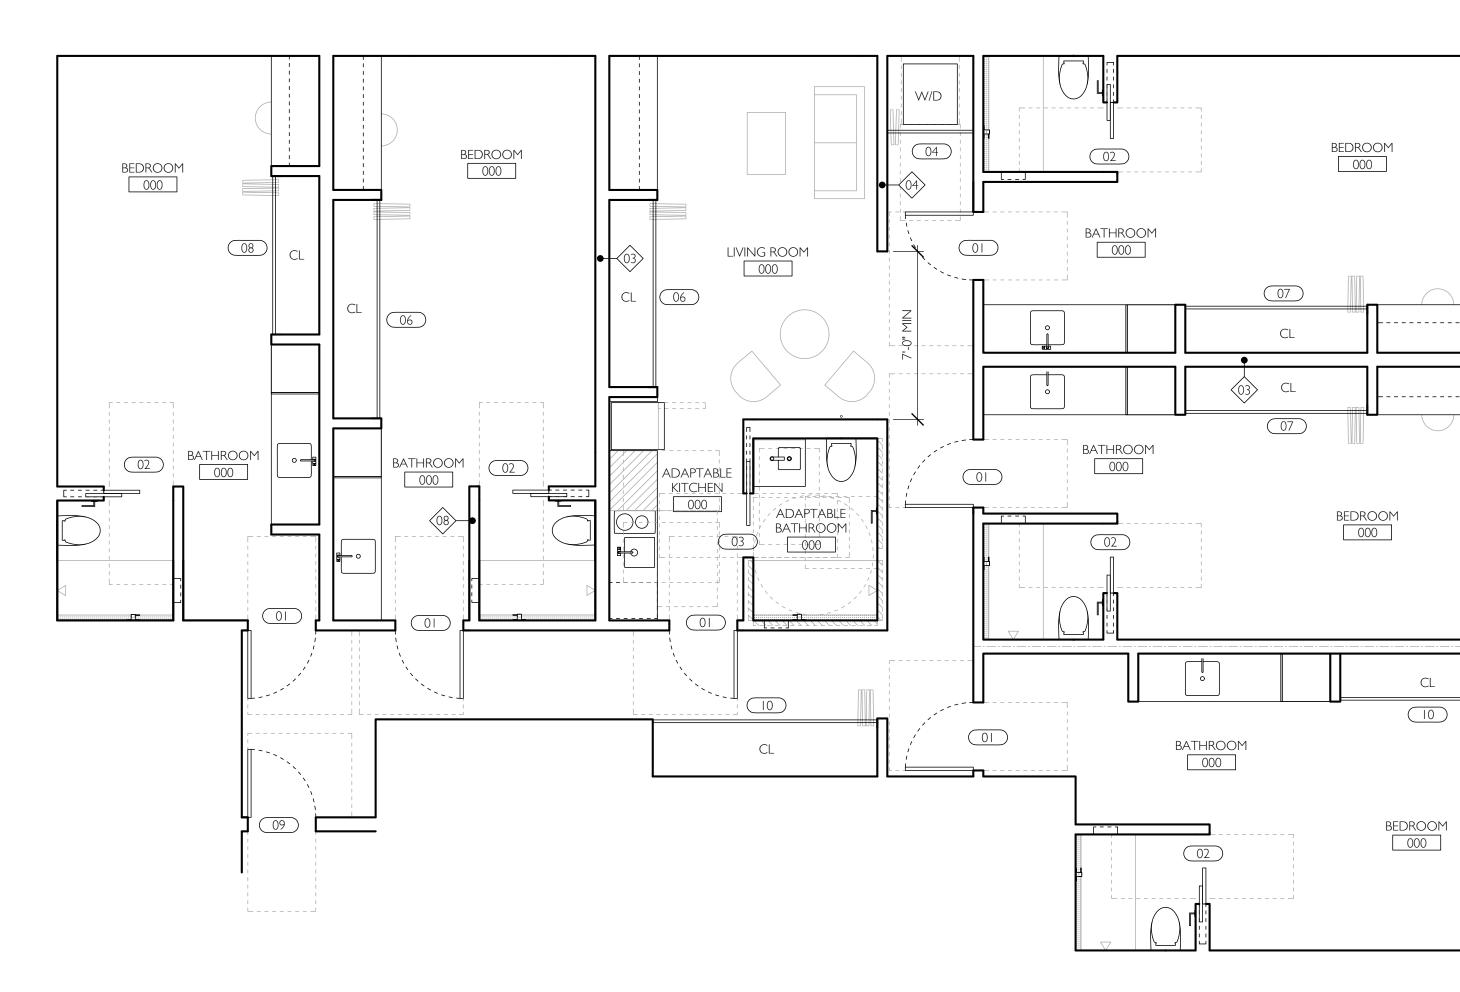

01 / ARCHITECT

#### **64.NORTH** 719 N. FAIRFAX AVENUE, SUITE C LOS ANGELES, CA 90046 T 310 919 0919 / F 310 933 0550 64NORTH.COM

02 / CLIENT & TEAM

#### CLIENT / TRIPALINK DESIGN, INC. 2905 S VERMONT AVENUE, SUITE 202 LOS ANGELES, CALIFORNIA 90007


CIVIL ENGINEER / LFA 319 MAIN STREET EL SEGUNDO, CALIFORNIA 90245 (213) 239 9700

STRUCTURAL ENGINEER / IDG 10866 WIMER COUNTRY ROAD, LOS ANGELES, CA 91040 (323) 257-8854 OFFICE

(323) 237-8634 OFFICE MECHANICAL, ELECTRICAL & PLUMBING ENGINEER / MEP CALIFORNIA ENGINEERING CORP 1920 MAIN ST. SUITE 980 IRVINE, CA 92614 EXTERIOR BUILDING MAINTENANCE / LFA

LFA 319 MAIN STREET EL SEGUNDO, CALIFORNIA 90245 (213) 239 9700

SURVEYOR / THE LAND SURVEYOR 1215 W. IMPERIAL HIGHWAY, SUIT 208 BREA, CA 92821 (714) 376-7123 SAM@THELANDSURVEYOR.COM

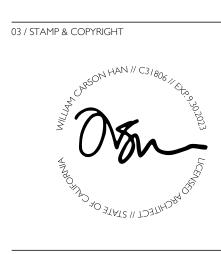

04 / KEY PLAN

 $\bigcirc$ 



05 / PROJECT NAME & ADDRESS

### 1531-1535 S. SAWTELLE BOULEVARD LOS ANGELES, CA 90025

06 / REVISIONS

DATE	DESCRIPTION
12/2022	enititlements
12/2022	PERMIT
06/2023	ENITITLEMENTS REV I
/2023	ENITITLEMENTS REV 2
01/2024	ENITITLEMENTS REV 3
	12/2022 06/2023 11/2023

07 / SHEET TITLE


UNIT PLANS

08 / SHEET NUMBER





© 64NORTH ARCHITECTURE, LTD.

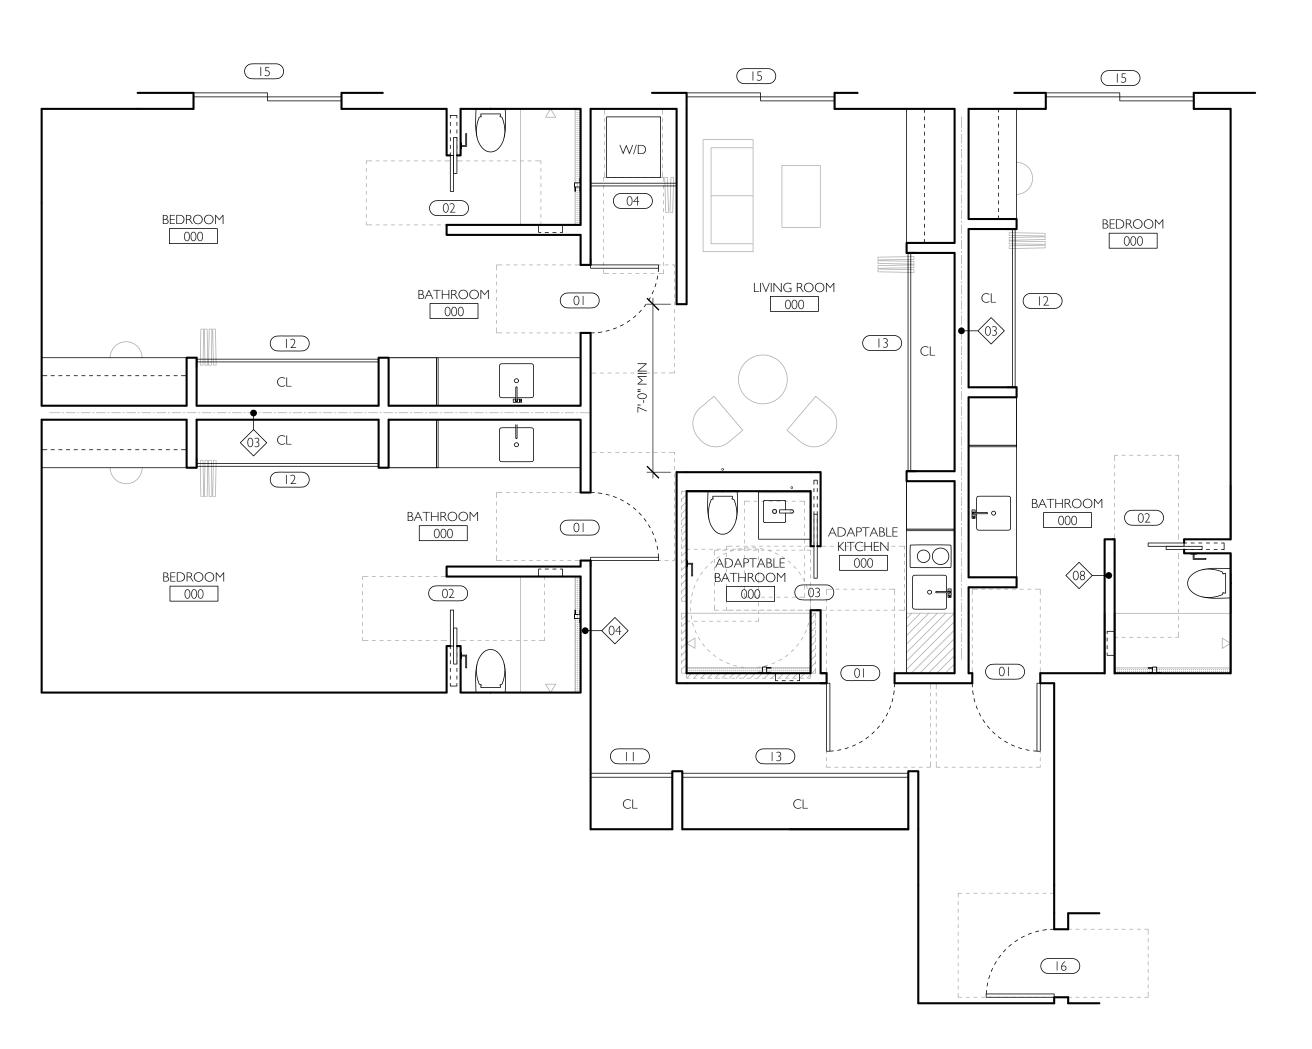

02 / CLIENT & TEAM


# CLIENT / TRIPALINK DESIGN, INC. 2905 S VERMONT AVENUE, SUITE 202 LOS ANGELES, CALIFORNIA 90007

CIVIL ENGINEER / LFA 319 MAIN STREET EL SEGUNDO, CALIFORNIA 90245 (213) 239 9700

STRUCTURAL ENGINEER / IDG IDG I0866 WIMER COUNTRY ROAD, LOS ANGELES, CA 91040 (323) 257-8854 OFFICE

MECHANICAL, ELECTRICAL & PLUMBING ENGINEER / MEP CALIFORNIA ENGINEERING CORP 1920 MAIN ST. SUITE 980 IRVINE, CA 92614 EXTERIOR BUILDING MAINTENANCE / LFA 319 MAIN STREET EL SEGUNDO, CALIFORNIA 90245 (213) 239 9700

SURVEYOR / THE LAND SURVEYOR 1215 W. IMPERIAL HIGHWAY, SUIT 208 BREA, CA 92821 (714) 376-7123 SAM@THELANDSURVEYOR.COM

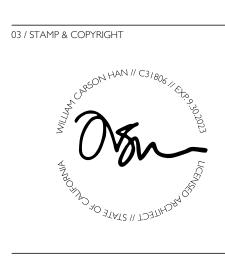

04 / KEY PLAN

 $\bigcirc$ <sup>N</sup>



05 / PROJECT NAME & ADDRESS

## 1531-1535 S. SAWTELLE BOULEVARD LOS ANGELES, CA 90025

06 / REVISIONS

NO.	DATE	DESCRIPTION
01	12/2022	ENITITLEMENTS
02	12/2022	PERMIT
03	06/2023	ENITITLEMENTS REV I
04	11/2023	ENITITLEMENTS REV 2
05	01/2024	ENITITLEMENTS REV 3

07 / SHEET TITLE

### UNIT PLANS






### GENERAL NOTES:


I. TOILET ROOM FLOORS SHALL HAVE A SMOOTH, HARD NON-ABSORBENT SURFACE SUCH AS PORTLAND CEMENT, CERAMIC TILE OR OTHER APPROVED MATERIAL THAT EXTENDS UPWARD ONTO THE WALLS AT LEAST 4"

2. WALLS AND PARTITIONS WITHIN 2 FEET OF SERVICE SINKS, URINALS, AND WATER CLOSETS SHALL HAVE A SMOOTH, HARD, NONABSORBENT SURFACE, TO A HEIGHT OF NOT LESS THAN 4 FEET ABOVE THE FLOOR, AND EXCEPT FOR STRUCTURAL ELEMENTS, THE MATERIALS USED IN SUCH WALLS SHALL BE OF A TYPE THAT IS NOT ADVERSELY AFFECTED BY MOISTURE.

3. CEMENT, FIBER-CEMENT, OR GLASS MAT GYPSUM BACKERS IN COMPLIANCE WITH ASTM CI 178, C1288 OR C1325 SHALL BE USED AS A BASE FOR WALL TILE IN TUB AND SHOWER AREAS AND WALL AND CEILING PANELS IN SHOWER AREAS. WATER-RESISTANCE GYPSUM BACKING BOARD SHALL BE USED AS A BASE FOR TILE IN WATER CLOSET COMPARTMENT WALLS WHEN INSTALLED IN ACCORDANCE WITH GA-216 OR ASTM C840. REGULAR GYPSUM WALLBOARD IS PERMITTED UNDER TILE OR WALL PANELS IN OTHER WALL AND CEILING AREAS WHEN INSTALLED IN ACCORDANCE WITH GA-216 OR ASTM C840.


4. A WET BAR WILL NOT BE CONSIDERED AS A KITCHEN PROVIDED IT HAS NO GARBAGE DISPOSAL, NO 220V ELECTRICAL, AND NO GAS OUTLET.

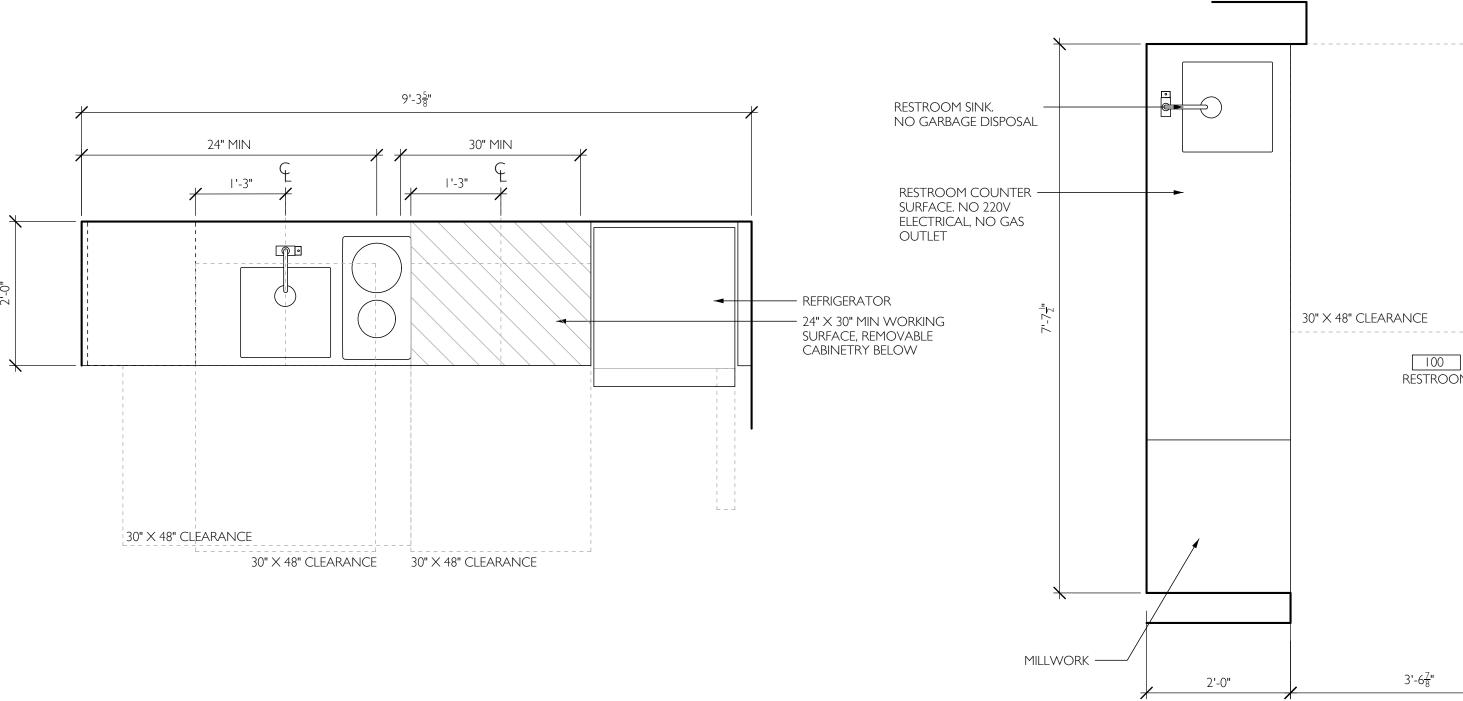

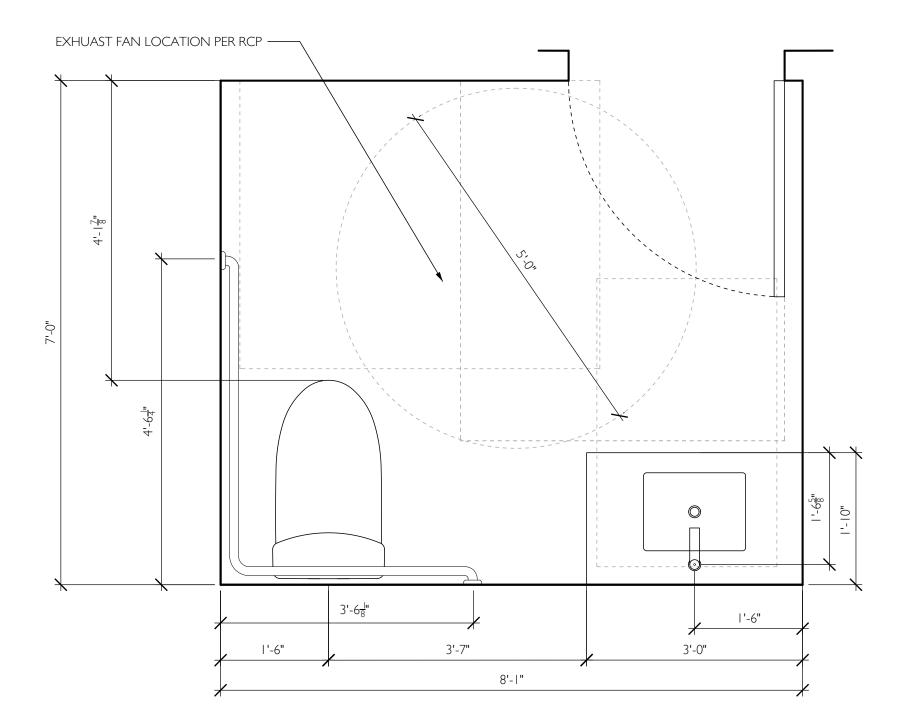

EXHUAST FAN LOCATION PER RCP —— $\sqrt{}$ 

(04) SCALE 3/4" = 1'-0"

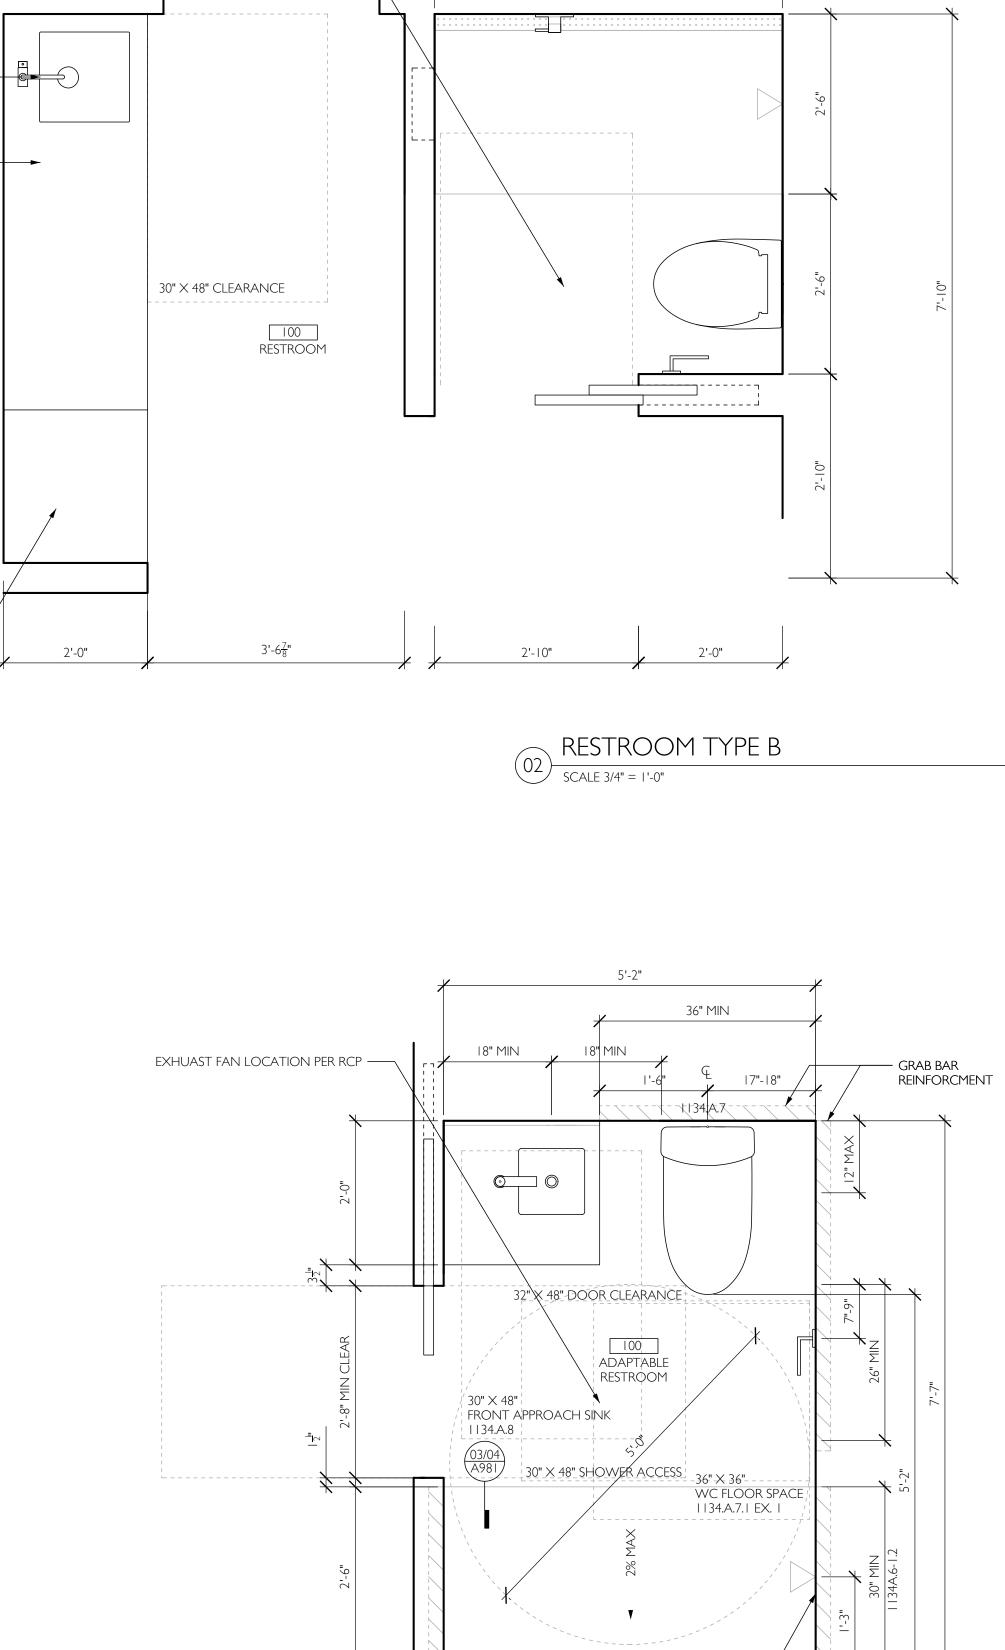

≤<u>+</u>->->**→** 

1'-5<u>-</u>"

||<u>|</u>"

4'-10"




02 / CLIENT & TEAM

CLIENT / TRIPALINK DESIGN, INC. 2905 S VERMONT AVENUE, SUITE 202 LOS ANGELES, CALIFORNIA 90007
CIVIL ENGINEER / LFA 319 MAIN STREET EL SEGUNDO, CALIFORNIA 90245 (213) 239 9700
STRUCTURAL ENGINEER / IDG 10866 WIMER COUNTRY ROAD, LOS ANGELES, CA 91040 (323) 257-8854 OFFICE
MECHANICAL, ELECTRICAL & PLUMBING ENGINEER / MEP CALIFORNIA ENGINEERING CORP 1920 MAIN ST. SUITE 980 IRVINE, CA 92614
EXTERIOR BUILDING MAINTENANCE / LFA 319 MAIN STREET EL SEGUNDO, CALIFORNIA 90245 (213) 239 9700

SURVEYOR / THE LAND SURVEYOR 1215 W. IMPERIAL HIGHWAY, SUIT 208 BREA, CA 92821 (714) 376-7123 SAMONTHELANDSU IBVEYOR COM SAM@THELANDSURVEYOR.COM





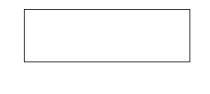

05 / PROJECT NAME & ADDRESS

## 1531-1535 S. SAWTELLE BOULEVARD LOS ANGELES, CA 90025

06 / REVISIONS

NO.	DATE	DESCRIPTION
01	12/2022	enititlements
02	12/2022	PERMIT
03	06/2023	ENITITLEMENTS REV I
04	/2023	ENITITLEMENTS REV 2
05	01/2024	ENITITLEMENTS REV 3

07 / SHEET TITLE

### ENLARGED KITCHENS & BATHROOMS

08 / SHEET NUMBER





CONTROL WALL ——

– GRAB BAR REINFORCMENT

— NICHE

60" MIN

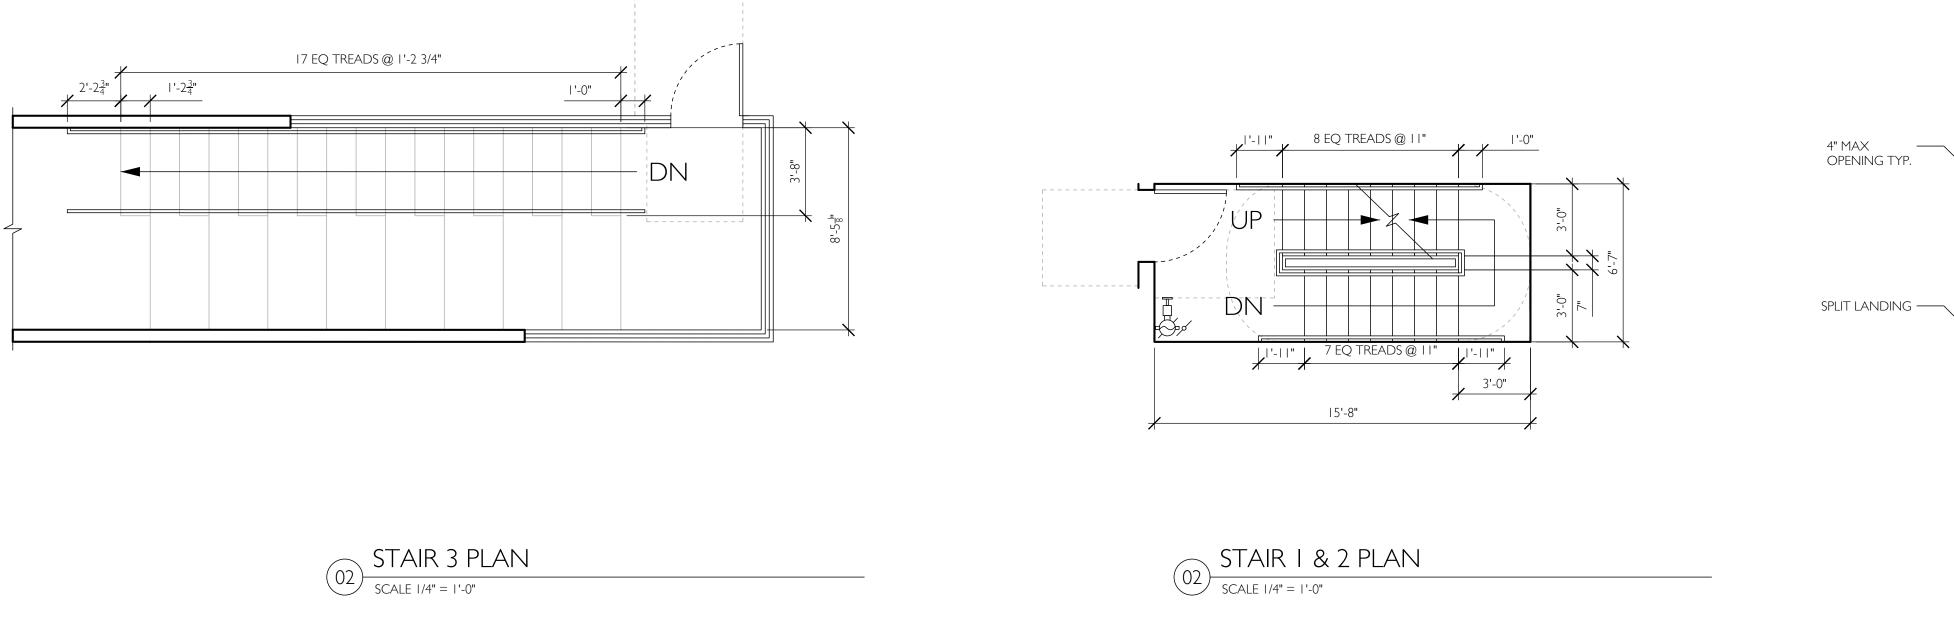

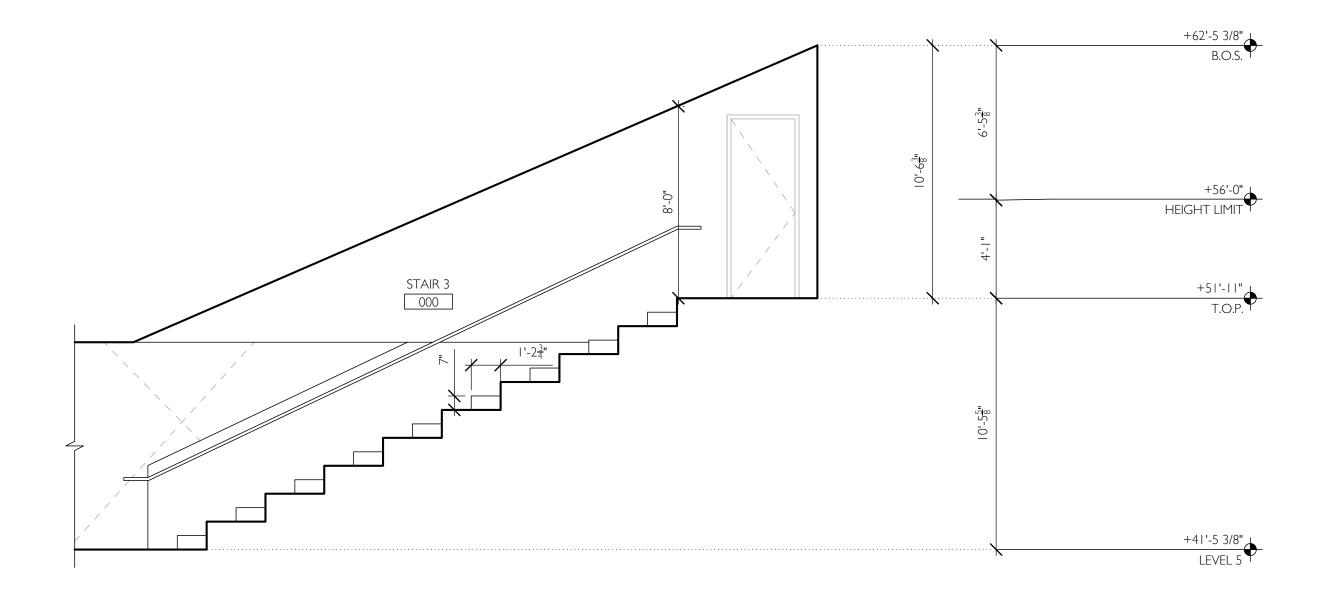





01 / ARCHITECT

## 64NORTH 719 N. FAIRFAX AVENUE, SUITE C LOS ANGELES, CA 90046 T 310 919 0919 / F 310 933 0550 64NORTH.COM

02 / CLIENT & TEAM

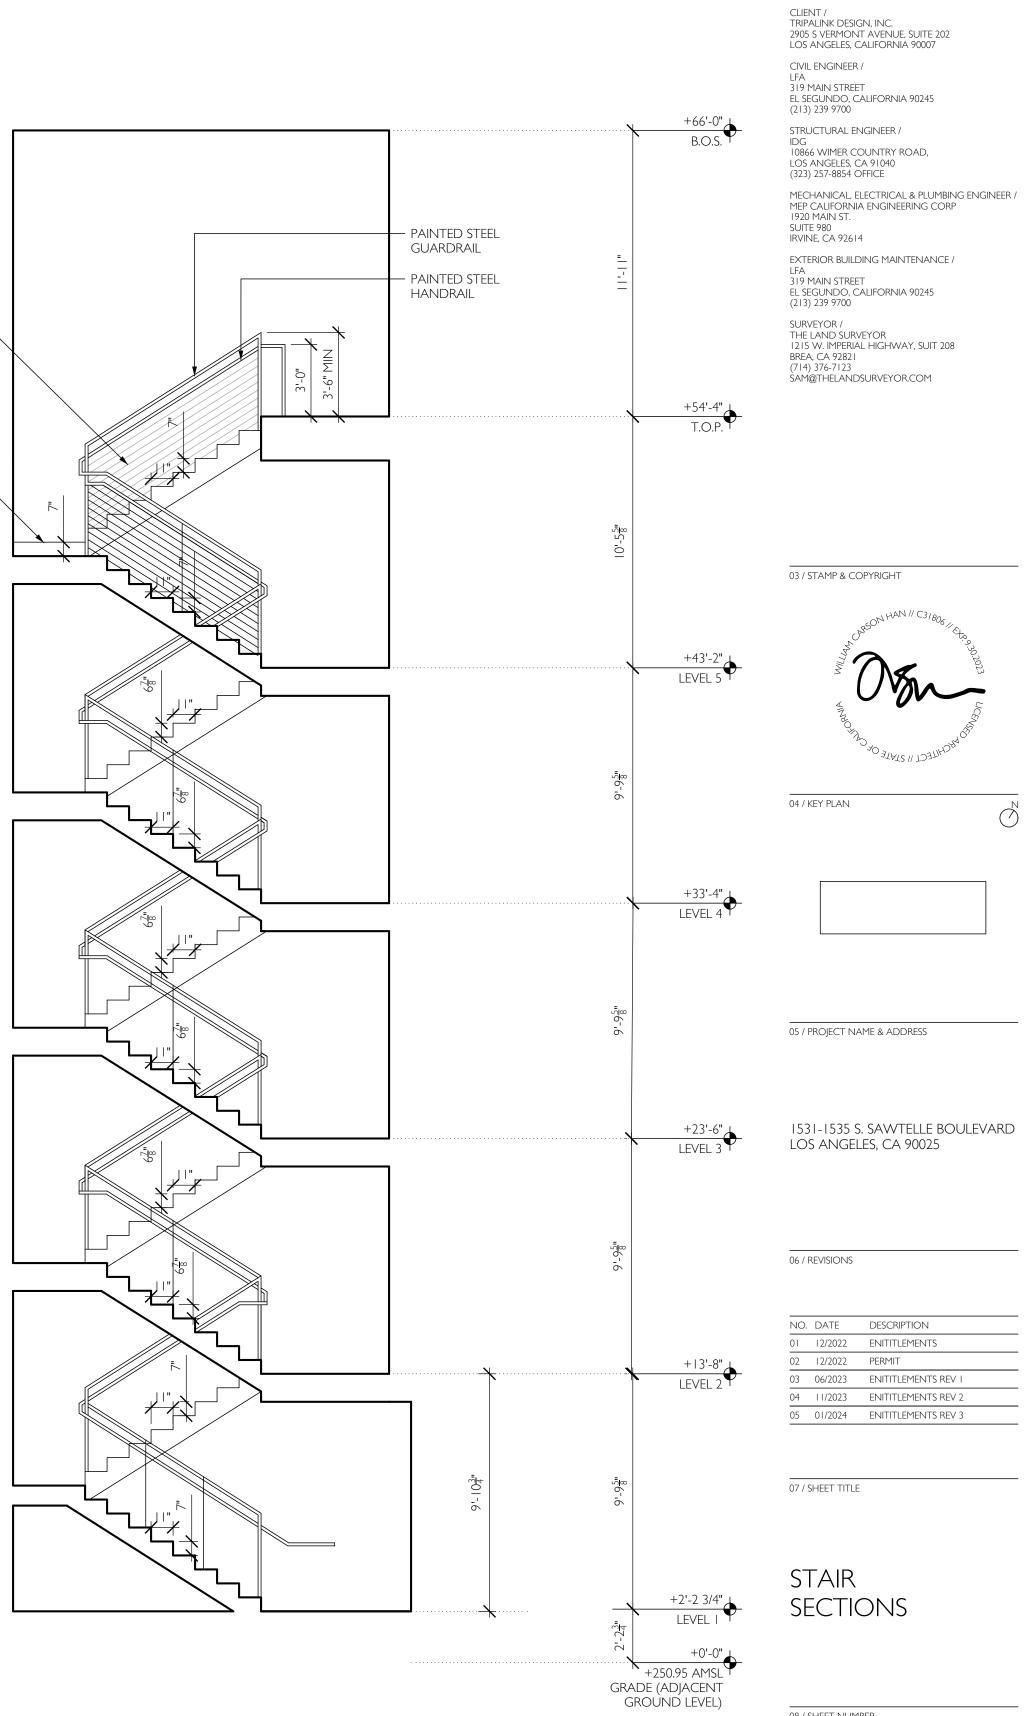



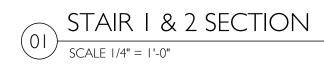

HARDSCAPE LEGEND HARDSCAPE LEGEND NOTES I. ALL QUANTITIES TO BE VERIFIED BY LANDSCAPE SUBCONTRACTOR.

SYMBOL	MATERIAL	SPECIFICATION OR APPROVED EQUAL	QUANTITY
	POURED IN PLACE CONCRETE PAVING	SAW CUT CONTROL JOINTS PER PLAN / SLOPING & WIDTH FOR ACCESSIBILITY & DRAINAGE PER PLAN, UNCOLORED CONCRETE, SMOOTH CEMENT FINISH WITH EXPOSED AGGREGATE	PER PLAN
	ROOFTOP PAVERS	TILETECH 2' X 2' X 3/4" PORCELAIN ROOFTOP PAVERS / TERRAZZO COOL GREY FINISH	PER PLAN
	GRAVEL	SEPULVEDA BUILDING MATERIALS 3/8" PEA GRAVEL	PER PLAN
	ACCESSIBLE GRAVEL	SEPULVEDA BUILDING MATERIALS 3/8" PEA GRAVEL INSTALLED WITH GRAVELPAVE 2	PER PLAN
	MULCH	SEPULVEDA BUILDING MATERIALS WOOD CHIPS BROWN	PER PLAN

SYMBOL	BOTANICAL NAME	COMMON NAME	SIZE	MATURE SIZE	WATER USE WUCOLS REGION 3 ETPF	SUNSET CLIMATE ZONE 23	SOLAR EXPOSURE	FIRE ZONE	NOTES
	CACTI								
Ð	AGAVE PARRYI V NEOMEXICANA X UTAHENSIS	ARTICHOKE AGAVE 'DEEP BLUE FORM'	5 GAL	2'-0" - 3'-0"	VERY LOW / .10	2B, 3, 6-24	FULL SUN	А	N/A
	AGAVE 'BLUE FLAME'	BLUE FLAME AGAVE	5 GAL	2'-0" - 3'-0"	LOW / .20	13, 19-24	FULL SUN OR PARTIAL SUN	А	N/A
8	PACHYCEREUS MARGINATUS	MEXICAN FENCE POST	5 GAL	0'-6"	VERY LOW / .10	12, 13, 21-24	FULL SUN	А	N/A
$\bigcirc$	ALOE POLYPHYLLA	SPIRAL ALOE	2 GAL	2'-0"	LOW / .20	8-24	FULL SUN	А	N/A
*	X MANGAVE 'MISSION TO MARS'	MISSION TO MARS MANGAVE	10 GAL	'-0" - 2'-0"	LOW / .20	9-10	FULL SUN	А	N/A
*	AGAVE VICTORIAE-REGINAE	QUEEN VICTORIA CENTURY PLANT	5 GAL	'-0" - 2'-0"	LOW / .20	10, 12, 13, 15, 16, 17, 21-24	FULL SUN OR PARTIAL SUN	A	N/A
$\bigcirc$	ECHINOCACTUS GRISONII	GOLDEN BARREL CACTUS	10 GAL	2'-0" - 3'-0"	VERY LOW / .05	12-24	FULL SUN OR PARTIAL SUN	А	N/A
$\bigcirc$	ALOE PLICATILIS	FAN ALOE	15 GAL	4'-0" - 6'-0"	LOW / .20	8, 9, 12, 12-24	FULL SUN	А	N/A
$\oplus$	KALANCHOE LUCIAE	PADDLE PLANT	15 GAL	2'-0" - 3'-0"	LOW / .20	13, 17, 21-24, H1, H2	FULL SUN OR PARTIAL SUN	A	N/A
$\mathbb{P}$	ECHEVERIA AGAVOIDES 'LIPSTICK'	LIPSTICK ECHEVARIA	15 GAL	0'-8" -  '-0"	LOW / .20	8, 9, 12-24	FULL SUN OR PARTIAL SUN	A	N/A
	TREES								
 {~}	CERCIDIUM X 'DESERT MUSEUM'	DESERT MUSEUM PALO VERDE	15 GAL	20'-0"	LOW / .20	8-14, 18-20	FULL SUN	A	N/A

PLANTING LEGEND NOTES

I. ALL QUANTITIES TO BE VERIFIED BY LANDSCAPE SUBCONTRACTOR.

01 / ARCHITECT

# **64.NORTH** 719 N. FAIRFAX AVENUE, SUITE C LOS ANGELES, CA 90046 T 310 919 0919 / F 310 933 0550 64NORTH.COM

02 / CLIENT & TEAM


## CLIENT / TRIPALINK DESIGN, INC. 2905 S VERMONT AVENUE, SUITE 202 LOS ANGELES, CALIFORNIA 90007

CIVIL ENGINEER / LFA 319 MAIN STREET EL SEGUNDO, CALIFORNIA 90245 (213) 239 9700

STRUCTURAL ENGINEER / IDG 10866 WIMER COUNTRY ROAD, LOS ANGELES, CA 91040 (323) 257-8854 OFFICE

MECHANICAL, ELECTRICAL & PLUMBING ENGINEER / MEP CALIFORNIA ENGINEERING CORP 1920 MAIN ST. SUITE 980 IRVINE, CA 92614 EXTERIOR BUILDING MAINTENANCE / LFA 319 MAIN STREET EL SEGUNDO, CALIFORNIA 90245 (213) 239 9700

SURVEYOR / THE LAND SURVEYOR 1215 W. IMPERIAL HIGHWAY, SUIT 208 BREA, CA 92821 (714) 376-7123 SAM@THELANDSURVEYOR.COM

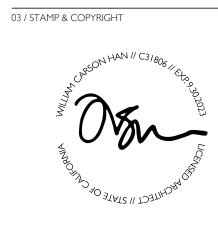

04 / KEY PLAN

 $\bigcirc$ 



05 / PROJECT NAME & ADDRESS

## 1531-1535 S. SAWTELLE BOULEVARD LOS ANGELES, CA 90025

06 / REVISIONS

NO.	DATE	DESCRIPTION
01	12/2022	ENITITLEMENTS
02	12/2022	PERMIT
03	06/2023	ENITITLEMENTS REV I
04	08/2023	ENITITLEMENTS REV 2

07 / SHEET TITLE

QUANTITY

PER PLAN PER PLAN

PER PLAN PER PLAN PER PLAN PER PLAN

PER PLAN PER PLAN

PER PLAN PER PLAN

PER PLAN

\_\_\_\_\_



08 / SHEET NUMBER

\_09 |

02 HARDSCAPE LEGEND
N.T.S.

QUANTITY NOTES

N/A

N/A

N/A

N/A

N/A



### HARDSCAPE MATERIALS













### CACTI & TREES



SEPULVEDA BUILDING MATERIALS 3/8" PEA GRAVEL







GOLDEN BARREL CACTUS ECHINOCACTUS GRISONII




AGAVE 'BLUE FLAME' BLUE FLAME AGAVE



MISSION TO MARS MANGAVE X MANGAVE 'MISSION TO MARS'



FAN ALOE ALOE PLICATILIS

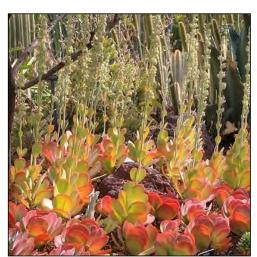

PADDLE PLANT KALANCHOE LUCIAE



DESERT MUSEUM PALO VERDE CERCIDIUM X 'DESERT MUSEUM'



PACHYCEREUS MARGINATUS



ALOE POLYPHYLLA SPIRAL ALOE



AGAVE VICTORIAE-REGINAE



ARTICHOKE AGAVE AGAVE PARRYI VAR. TRUNCATA




LIPSTICK ECHEVARIA ECHEVERIA AGAVOIDES 'LIPSTICK'

01 / ARCHITECT

## 64NORTH 719 N. FAIRFAX AVENUE, SUITE C LOS ANGELES, CA 90046 T 310 919 0919 / F 310 933 0550 64NORTH.COM


02 / CLIENT & TEAM

CLIENT / TRIPALINK DESIGN, INC. 2905 S VERMONT AVENUE, SUITE 202 LOS ANGELES, CALIFORNIA 90007 CIVIL ENGINEER / LFA 319 MAIN STREET EL SEGUNDO, CALIFORNIA 90245 (213) 239 9700 STRUCTURAL ENGINEER / IDG 10866 WIMER COUNTRY ROAD, LOS ANGELES, CA 91040 (323) 257-8854 OFFICE MECHANICAL, ELECTRICAL & PLUMBING ENGINEER / MEP CALIFORNIA ENGINEERING CORP 1920 MAIN ST. SUITE 980 IRVINE, CA 92614 EXTERIOR BUILDING MAINTENANCE / LFA 319 MAIN STREET EL SEGUNDO, CALIFORNIA 90245 (213) 239 9700 SURVEYOR / THE LAND SURVEYOR 1215 W. IMPERIAL HIGHWAY, SUIT 208 BREA, CA 92821 (714) 376-7123 SAM@THELANDSURVEYOR.COM

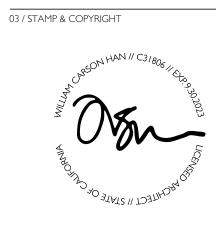

04 / KEY PLAN



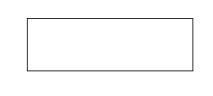

05 / PROJECT NAME & ADDRESS

## 1531-1535 S. SAWTELLE BOULEVARD LOS ANGELES, CA 90025

06 / REVISIONS


NO.	DATE	DESCRIPTION
01	12/2022	enititlements
02	12/2022	PERMIT
03	06/2023	ENITITLEMENTS REV I
04	08/2023	ENITITLEMENTS REV 2

07 / SHEET TITLE







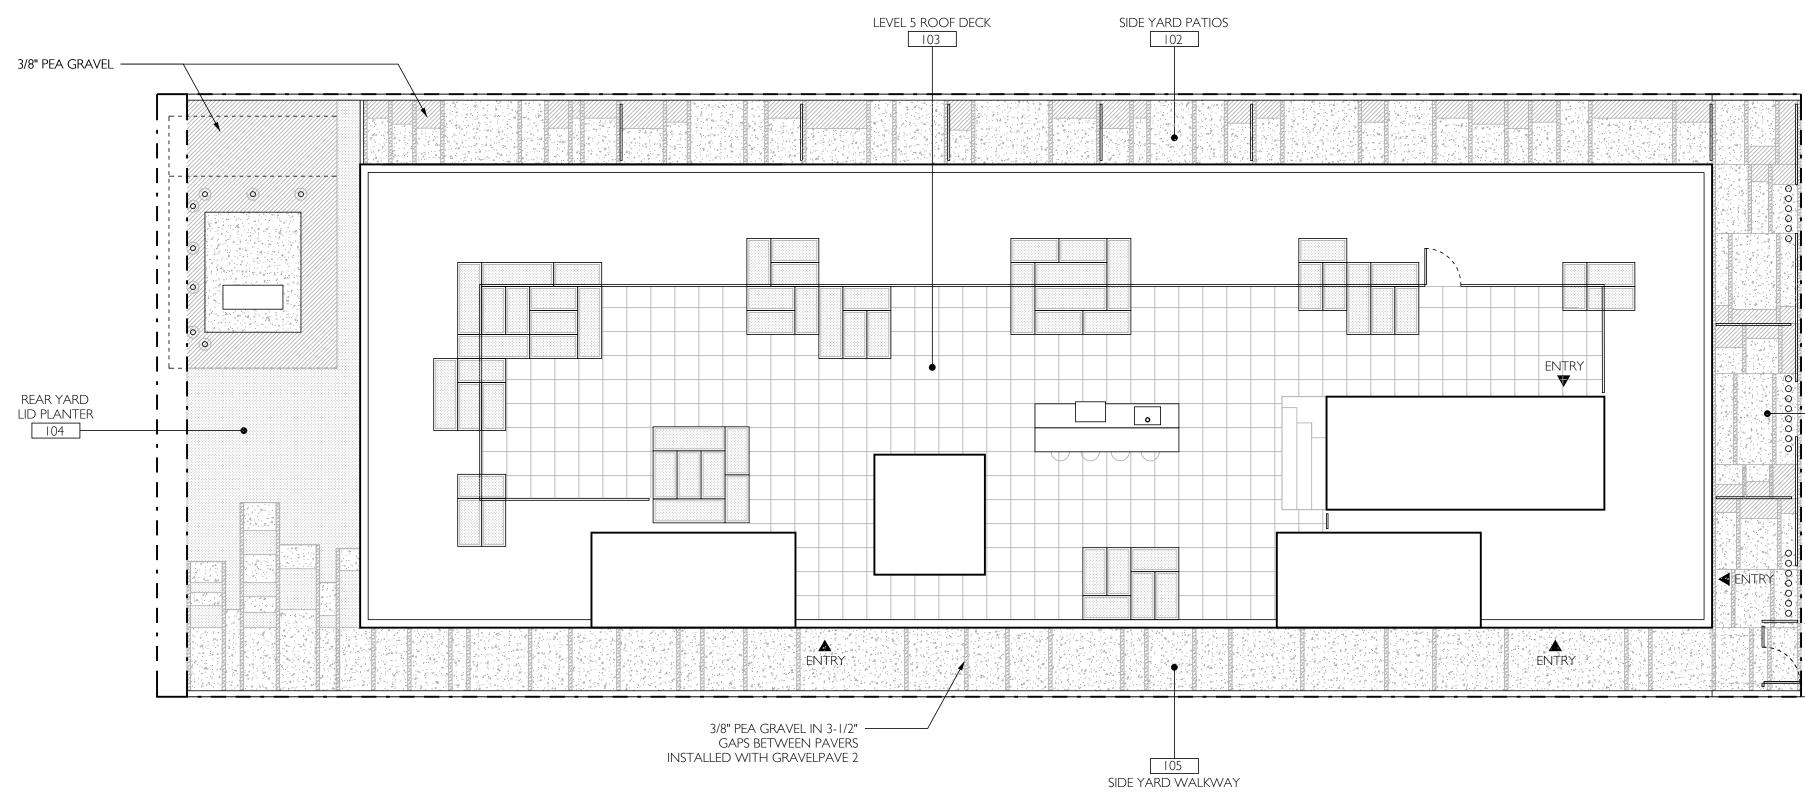

SYMBOL	MATERIAL	AREA
	UNCOLORED SMOOTH TROWELED CONCRETE WITH EXPOSED AGGREATE / SOLAR REFLECTANCE GREATER THAN 30	80 SF
	OPEN GRID OR PERMEABLE PAVING	1,723 SF
	GRAVEL	365 SF
	ACCESSIBLE GRAVEL	174 SF
	MULCH	516 SF
	TOTAL AMOUNT OF HARDSCAPE AREAS THAT COMPLY WITH 4.106.7	100%

HARDSCAPE SHADING & PERMEABILITY





08 / SHEET NUMBER



07 / SHEET TITLE

NO.	DATE	DESCRIPTION
)	12/2022	ENITITLEMENTS
)2	12/2022	PERMIT
)3	06/2023	ENITITLEMENTS REV I
)4	08/2023	ENITITLEMENTS REV 2

06 / REVISIONS

#### 1531-1535 S. SAWTELLE BOULEVARD LOS ANGELES, CA 90025

05 / PROJECT NAME & ADDRESS







03 / STAMP & COPYRIGHT

SURVEYOR / THE LAND SURVEYOR 1215 W. IMPERIAL HIGHWAY, SUIT 208 BREA, CA 92821 (714) 376-7123 SAM@THELANDSURVEYOR.COM

EXTERIOR BUILDING MAINTENANCE /

LFA 319 MAIN STREET EL SEGUNDO, CALIFORNIA 90245 (213) 239 9700

MECHANICAL, ELECTRICAL & PLUMBING ENGINEER / MEP CALIFORNIA ENGINEERING CORP 1920 MAIN ST. SUITE 980 IRVINE, CA 92614

 $\square$  $\propto$  $\triangleleft$ >Ш  $\supset$ 0 В Ш \_\_\_\_  $\geq$  $\triangleleft$ 

S

64NORTH

02 / CLIENT & TEAM

CIVIL ENGINEER /


719 N. FAIRFAX AVENUE, SUITE C LOS ANGELES, CA 90046 T 310 919 0919 / F 310 933 0550 64NORTH.COM

CLIENT / TRIPALINK DESIGN, INC. 2905 S VERMONT AVENUE, SUITE 202 LOS ANGELES, CALIFORNIA 90007

LFA 319 MAIN STREET EL SEGUNDO, CALIFORNIA 90245 (213) 239 9700

IDG 10866 WIMER COUNTRY ROAD, LOS ANGELES, CA 91040 (323) 257-8854 OFFICE

STRUCTURAL ENGINEER /

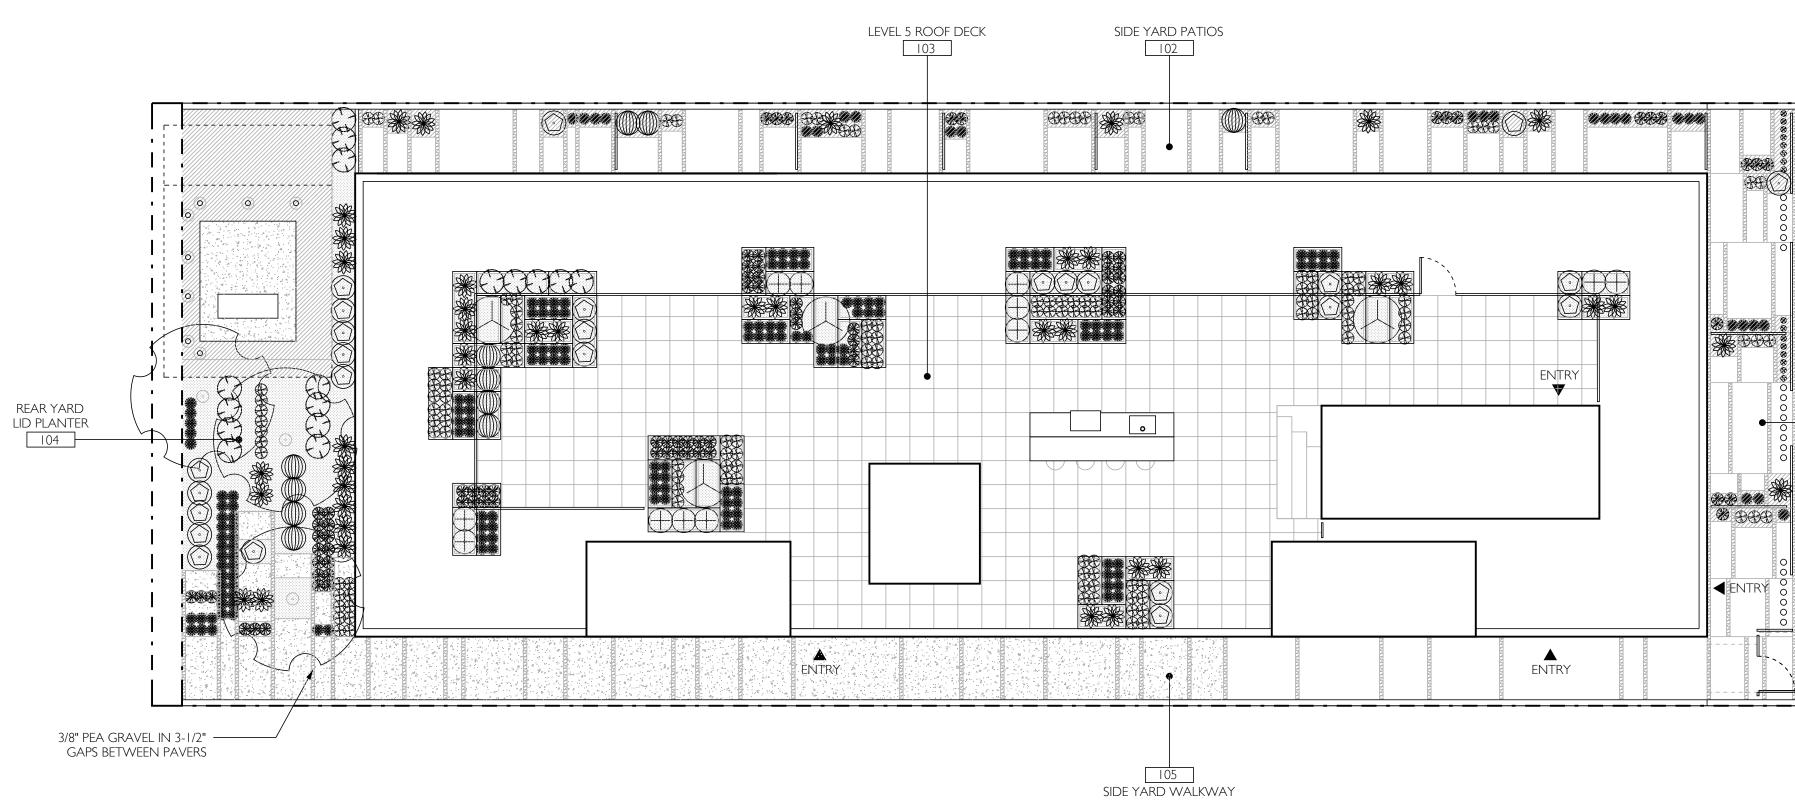

SYMBOL	BOTANICAL NAME	COMMON NAME
	SHRUBS	
$\odot$	AGAVE PARRYI V NEOMEXICANA X UTAHENSIS	ARTICHOKE AGAVE 'DEEP BLUE FORM'
**	AGAVE 'BLUE FLAME'	BLUE FLAME AGAVE
8	PACHYCEREUS MARGINATUS	MEXICAN FENCE POST
$\bigcirc$	ALOE POLYPHYLLA	SPIRAL ALOE
	X MANGAVE 'MISSION TO MARS'	MISSION TO MARS MANGAVE
** ** ©	AGAVE VICTORIAE-REGINAE	QUEEN VICTORIA CENTURY PLANT
	ECHINOCACTUS GRISONII	GOLDEN BARREL CACTUS
$\stackrel{{}}{\oplus}$	ALOE PLICATILIS	FAN ALOE
$\oplus$	KALANCHOE LUCIAE	PADDLE PLANT
$\oplus$	ECHEVERIA AGAVOIDES 'LIPSTICK'	LIPSTICK ECHEVARIA
	TREES	
$\overline{\mathbb{C}}$	CERCIDIUM X 'DESERT MUSEUM'	DESERT MUSEUM PALO VERDE

01 / ARCHITECT

## 64NORTH 719 N. FAIRFAX AVENUE, SUITE C LOS ANGELES, CA 90046 T 310 919 0919 / F 310 933 0550 64NORTH.COM

02 / CLIENT & TEAM


## CLIENT / TRIPALINK DESIGN, INC. 2905 S VERMONT AVENUE, SUITE 202 LOS ANGELES, CALIFORNIA 90007

CIVIL ENGINEER / LFA 319 MAIN STREET EL SEGUNDO, CALIFORNIA 90245 (213) 239 9700

STRUCTURAL ENGINEER / IDG IDG I0866 WIMER COUNTRY ROAD, LOS ANGELES, CA 91040 (323) 257-8854 OFFICE


MECHANICAL, ELECTRICAL & PLUMBING ENGINEER / MEP CALIFORNIA ENGINEERING CORP 1920 MAIN ST. SUITE 980 IRVINE, CA 92614 EXTERIOR BUILDING MAINTENANCE / LFA 319 MAIN STREET EL SEGUNDO, CALIFORNIA 90245 (213) 239 9700

SURVEYOR / THE LAND SURVEYOR 1215 W. IMPERIAL HIGHWAY, SUIT 208 BREA, CA 92821 (714) 376-7123 SAM@THELANDSURVEYOR.COM

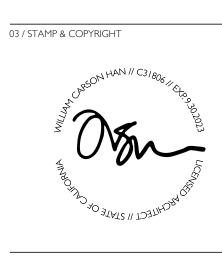

04 / KEY PLAN

 $\bigcirc$ 

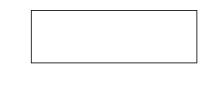

05 / PROJECT NAME & ADDRESS

## 1531-1535 S. SAWTELLE BOULEVARD LOS ANGELES, CA 90025

06 / REVISIONS

NO.	DATE	DESCRIPTION
01	12/2022	enititlements
02	12/2022	PERMIT
03	06/2023	ENITITLEMENTS REV I
04	08/2023	ENITITLEMENTS REV 2

07 / SHEET TITLE



08 / SHEET NUMBER



 $\square$  $\propto$  $\triangleleft$ >Ш  $\supset$ 0 В Ш  $\vdash$  $\geq$  $\triangleleft$ 

S


0

.

FRONT YARD PATIOS



© 64NORTH ARCHITECTURE, LTD.

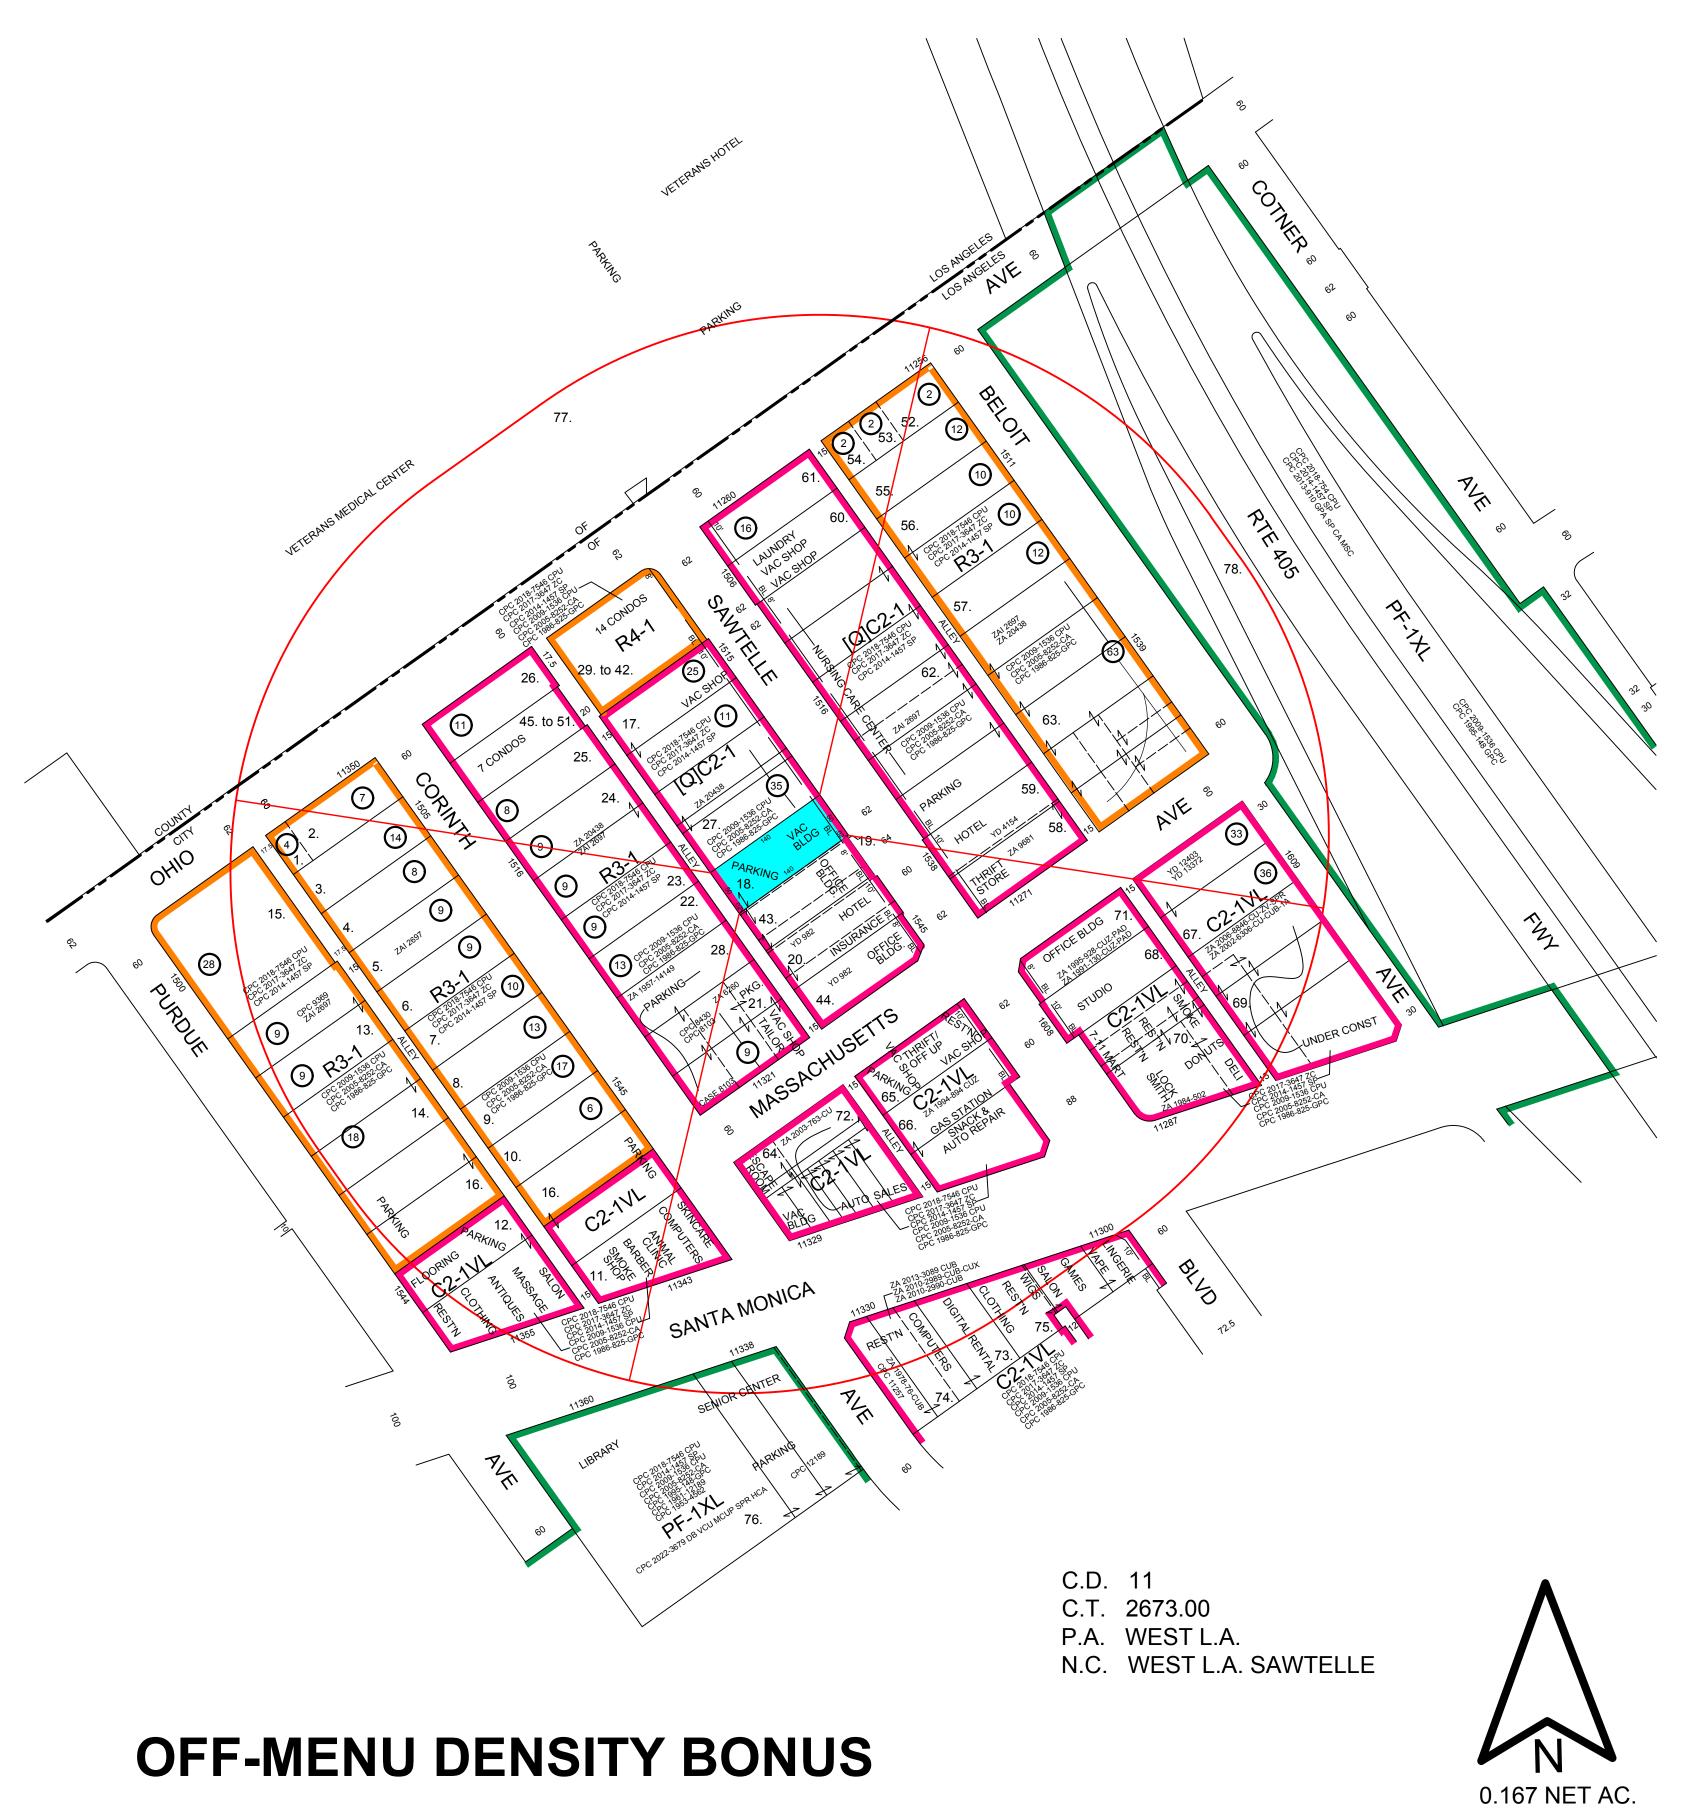

## **RADIUS MAPS ETC**

3544 PORTOLA AVENUE LOS ANGELES CA 90032 OFF/FAX:(323) 221-4555 radiusmapsetc@yahoo.com


## SITE LOCATION:


1531 S. SAWTELLE BOULEVARD LOS ANGELES, CA 90025

LEGAL DESCRIPTION: LOT 7 AND .02 FT OF LOT 8 (ARB 4), BARRETT VILLA TRACT, M.R. 70-32\35.

### CASE NO.

DATE:	06 - 07 - 2023
SCALE:	1" = 100'
USES:	FIELD
D.M.:	129 B 149
T.B. PAGE	: 632 GRID: A-5
A.P.N.:	4261-005-008

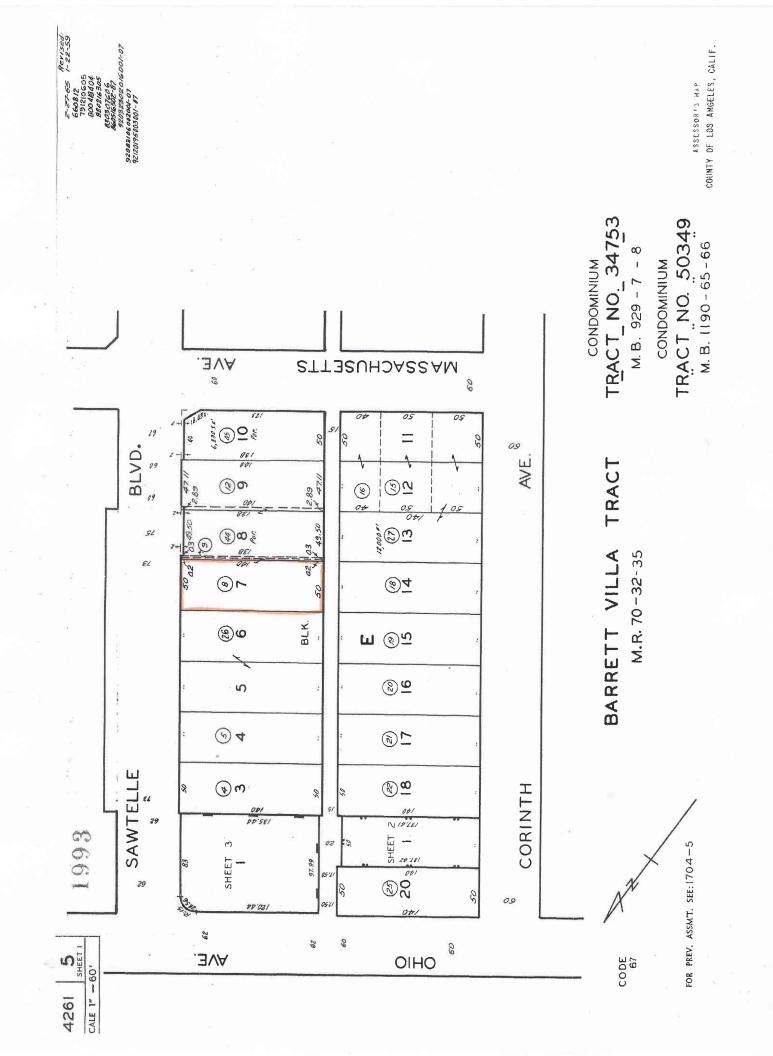

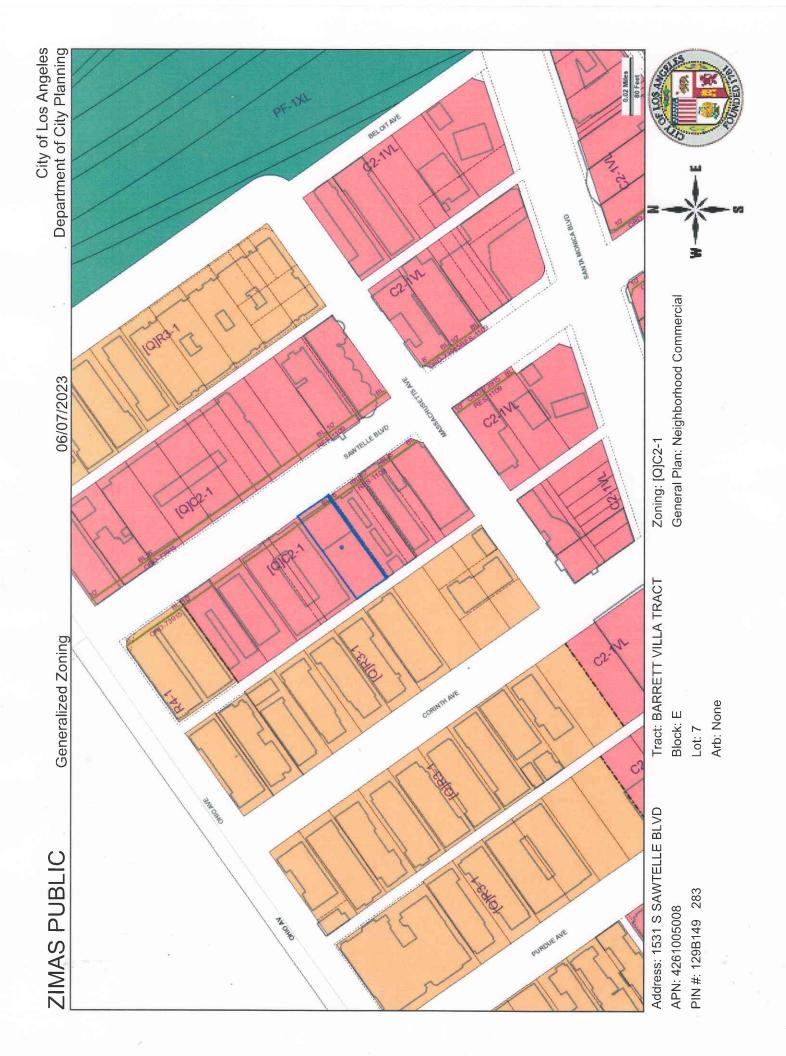



### **City of Los Angeles Department of City Planning**

### 8/3/2023 PARCEL PROFILE REPORT

PROPERTY ADDRESSES	Address/Legal Information	
1531 S SAWTELLE BLVD	PIN Number	129B149 283
1533 S SAWTELLE BLVD	Lot/Parcel Area (Calculated)	7,000.1 (sq ft)
1535 S SAWTELLE BLVD	Thomas Brothers Grid	PAGE 632 - GRID A5
	Assessor Parcel No. (APN)	4261005008
ZIP CODES	Tract	BARRETT VILLA TRACT
90025	Map Reference	M R 70-32/35
	Block	E
RECENT ACTIVITY	Lot	7
None	Arb (Lot Cut Reference)	None
	Map Sheet	129B149
CASE NUMBERS	Jurisdictional Information	
CPC-2018-7546-CPU	Community Plan Area	West Los Angeles
CPC-2014-1457-SP	Area Planning Commission	West Los Angeles
CPC-2009-1536-CPU	Neighborhood Council	West Los Angeles Sawtelle
CPC-2005-8252-CA	Council District	CD 11 - Traci Park
CPC-19XX-19311	Census Tract #	2673.00
CPC-1986-825-GPC	LADBS District Office	West Los Angeles
ORD-73915	Permitting and Zoning Compliance Information	tion
ORD-186108	Administrative Review	None
ORD-171492	Planning and Zoning Information	
ORD-171227	Special Notes	None
ORD-166311-SA185	Zoning	[Q]C2-1
ORD-163205	Zoning Information (ZI)	ZI-2441 Alquist-Priolo Earthquake Fault Zone
ORD-136483		ZI-2512 Housing Element Inventory of Sites
ENV-2014-1458-EIR-SE-CE		ZI-2442 Preliminary Fault Rupture Study Area
ENV-2009-1537-EIR		ZI-2427 Freeway Adjacent Advisory Notice for Sensitive Uses
ENV-2005-8253-ND		ZI-2452 Transit Priority Area in the City of Los Angeles
		ZI-2498 Local Emergency Temporary Regulations - Time Limits and Parking Relief - LAMC 16.02.1
		ZI-2192 Specific Plan: West Los Angeles Transportation Improvement and Mitigation
	General Plan Land Use	Neighborhood Commercial
	General Plan Note(s)	Yes
	Hillside Area (Zoning Code)	No
	Specific Plan Area	WEST LOS ANGELES TRANSPORTATION IMPROVEMENT AND MITIGATION
	Subarea	None
	Special Land Use / Zoning	None
	Historic Preservation Review	No
	Historic Preservation Overlay Zone	None
	Other Historic Designations	None
	Other Historic Survey Information	None
	Mills Act Contract	None
	CDO: Community Design Overlay	None
	CPIO: Community Plan Imp. Overlay	None
	Subarea	None
	CUGU: Clean Up-Green Up	None

HCR: Hillside Construction Regulation	No
NSO: Neighborhood Stabilization Overlay	No
POD: Pedestrian Oriented Districts	None
RBP: Restaurant Beverage Program Eligible Area	General (RBPA)
RFA: Residential Floor Area District	None
RIO: River Implementation Overlay	No
SN: Sign District	No
AB 2334: Very Low VMT	Yes
AB 2097: Reduced Parking Areas	Yes
Streetscape	No
Adaptive Reuse Incentive Area	None
Affordable Housing Linkage Fee	
Residential Market Area	High
Non-Residential Market Area	High
Transit Oriented Communities (TOC)	Tier 2
ED 1 Eligibility	Eligible Site
RPA: Redevelopment Project Area	None
Central City Parking	No
Downtown Parking	No
Building Line	10
500 Ft School Zone	No
500 Ft Park Zone	Active: Felicia Mahood Multipurpose Center
Assessor Information	
Assessor Parcel No. (APN)	4261005008
APN Area (Co. Public Works)*	0.167 (ac)
Use Code	1100 - Commercial - Store - One Story
Assessed Land Val.	\$100,856
Assessed Improvement Val.	\$22,585
Last Owner Change	06/14/2007
Last Sale Amount	\$0
Tax Rate Area	67
Deed Ref No. (City Clerk)	3-175
	2225967
	2225907
Building 1	
Year Built	1915
Building Class	D5A
Number of Units	0
Number of Bedrooms	0
Number of Bathrooms	0
Building Square Footage	2,500.0 (sq ft)
Building 2	No data for building 2
Building 3	No data for building 3
Building 4	No data for building 4
Building 5	No data for building 5
Rent Stabilization Ordinance (RSO)	No [APN: 4261005008]
Additional Information	
Airport Hazard	None
Coastal Zone	None
Santa Monica Mountains Zone	No
Farmland	Area Not Mapped
Urban Agriculture Incentive Zone	YES
Very High Fire Hazard Severity Zone	No
Fire District No. 1	No

Eland Zana	Outoida Elaad Zana
Flood Zone	Outside Flood Zone
Watercourse	No
Hazardous Waste / Border Zone Properties	No
Methane Hazard Site	Methane Zone
High Wind Velocity Areas	No
Special Grading Area (BOE Basic Grid Map A- 13372)	No
Wells	None
Seismic Hazards	
Active Fault Near-Source Zone	
Nearest Fault (Distance in km)	Within Fault Zone
Nearest Fault (Name)	Santa Monica Fault
Region	Transverse Ranges and Los Angeles Basin
Fault Type	В
Slip Rate (mm/year)	1.0000000
Slip Geometry	Left Lateral - Reverse - Oblique
Slip Type	Moderately / Poorly Constrained
Down Dip Width (km)	13.0000000
Rupture Top	0.0000000
Rupture Bottom	13.0000000
Dip Angle (degrees)	-75.0000000
Maximum Magnitude	6.6000000
Alquist-Priolo Fault Zone	Yes
Landslide	No
Liquefaction	Yes
Preliminary Fault Rupture Study Area	No
Tsunami Inundation Zone	No
Economic Development Areas	
Business Improvement District	None
Hubzone	Not Qualified
Jobs and Economic Development Incentive Zone (JEDI)	None
Opportunity Zone	No
Promise Zone	None
State Enterprise Zone	None
Housing	
Direct all Inquiries to	Los Angeles Housing Department
Telephone	(866) 557-7368
Website	https://housing.lacity.org
Rent Stabilization Ordinance (RSO)	No [APN: 4261005008]
Ellis Act Property	No [AFN: 4201005000] No
AB 1482: Tenant Protection Act	No
Housing Crisis Act Replacement Review	Yes
Housing Element Sites	Vec
HE Replacement Required	Yes
SB 166 Units	0.13 Units, Lower
Housing Use within Prior 5 Years	No
Public Safety	
Police Information	
Bureau	West
Division / Station	West Los Angeles
Reporting District	853
Fire Information	
Bureau	West
Battallion	9

District / Fire Station Red Flag Restricted Parking 59 No

#### **CASE SUMMARIES**

Note: Information for case summaries is retrieved from the Planning Department's Plan Case Tracking System (PCTS) database.

	se summaries is retrieved from the Planning Department's Plan Case Tracking System (PCTS) database.
Case Number:	CPC-2018-7546-CPU
Required Action(s):	CPU-COMMUNITY PLAN UPDATE
Project Descriptions(s):	ADOPT COMMUNITY PLAN POLICY DOCUMENT, GENERAL PLAN AMENDMENTS, AND ZONE CHANGES TO APPLY RE-CODE LA ZONING.
Case Number:	CPC-2014-1457-SP
Required Action(s):	SP-SPECIFIC PLAN (INCLUDING AMENDMENTS)
Project Descriptions(s):	SPECIFIC PLAN AMENDMENT
Case Number:	CPC-2009-1536-CPU
Required Action(s):	CPU-COMMUNITY PLAN UPDATE
Project Descriptions(s):	THE COMMUNITY PLAN WILL IMPLEMENT CHANGES TO ZONING, AMENDMENTS TO LAND USE PLAN DESIGNATIONS AND ESTABLISH OVERLAY ZONES, AS APPROPRIATE. PLAN AMENDMENTS WILL POTENTIALLY CHANGE OR REFINE PLAN DESIGNATIONS, FOOTNOTES OR STREET DESIGNATIONS AND MAKE CHANGES TO OTHER CITYWIDE ELEMENTS, AS NECESSARY. IN CONCERT WITH THE PROPOSED PLAN AMENDMENTS, NEW ZONES MAY BE NECESSARY TO MAINTAIN PLAN CONSISTENCY TO REGULATE DEVELOPMENT STANDARDS SUCH AS: HEIGHTS OF STRUCTURES, SETBACKS, LOT COVERAGE, DENSITY AND INTENSITY, OPEN SPACE, USE OF LAND, PARKING AND DESIGN. OVERLAY ZONES, DISTRICTS AND OTHER PLANS WOULD ADDITIONALLY BE ESTABLISHED TO REGULATE DEVELOPMENT THAT IS CONSISTENT WITH THE GENERAL PLAN, ENHANCE THE UNIQUE CHARACTER OF NEIGHBORHOODS AND ACCOMMODATE GROWTH. AREAS OF FOCUSED STUDY WILL INCLUDE, BUT NOT BE LIMITED TO, PROTECTING ESTABLISHED SINGLE FAMILY NEIGHBORHOODS, PEDESTRIAN AND DESIGN IMPROVEMENTS TO COMMERCIAL CORRIDORS SUCH AS PICO BOULEVARD, WESTWOOD BOULEVARD, SAWTELLE BOULEVARD, SANTA MONICA BOULEVARD, AND WILSHIRE BOULEVARD, ENHANCEMENT OF THE WEST LOS ANGELES CIVIC CENTER, MIXED-USE NODES ALONG MAJOR TRANSPORTATION AND TRANSIT ROUTES, APPROPRIATE LAND USE AND STREETSCAPE IMPROVEMENTS SURROUNDING FUTURE LIGHT-RAIL (EXPO LINE) TRANSIT STOPS, DESIGN AND USE PLANS FOR INDUSTRIAL DISTRICTS, AND DESIGN STANDARDS FOR MULTIFAMILY RESIDENTIAL AREAS.
Case Number:	CPC-2005-8252-CA
Required Action(s):	CA-CODE AMENDMENT
Project Descriptions(s):	AN ORDINANCE ESTABLISHING PERMANENT REGULATIONS IMPLEMENTING THE MELLO ACT IN THE COASTAL ZONE.
Case Number:	CPC-19XX-19311
Required Action(s):	Data Not Available
Project Descriptions(s):	
Case Number:	CPC-1986-825-GPC
Required Action(s):	GPC-GENERAL PLAN/ZONING CONSISTENCY (AB283)
Project Descriptions(s):	
Case Number:	ENV-2014-1458-EIR-SE-CE
Required Action(s):	EIR-ENVIRONMENTAL IMPACT REPORT
	SE-STATUTORY EXEMPTIONS
	CE-CATEGORICAL EXEMPTION
Project Descriptions(s):	ENVIRONMENTAL IMPACT REPORT
Case Number:	ENV-2009-1537-EIR
Required Action(s):	EIR-ENVIRONMENTAL IMPACT REPORT

THE COMMUNITY PLAN WILL IMPLEMENT CHANGES TO ZONING, AMENDMENTS TO LAND USE PLAN DESIGNATIONS AND Project Descriptions(s): ESTABLISH OVERLAY ZONES, AS APPROPRIATE. PLAN AMENDMENTS WILL POTENTIALLY CHANGE OR REFINE PLAN DESIGNATIONS. FOOTNOTES OR STREET DESIGNATIONS AND MAKE CHANGES TO OTHER CITYWIDE ELEMENTS. AS NECESSARY. IN CONCERT WITH THE PROPOSED PLAN AMENDMENTS, NEW ZONES MAY BE NECESSARY TO MAINTAIN PLAN CONSISTENCY TO REGULATE DEVELOPMENT STANDARDS SUCH AS: HEIGHTS OF STRUCTURES, SETBACKS, LOT COVERAGE, DENSITY AND INTENSITY, OPEN SPACE, USE OF LAND, PARKING AND DESIGN. OVERLAY ZONES, DISTRICTS AND OTHER PLANS WOULD ADDITIONALLY BE ESTABLISHED TO REGULATE DEVELOPMENT THAT IS CONSISTENT WITH THE GENERAL PLAN, ENHANCE THE UNIQUE CHARACTER OF NEIGHBORHOODS AND ACCOMMODATE GROWTH. AREAS OF FOCUSED STUDY WILL INCLUDE, BUT NOT BE LIMITED TO, PROTECTING ESTABLISHED SINGLE FAMILY NEIGHBORHOODS, PEDESTRIAN AND DESIGN IMPROVEMENTS TO COMMERCIAL CORRIDORS SUCH AS PICO BOULEVARD, WESTWOOD BOULEVARD, SAWTELLE BOULEVARD, SANTA MONICA BOULEVARD, AND WILSHIRE BOULEVARD, ENHANCEMENT OF THE WEST LOS ANGELES CIVIC CENTER, MIXED-USE NODES ALONG MAJOR TRANSPORTATION AND TRANSIT ROUTES, APPROPRIATE LAND USE AND STREETSCAPE IMPROVEMENTS SURROUNDING FUTURE LIGHT-RAIL (EXPO LINE) TRANSIT STOPS, DESIGN AND USE PLANS FOR INDUSTRIAL DISTRICTS, AND DESIGN STANDARDS FOR MULTIFAMILY RESIDENTIAL AREAS. WITHIN THE PALMS STUDY AREA, THE CITY INTENDS TO EXTEND THE LIVABLE BOULEVARDS STUDY BEYOND THE WEST LOS ANGELES CPA TO CREATE VIABLE COMMERCIAL CENTERS AND RESIDENTIAL NEIGHBORHOODS IN THE PALMS COMMUNITY AND IMPLEMENT GOALS AND POLICIES IN THE PALMS-MAR VISTA-DEL REY COMMUNITY PLAN AND FRAMEWORK ELEMENT. WITHIN THE PALMS AREA, IMPROVEMENTS TO THE LOCAL TRANSPORTATION NETWORK FOR PEDESTRIAN, BICYCLES, AND AUTOS WILL BE RECOMMENDED. ZONING TOOLS SUCH AS OVERLAY DISTRICTS MAY BE USED IN SELECTED AREAS TO COMPLEMENT STREET ENHANCEMENTS BY IMPROVING BUILDING DESIGN AND WALKABILITY, RESULTING IN ZONE CHANGES. Case Number: ENV-2005-8253-ND Required Action(s): ND-NEGATIVE DECLARATION

AN ORDINANCE ESTABLISHING PERMANENT REGULATIONS IMPLEMENTING THE MELLO ACT IN THE COASTAL ZONE.

### DATA NOT AVAILABLE

Project Descriptions(s):

ORD-73915 ORD-186108 ORD-171492 ORD-171227 ORD-166311-SA185 ORD-163205 ORD-136483

> This report is subject to the terms and conditions as set forth on the website. For more details, please refer to the terms and conditions at zimas.lacity.org (\*) - APN Area is provided "as is" from the Los Angeles County's Public Works, Flood Control, Benefit Assessment.



Address: 1531 S SAWTELLE BLVD APN: 4261005008 PIN #: 129B149 283 Tract: BARRETT VILLA TRACT Block: E Lot: 7 Arb: None Zoning: [Q]C2-1 General Plan: Neighborhood Commercial



### **LEGEND**

### **GENERALIZED ZONING**

OS, GW
A, RA
RE, RS, R1, RU, RZ, RW1
R2, RD, RMP, RW2, R3, RAS, R4, R5, PVSP
CR, C1, C1.5, C2, C4, C5, CW, WC, ADP, LASED, CEC, USC, PPSP, MU, NMU
CM, MR, CCS, UV, UI, UC, M1, M2, LAX, M3, SL, HJ, HR, NI
P, PB
PF

### **GENERAL PLAN LAND USE**

### LAND USE

### RESIDENTIAL

Minimum Residential	
Very Low / Very Low   Residential	INDUSTRIAL
Very Low II Residential	Commercial Manufacturing
Low / Low I Residential	Limited Manufacturing
Low II Residential	Light Manufacturing
Low Medium / Low Medium I Residential	Heavy Manufacturing
Low Medium II Residential	Hybrid Industrial
Medium Residential	PARKING
High Medium Residential	Parking Buffer
High Density Residential	PORT OF LOS ANGELES
Very High Medium Residential	General / Bulk Cargo - Non Hazardous (Industrial / Commercial)
COMMERCIAL	General / Bulk Cargo - Hazard
Limited Commercial	Commercial Fishing
Limited Commercial - Mixed Medium Residential	Recreation and Commercial
Highway Oriented Commercial	Intermodal Container Transfer Facility Site
Highway Oriented and Limited Commercial	LOS ANGELES INTERNATIONAL AIRPORT
Highway Oriented Commercial - Mixed Medium Residential	Airport Landside / Airport Landside Support
Neighborhood Office Commercial	Airport Airside
Community Commercial	LAX Airport Northside
Community Commercial - Mixed High Residential	OPEN SPACE / PUBLIC FACILITIES
Regional Center Commercial	Open Space
	Public / Open Space
FRAMEWORK	Public / Quasi-Public Open Space
	Other Public Open Space
COMMERCIAL	Public Facilities
Neighborhood Commercial	
General Commercial	
Community Commercial	Limited Industrial
🗱 Regional Mixed Commercial	Light Industrial

### **CIRCULATION**

### STREET

Arterial Mountain Road Major Scenic Highway Collector Scenic Street Major Scenic Highway (Modified) Collector Street Major Scenic Highway II ----- Collector Street (Hillside) ----- Mountain Collector Street ----- Collector Street (Modified) ---- Park Road ----- Collector Street (Proposed) ——- Parkway Country Road Principal Major Highway — Divided Major Highway II \_\_\_\_ ---- Private Street Divided Secondary Scenic Highway Scenic Divided Major Highway II Local Scenic Road Scenic Park Local Street Scenic Parkway Major Highway (Modified) — Secondary Highway Major Highway I Secondary Highway (Modified) Major Highway II Secondary Scenic Highway Major Highway II (Modified) ---- Special Collector Street Super Major Highway

### **FREEWAYS**

Freeway

- Interchange
- —— On-Ramp / Off- Ramp
- Hailroad
- Scenic Freeway Highway

### **MISC. LINES**

	Airport Boundary	•=•=••	MSA Desirable Open Space
	Bus Line	o <u> </u>	Major Scenic Controls
	Coastal Zone Boundary		Multi-Purpose Trail
	Coastline Boundary	uuu	Natural Resource Reserve
	Collector Scenic Street (Proposed)		Park Road
	Commercial Areas		Park Road (Proposed)
	Commercial Center		Quasi-Public
• • • •	Community Redevelopment Project Area		Rapid Transit Line
	Country Road		Residential Planned Development
× × × ×	DWP Power Lines		Scenic Highway (Obsolete)
******	Desirable Open Space	° — ° —	Secondary Scenic Controls
• - • -	Detached Single Family House	- • - •	Secondary Scenic Highway (Proposed)
	Endangered Ridgeline		Site Boundary
	Equestrian and/or Hiking Trail	⊗—	Southern California Edison Power
	Hiking Trail		Special Study Area
	Historical Preservation	• • • • •	Specific Plan Area
	Horsekeeping Area	-• -•	Stagecoach Line
	Local Street		Wildlife Corridor

### **POINTS OF INTEREST**

- 🗊 Alternative Youth Hostel (Proposed)
- Animal Shelter
- 📩 Area Library
- 庙 Area Library (Proposed)
- 🕾 Bridge
- ▲ Campground
- Campground (Proposed)
- 👻 Cemetery
- HW Church
- 🛓 City Hall
- 🕅 Community Center
- M Community Library
- Community Library (Proposed Expansion)
- Community Library (Proposed)
- XX Community Park
- 🕱 Community Park (Proposed Expansion)
- XX Community Park (Proposed)
- 🚔 Community Transit Center
- 🛉 Convalescent Hospital
- 🕱 Correctional Facility
- 🛠 Cultural / Historic Site (Proposed)
- 🛠 Cultural / Historical Site
- 🗰 Cultural Arts Center
- DMV DMV Office
- DWP DWP
- $\mathcal{T}$  DWP Pumping Station
- 🐆 Equestrian Center
- Fire Department Headquarters
- 📻 Fire Station
- 🖶 Fire Station (Proposed Expansion)
- Fire Station (Proposed)
- Fire Supply & Maintenance
- \land Fire Training Site
- 🛳 Fireboat Station
- + Health Center / Medical Facility
- 🖛 Helistop
- Historic Monument
- n Historical / Cultural Monument
- 🔭 Horsekeeping Area
- 🔭 Horsekeeping Area (Proposed)
- Horticultural Center 📕 Hospital Hospital (Proposed) HW House of Worship C Important Ecological Area Important Ecological Area (Proposed) e ☺ Interpretive Center (Proposed) JC Junior College MTA / Metrolink Station M MTA Station MTA Stop MWD MWD Headquarters 🖛 Maintenance Yard Municipal Office Building P Municipal Parking lot X. Neighborhood Park X Neighborhood Park (Proposed Expansion) X Neighborhood Park (Proposed) 1 Oil Collection Center Parking Enforcement P Police Headquarters 8 **Police Station** Police Station (Proposed Expansion) Police Station (Proposed) Police Training site Ê. PO Post Office ŧ Power Distribution Station ŧ Power Distribution Station (Proposed) **Power Receiving Station** ŧ Power Receiving Station (Proposed) 3 С Private College Private Elementary School Е  $|\lambda|$ Private Golf Course (Proposed) JH Private Junior High School **PS** Private Pre-School **XXX** Private Recreation & Cultural Facility SH Private Senior High School SF Private Special School
- (È) Public Elementary (Proposed Expansion)
- Public Elementary School F 全 Public Elementary School (Proposed) Public Golf Course 1 Public Golf Course (Proposed) Public Housing Public Housing (Proposed Expansion) Π. Public Junior High School 前 Public Junior High School (Proposed) ms Public Middle School SH Public Senior High School ईंगे Public Senior High School (Proposed) Pumping Station Pumping Station (Proposed) \* Refuse Collection Center 💼 Regional Library Regional Library (Proposed Expansion) Regional Library (Proposed) 🐔 Regional Park 蔬 Regional Park (Proposed) **RPD** Residential Plan Development Scenic View Site Scenic View Site (Proposed) ADM School District Headquarters sc School Unspecified Loc/Type (Proposed) 🗰 Skill Center ss Social Services Special Feature  $\star$ 😥 Special Recreation (a) ŜF Special School Facility sF Special School Facility (Proposed) Steam Plant (sm) Surface Mining Trail & Assembly Area 📥 🛛 Trail & Assembly Area (Proposed) UTL Utility Yard Water Tank Reservoir
- ⅔ Wildlife Migration Corridor
- 🕋 Wildlife Preserve Gate

### SCHOOLS/PARKS WITH 500 FT. BUFFER



### **COASTAL ZONE**

### **TRANSIT ORIENTED COMMUNITIES (TOC)**



### WAIVER OF DEDICATION OR IMPROVEMENT


Public Work Approval (PWA)


Waiver of Dedication or Improvement (WDI)

### **OTHER SYMBOLS**





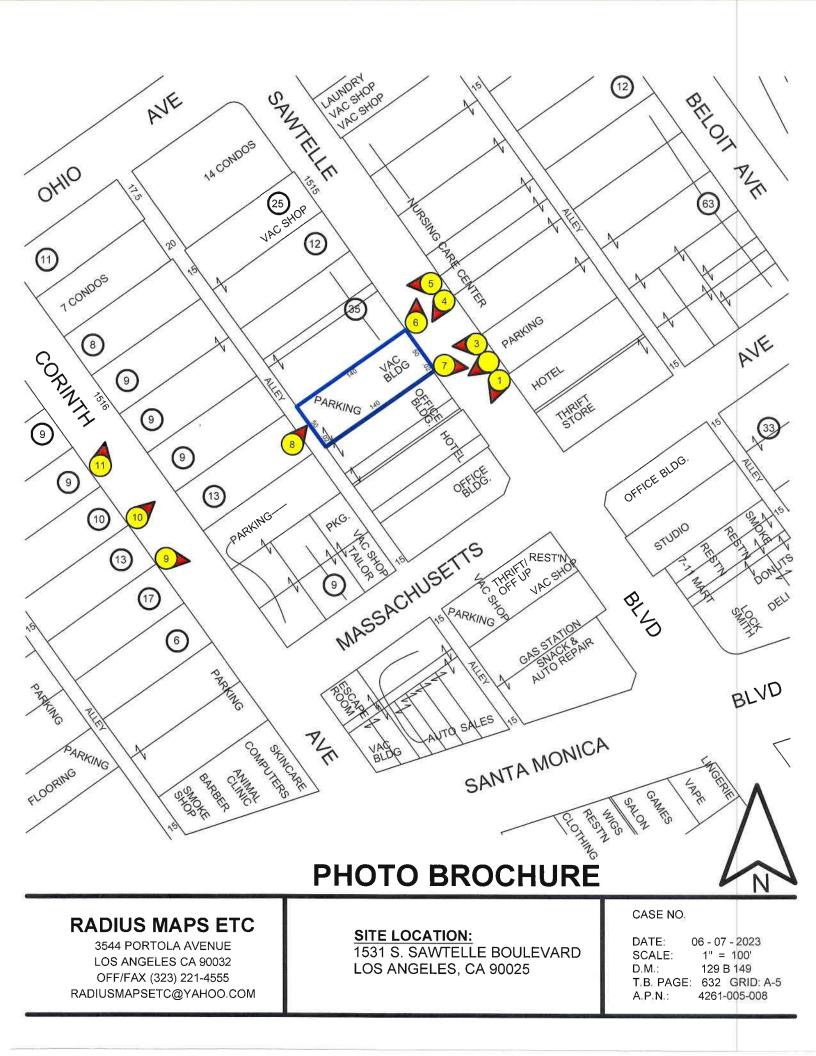

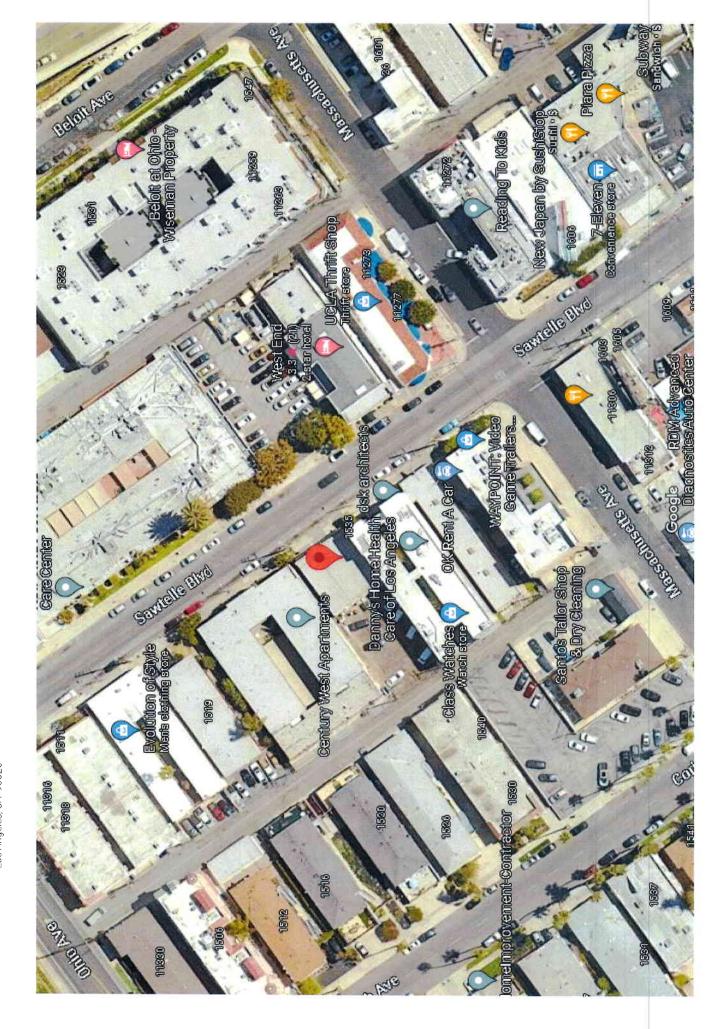

Google Maps 1531 Sawtelle Blvd Los Angeles, CA 90025



1.

2.








7.

8.



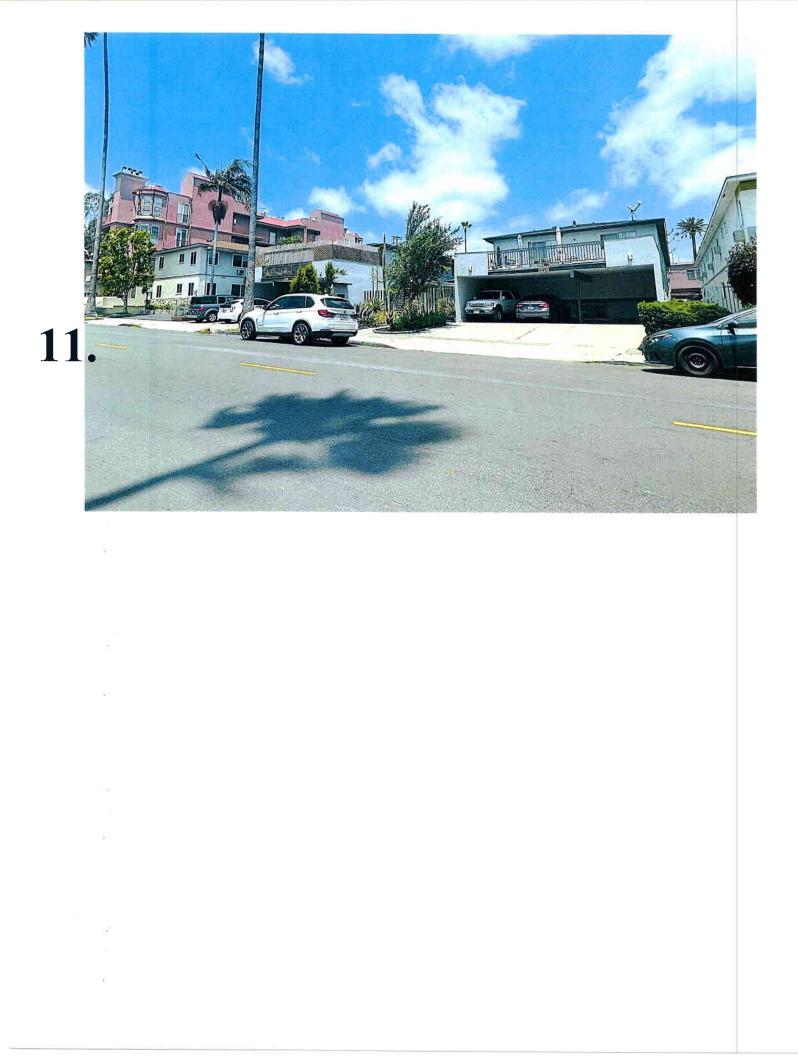



### PRELIMINARY ZONING ASSESSMENT

This form is to serve as an inter-agency referral for City Planning applications associated with a project creating two or more residential units. As a part of a City Planning application, a completed Preliminary Zoning Assessment (PZA) form, accompanied by architectural plans, shall be submitted to Plan Check staff at the Department of Building and Safety (LADBS). LADBS Plan Check staff will sign the PZA form and the architectural plans once the informational Zoning Plan Check verifications are completed. Following the completion of the PZA process, a City Planning application may be filed along with all other applicable filing requirements.

Review of the referral form by City staff is intended to determine compliance with City zoning and land use requirements necessary to achieve the proposed project and to identify any zoning issues or necessary approvals that would need to be resolved through a City Planning application. The informational Zoning Plan Check done through the PZA process does not constitute a zoning approval and does not require compliance with development standards to be completed.

To check if a project type qualifies for and requires the PZA form, see the <u>Housing Development</u> <u>Project Applicability Matrix</u> available on the City Planning Forms <u>webpage</u>.

### **CONTACT INFORMATION**

### Department of Building and Safety, Affordable Housing Section

201 N. Figueroa St., Ste 830 Los Angeles, CA 90012 Phone: (213) 482-0455 Web: <u>https://ladbs.org/services/special-assistance/</u> <u>affordable-housing</u> Email: <u>LADBS.AHS@lacity.org</u>

Department of City Planning, Development Services Center

For locations and hours: <a href="https://planning.lacity.org/contact/locations-hours">https://planning.lacity.org/contact/locations-hours</a>

### THIS SECTION TO BE COMPLETED BY LADBS PLAN CHECK STAFF ONLY

LADBS Plan Check Staff Name and Title	LADBS Plan Check Staff Signature <sup>1</sup>
NILOOFAR MEHRAIN	Niloofar Mehrain
Plan Check Application No. <sup>2</sup>	Date
22010-20K-06482	JULY 6, 2023

**ED 1 Eligible** 

LADBS Plan Check staff will sign the Preliminary Zoning Assessment Form once the Zoning Plan Check verifications are complete.

<sup>2</sup> This completed form shall be accompanied by plans signed by a DBS Plan Check staff following the completion of a Zoning Plan Check.

### THIS SECTION TO BE COMPLETED BY THE APPLICANT<sup>3</sup>

### **PROJECT INFORMATION**

### I. PROJECT LOCATION, ZONING & LAND USE JURISDICTION

Project Address: 1531-1535 S. Sawtelle Blvd., Los Angeles, CA 90025

Project Name (if applicable):		
Assessor Parcel Number(s): 4261-005-0	008	
Legal Description (Lot, Block, Tract): <u>L</u>	ot 7 & Lot FR 8, Arb	4, Block E, Barrett Villa Tract
Community Plan: West Los Angeles	Number of Parcels	s: <u>2</u> Site Area: <u>7,029</u> sq. ft.
Current Zone(s) & Height District(s): [Q	<u>]</u> C2-1	Land Use Designation: <u>Neigh.</u> Com.
□ YES  Imes NO ED 1 Eligible 4	🗆 YES 🗵 NO	Site Contains Historical Features
🗌 YES 🗵 NO Alley in Rear	🗆 YES 🗵 NO	Downtown Design Guide Area
🗌 YES 🗵 NO <b>Coastal Zone</b>	🗆 YES 🗵 NO	Special Grading Area (BOE) Area
□ YES ⊠ NO Hillside Area (Zoning)	🗆 YES 🗵 NO	Very High Fire Hazard Severity Zone
□ YES ⊠ NO Enterprise Zone	🗆 YES 🗵 NO	Greater Downtown Housing Incentive Area
Specific Plan:		
□ Historic Preservation Overlay Zone (	(HPOZ):	
Design Review Board (DRB):		
Redevelopment Project Area:		
□ Overlay Zone (CPIO/CDO/POD/NSO/	RIO/CUGU/etc.):	
☑ Q Condition/ D Limitation/ T Classifie	cation (Ordinance	No. and Subarea): Ord 166331-SA185
Description of Condition: 45' height l	limit and C1 uses.	
Legal (Lot Cut Date)		

### □ Related City Planning Cases \_

<sup>&</sup>lt;sup>3</sup> All fields in this form must be completed. If an item is not applicable, write N/A.

<sup>&</sup>lt;sup>4</sup> Refer to <u>Executive Directive 1 Implementation Guidelines</u> for qualifying criteria. If the project is determined to be ineligible for ED 1, a new Referral Form will need to be obtained.

□ Z.I.(s)
□ Affidavits
Easements
☐ TOC Tier⁵ (if applicable to project)
II. PROJECT DESCRIPTION
Project Description/Proposed Use Demolition of the existing commercial structure and
construction of a new 15,927 sf., five-story, 56' apartment building with nine dwelling units, including
one 4BR unit, five 5BR units, and three 6BR units, with one ELI unit, and 1,575 sf. of open space.
No. of Stories: <u>5</u> No. of Dwelling Units: <u>9</u> Floor Area (Zoning): <u>15,927 sf.</u>
Present Use/No. of Units: 2,500 sf. retail building, c. 1915.
III.CITY PLANNING ACTION(S) REQUESTED Provide the Los Angeles Municipal Code (LAMC) Section that authorizes the request to City Planning and (if applicable) the Section in the LAMC or the Specific Plan/Overlay from which relief is sought;
III.CITY PLANNING ACTION(S) REQUESTED Provide the Los Angeles Municipal Code (LAMC) Section that authorizes the request to City Planning and (if applicable) the Section in the LAMC or the Specific Plan/Overlay from which relief is sought; follow with a description of the requested action.
<ul> <li>III.CITY PLANNING ACTION(S) REQUESTED</li> <li>Provide the Los Angeles Municipal Code (LAMC) Section that authorizes the request to City Planning and (if applicable) the Section in the LAMC or the Specific Plan/Overlay from which relief is sought; follow with a description of the requested action.</li> <li>Authorizing Code Section: 12.22-A,25</li> </ul>
III. CITY PLANNING ACTION(S) REQUESTED         Provide the Los Angeles Municipal Code (LAMC) Section that authorizes the request to City Planning and (if applicable) the Section in the LAMC or the Specific Plan/Overlay from which relief is sought; follow with a description of the requested action.         Authorizing Code Section:       12.22-A,25         Code Section from which relief is requested (if any):

. . . . . . .

Action Requested, Narrative: \_\_\_\_\_

Additional Requests Attached

<sup>5</sup> Must be verified by the City Planning Affordable Housing Services Section. A Tier Verification for projects using the TOC guidelines is required to initiate a Preliminary Zoning Assessment with LADBS. Contact <u>Planning.PriorityHousing@lacity.org</u>.

□ YES ⊠ NO

### **IV.APPLICANT INFORMATION6**

Name: 1531 Sawtelle LLC

Phone: (213) 479-7521

Email: gary@alchemyplanning.com

### V. REPRESENTATIVE INFORMATION

Name: Gary Benjamin, Alchemy Planning + Land Use

Phone: (213) 479-7521

Email: gary@alchemyplanning.com

<sup>&</sup>lt;sup>6</sup> An applicant is a person with a lasting interest in the completed project such as the property owner or a lessee/user of a project. An applicant is not someone filing a case on behalf of a client (i.e. usually not the agent/representative).

### **NM** (LADBS Staff Initials)

are complete. Per the applicable section of the Zoning Code, Specific Plan, Zoning Overlay, Ordinance, Bonus Program, Planning Case Condition.

LADBS Plan Check staff will sign Section IV of the Preliminary Zoning Assessment (PZA) form and provide signed architectural plans once the Zoning Plan Check verifications

Shopping Center height applies (LAMC Commercial Corner Development/Mini-Conditional Use (LAMC Section 12.24) Transitional Height applies (LAMC Section 12.22 A.23(a)(1)) Section 12.21.1 A.10) for YES X YES A/A 0 N 0 Z X 45FT **APARTMENT** 56FT Height Use 2 ~

# VI. PRELIMINARY ZONING ASSESSMENT SUMMARY

THIS SECTION TO BE COMPLETED BY LADBS PLAN CHECK STAFF7

Required/ Allowed

Proposed

Standard Zoning

ltem No.

Standard Applicable LAMC Comments and Additional Information Met Section No.<sup>8</sup>

[3.23.2023]
CP-4064
—
Planning
iť
Cit
-

*JVM* (LADBS Staff Initials)

Page 6 of 18

<sup>9</sup> Per the applicable section of the Zoning Code, Specific Plan, Zoning Overlay, Ordinance, Bonus Program, Planning Case Condition.

Comments and Additional Information		
Comments and A		
Applicable Section No. <sup>9</sup>	LAMC Section 12.21.1 (if code prevails)	
Standard Met	X YES NO N/A	□ YES ▼ NO □ N/A
Required/ Allowed	NO LIMIT	1.5:1 7,383SF
Proposed	ى ب	3.25:1 (15,972SF)
Zoning Standard	No. of Stories	FAR (Floor Area Ratio)
ltem No.	m	4

8
$\overline{\mathbf{Q}}$
0
.2023
~
62
$\sim$
~
[3.23
4
1062
0
4
1
0
$\overline{\mathbf{O}}$
$\cup$
_
D
<u> </u>
÷
nir
Innir
annir
Jannir
Plannir
~
$\geq$
$\geq$
~
s City I
ungeles City I
s City I
Angeles City I
Angeles City I
ungeles City I

 $\overline{\mathcal{M}}$  (LADBS Staff Initials)

Page 7 of 18

<sup>10</sup> Per the applicable section of the Zoning Code, Specific Plan, Zoning Overlay, Ordinance, Bonus Program, Planning Case Condition.

ltem No.	Zoning Standard	Proposed	Required/ Allowed	Standard Met	Applicable Section No. <sup>10</sup>	Comments and Additional Information
ц	<b>RFAR</b> (Residential Floor Area Ratio)			YES NA NA		
ω	Density	თ	8	<ul><li>YES</li><li>⋈ N</li></ul>		Density Ratio: CUP (12.24 U.14) CUP (12.24 U.14)

Page 8 of 18

 $\overline{\mathcal{M}}$  (LADBS Staff Initials)

<sup>11</sup> Per the applicable section of the Zoning Code, Specific Plan, Zoning Overlay, Ordinance, Bonus Program, Planning Case Condition.

Comments and Additional Information	Lot Line Location (Street Name): Lot Line Location (Street Name):	Offset/plane break met:
Applicable Section No. <sup>11</sup>		
Standard Met	X YES	□ YES ⊠ NO
Required/ Allowed	7FT	8FT
Proposed	7FT	5FT
Zoning Standard	Setback (Front)	Setback (Side)
ltem No.	2	ω

**JVM** (LADBS Staff Initials)

Page 9 of 18

<sup>12</sup> Per the applicable section of the Zoning Code, Specific Plan, Zoning Overlay, Ordinance, Bonus Program, Planning Case Condition.

Comments and Additional Information		
Applicable Section No. <sup>12</sup>		Ordinance No.:
Standard Met	XES NO N/A	X YES NO
Required/ Allowed	18FT	7FT
Proposed	18FT	7FT
Zoning Standard	Setback (Rear)	Building Line
ltem No.	თ	10

*JVM* (LADBS Staff Initials)

Page 10 of 18

<sup>13</sup> Per the applicable section of the Zoning Code, Specific Plan, Zoning Overlay, Ordinance, Bonus Program, Planning Case Condition.

Comments and Additional Information	Design standards met(12.21 A5):          YES       NO         Improvement standards met (12.21 A.6 (except landscaping, to be determined by City Planning)):         YES       NO	Facility standards met:          YES       NO         Design standards met:         YES       NO	
Applicable Section No. <sup>13</sup>	LAMC Section 12.21 A.4 (if code prevails)	LAMC Section 12.21 A.16 (if code prevails)	
Standard Met	∠ES N/A	XES N/A	
Required/ Allowed	Residential: 9 N/A N/A	Long-term: 9 Short-term: 2	
Proposed	Residential: 0 Non- Residential: N/A	Long-term: 0 Short-term: 0	
Zoning Standard	Parking (automobile)	<b>Bicycle</b> Parking (residential)	
ltem No.	7	12	

**JVM** (LADBS Staff Initials)

<sup>14</sup> Per the applicable section of the Zoning Code, Specific Plan, Zoning Overlay, Ordinance, Bonus Program, Planning Case Condition.

ltem No.	Zoning Standard	Proposed	Required/ Allowed	Standard Met	Applicable Section No. <sup>14</sup>	Comments and Additional Information
<del>.</del>	<b>Bicycle Parking</b> (non-residential)	Long-term: Short-term:	Long-term: Short-term:	□ YES □ N/A	LAMC Section 12.21 A.16 (if code prevails)	Facility standards met: TES NO Pesign standards met: TES NO
4	Open Space	Total (sq. ft.): 1575SF Common (sq. ft.): 1575SF Private (sq. ft.):	Total: 1575SF Common: 1575SF Private:	X YES N/A	LAMC Section 12.21 G (if code prevails)	Units/Habitable Room <3: 0 =3: 0 >3: 9 Dimensions met: □ YES □ NO

Page 11 of 18

*JVM* (LADBS Staff Initials)

Page 12 of 18

<sup>15</sup> Per the applicable section of the Zoning Code, Specific Plan, Zoning Overlay, Ordinance, Bonus Program, Planning Case Condition.

Comments and Additional Information		
Applicable Section No. <sup>15</sup>	LAMC Section 12.21 C.8 (if code prevails)	
Standard Met	TES NO NA NA	□ YES □ NO □ N/A
Required/ Allowed	Max Height: Max Quantity:	
Proposed	Max Height: Max Quantity:	
Zoning Standard	Retaining Walls in Special Grading Areas	<b>Grading</b> (Zoning and Planning limitations)
ltem No.	15	16

 $\overline{\mathcal{M}}$  (LADBS Staff Initials)

Page 13 of 18

<sup>16</sup> Per the applicable section of the Zoning Code, Specific Plan, Zoning Overlay, Ordinance, Bonus Program, Planning Case Condition.

Comments and Additional Information		
Applicable Section No. <sup>16</sup>		
Standard Met	□ YES N/A	□ YES □ NO □ N/A
Required/ Allowed		
Proposed		
Zoning Standard	Lot Coverage	Lot Width
ltem No.	17	

*JVM* (LADBS Staff Initials)

Page 14 of 18

<sup>17</sup> Per the applicable section of the Zoning Code, Specific Plan, Zoning Overlay, Ordinance, Bonus Program, Planning Case Condition.

Comments and Additional Information		
Applicable Section No. <sup>17</sup>	LAMC Section 12.21 C.2(a) (if code prevails)	LAMC Section 12.21 C.2(b) (if code prevails)
Standard Met	VES NA	YES NO
Required/ Allowed		
Proposed		
Zoning Standard	Space between Buildings	Passageway
ltem No.	6	20

\_\_\_\_\_\_ (LADBS Staff Initials)

Page 15 of 18

<sup>18</sup> Per the applicable section of the Zoning Code, Specific Plan, Zoning Overlay, Ordinance, Bonus Program, Planning Case Condition.

Comments and Additional Information		
Standard Applicable Met Section No. <sup>18</sup>	LAMC Section 12.21 C.5 (if code prevails)	
Standard Met	□ YES □ N/A	TES N/A
Required/ Allowed		
Proposed		
Zoning Standard	Location of Accessory Buildings	Loading Area
ltem No.	21	22

*JVM* (LADBS Staff Initials)

Page 16 of 18

<sup>19</sup> Per the applicable section of the Zoning Code, Specific Plan, Zoning Overlay, Ordinance, Bonus Program, Planning Case Condition.

Comments and Additional Information		
Applicable Section No. <sup>19</sup>		
Standard Met	YES N/A	ngeles City
Required/ Allowed		Conformance determined by Los Angeles City Planning
Proposed		Conformance o Planning
Zoning Standard	Trash & Recycling	Landscape
ltem No.	23	24

 $\overline{\mathcal{M}}$  (LADBS Staff Initials)

Page 17 of 18

<sup>20</sup> Per the applicable section of the Zoning Code, Specific Plan, Zoning Overlay, Ordinance, Bonus Program, Planning Case Condition.

Comments and Additional Information		Additional Sheet(s) attached:
Comments ar		Additional Sheet(
Applicable Section No. <sup>20</sup>		
Standard Met	□ YES □ N/A	
Required/ Allowed	∠ES N/A	See additional sheets, if applicable
Proposed	YES NA	See additional
Zoning Standard	Private Street	Other (e.g., ground floor transparency, lighting, utilities, signage, walls, lot area, minimum frontage, etc.)
ltem No.	25	

 $\overline{\mathcal{M}}$  (LADBS Staff Initials)

Comments and Additional Information						
Applicable Section No.						
Standard Met	□ YES □ NO					
Required/ Allowed						
Proposed						
Zoning Standard						
ltem No.						

## ADDITIONAL ZONING AND LAND USE STANDARDS REVIEWED to be completed by LADBS Plan Check Staff

Page 18 of 18

### PAR-2023-3785-AHRF

Revised By Isaiah Ross, Los Angeles City Planni on 1/10/25.

### AFFORDABLE HOUSING REFERRAL FORM

This form is to serve as a referral to the Los Angeles City Planning's Development Services Center (DSC) for Affordable Housing case filing purposes (in addition to the required City Planning Application and any other necessary documentation); and to the City of Los Angeles Housing Department (LAHD), Department of Building and Safety (LADBS), or other City agency for project status and entitlement need purposes. All Applicants are required to provide a complete set of architectural plans at the time that this form is submitted for review. Any application submitted that is missing any required materials will be considered incomplete and will not be reviewed until all materials are submitted.

This form shall be completed by the Applicant and reviewed and signed by City Planning DSC Afforable Housing Services Section (AHSS) Staff prior to filing an application for an entitlement, administrative review, or building permit. Any modifications to the content(s) of this form after its authorization by AHSS Staff is prohibited. City Planning reserves the right to require an updated Referral Form for the project if more than 180 days have transpired since the referral date, or as necessary, to reflect project modifications, policy changes, bus route changes, bus schedule changes, and/or amendments to the Los Angeles Municipal Code (LAMC), local laws, and State laws.

Note: This Referral Form <u>does not</u> constitute a City Planning application. See the Forms webpage for City Planning Application (<u>CP-7771.1</u>) and the City Planning Application Filing Instructions (<u>CP-7810</u>). If the project is located within a Specific Plan or Overlay Zone, check with the assigned planner prior to preparing these plans, as some have additional or different requirements. An <u>Assignment List</u> can be found on the City Planning website at <u>http://planning.lacity.org</u> under the "About" tab, under "Staff Directory."

### THIS SECTION TO BE COMPLETED BY AHSS STAFF ONLY

Planning Staff Name & Title:       Aida Karapetian/ Planning Assistant         Planning Staff Signature:       Aida Karapetian/ Planning Assistant         Referral Date:       07/19/2023         Expiration Date:       01/15/2024				
Case Number: PAR- 2023-3785-AHRF				
TRANSPORTATION QUALIFIERS (if applicable)				
🗌 Major Transit Stop 🛛 Paratransit / Fixed Bus Route 🛛 Very Low Vehicle Travel Areas				
□ Other:				
Location of Transit:				

### **City Planning Case Referral**



### **Project Information**

LA Sanitation Case Referral #: <u>1178</u>

Date: 8/1/2023

Site Information	Applicant Information				
Project Address: 1531 S. Sawtelle Blvd	Gary Benjamin     Name:				
APN: 4261005008	Email: gary@alchemyplanning.com				
Type of Project: 🖌 New / 🗌 Redevelopment	(213) 479-7521 Phone:				
• Res Comm Indus. Mixed Use	Address:				
• Other:	Los Angeles, 90029				
Hillside Grading: Y M ESA: Y					
Liquefaction: V					
Percolation test done: Y					
Project Information					
Total site area (Ac): De	sign Storm (85 <sup>th</sup> Percentile):				
Approx Impervious area (Ac): App	prox Pervious Area (Ac): 0.144				
<b>Note:</b> The information on this City Planning Case Referral Form is only a "preliminary review" by LA Sanitation. It informs the applicant of the stormwater requirements that will need to be implemented on the project in order to satisfy Low Impact Development (LID) requirements.					
Possible BMP	Sanitation Plan Checker				
(Subject to Soils testing and Site conditions)					
	Reviewer: S. Garcia				
Infiltration: Y N Capture & Use: Y N	Date Reviewed: <u>8/1/2023</u>				
Bio-Filtration: <b>V</b> N					
Comment(s):					
Site is in a liquefaction area therefore infiltration is infeasible. Provide City of LA LID Handbook Appendix					
F calculation for Capture and Use. If infeasible provide bio	Dilitration BMP per the requirements of the LID Handbook.				

Service Interval #1:	Service Interval #2:
Qualifier #2:	
Service Interval #1:	
Service Intervals are calculated by dividing 420 7 pm by the number of eligible trips.	(the total number of minutes during the peak hours of 6 am to 9 am and 3 pm to
Notes:	
Notes:	

### THIS SECTION TO BE COMPLETED BY THE APPLICANT

### **Applicant Requesting:**

100% Affordable per AB 2345 <sup>1</sup>		□ SB 35	🗆 ED 1
☐ Measure JJJ	□ AB 2097	□ AB 2162	□ AB 2334
☐ Other:			

### **APPLICANT INFORMATION**

Applicant Name: Gary Benjamin, Alchemy Planning + Land Use	
Phone Number: (213) 479-7521	
Email: gary@alchemyplanning.com	

### I. PROPOSED PROJECT

### 1. PROJECT LOCATION/ZONING

Project Address(es): 1531-1535 S. Sawtelle Blvd., Los Angeles, CA 90025

### Assessor Parcel Number(s): <u>4261-005-008</u>

<sup>1</sup> AB 1763 incentives were amended by AB 2345 (2020) per Government Code Section 65915(b)(1)(G).

Community Plan: West Los Angeles				
Existing Zone: [Q]C2-1				
Land Use Designation: Neighborhood Commercial				
Number of Parcels: 2				
Project Site Area (sf): 7,029 sf.				
<b>ED 1 Eligible</b> <sup>2</sup>	□ Specific Plan			
	Enterprise Zone	Redevelopment Project Area		
If applicable, specify Specific Plan/Overlay:				
☑ Q Condition/D Limitation (Ordinance No. and provide a copy): Ord. 166,331-SA185				
Other Pertinent Zoning Information (specify):				

### 2. DETAILED DESCRIPTION OF PROPOSED PROJECT

Demolition of the existing commercial structure and construction of a new 15,972 sf., five-story, 56' apartment building with nine dwelling units, including one 4BR unit, five 5BR units, and three 6BR units, with one VLI unit, and 1,575 sf. of open space.

### 3. DETAILED DESCRIPTION OF EXISTING SITE AND DEVELOPMENT

7,029 sf. lot with a 2,500 sf. retail building, c. 1915.

<sup>&</sup>lt;sup>2</sup> Refer to Executive Directive 1 Implementation Guidelines for qualifying criteria. If the project is determined to be ineligible for ED 1, a new Referral Form will need to be obtained.

Existing Uses Dwelling Unit (DU) Square Footage (SF)	Existing No. of DUs or Non-Residential SF	Existing No. of DUs or Non-Residential SF to be Demolished	Proposed <sup>3</sup> No. of DUs or Non-Residential SF
Guestrooms	0	0	0
Studio	0	0	0
One Bedroom	0	0	0
Two Bedrooms	0	0	0
Three Bedrooms	0	0	0
4+Bedrooms	0	0	9
Non-Residential SF	2,500 sf.	2,500 sf.	0 sf.
Other	0	0	0

#### 4. APPLICATION TYPE

Density Bonus with **Off-Menu Incentives** (specify):

1) Reduce required parking from 18 spaces to 0 spaces.

2) Increase FAR from 1.5 to 3.25.

Reduction in the north side yard setback to allow 5 feet in lieu of the required 8 foot setback.

Reduction in the south side yard setback to allow 5 feet in lieu of the required 8 foot setback.

Per AB 2556, replacement units shall be equivalent to the number of units and number of bedrooms of the existing development.

- Density Bonus with **Waivers of Development Standards** (specify):
  - 1) 11' height increase from 45' to 56'.
  - 2) North side yard reduction from 8' to 5'.
  - 3) South side yard reduction from 8' to 5'.
  - 4) Increase in the Floor Area Ratio (FAR) to 3.25:1 in lieu of 1.5:1
- Greater Downtown Housing Incentive Area per LAMC Section 12.22 A.29
- □ Affordable Housing per LAMC Section 11.5.11 (Measure JJJ)
- □ Public Benefit Project per LAMC Section 14.00 A.2
- General Plan Amendment per LAMC Section 11.5.6
  - Request: \_\_\_\_\_
- □ Zone/Height District Change per LAMC Section 12.32

#### Request: \_\_\_\_\_

- □ Conditional Use per LAMC Section 12.24 U.26
- □ Specific Plan Project Permit Compliance per LAMC Section 11.5.7 C
- Community Design Overlay per LAMC Section 13.08
- □ Coastal Development Permit per LAMC Section 12.20.2 or 12.20.2.1
- □ Tract or Parcel Map per LAMC Section 17.00 or 17.50
- Other (specify): \_\_\_\_\_

#### 5. ENVIRONMENTAL REVIEW

- Project is Exempt<sup>4</sup>
- ☑ Not Yet Filed
- Filed (Case No.):

<sup>4</sup> Project may be exempt from CEQA review if it qualifies for a CEQA Exemption or is a Ministerial Project (aka, "By Right").

#### 6. HOUSING DEVELOPMENT PROJECT TYPE

#### CHECK ALL THAT APPLY:

⊠ For Rent	□ For Sale	☐ Mixed-Use Project	□ Residential Hotel			
Extremely Low Income	⊠ Very Low Income	□ Low Income	□ Moderate Income			
⊠ Market Rate	□ Supportive Housing	□ Senior				
□ Shared Housing Build	□ Shared Housing Building per AB 682					
□ Special Needs (describe):						
☐ Other Category (describe):						

#### 7. DENSITY CALCULATION

#### A. Base Density: Maximum density allowable per zoning<sup>5</sup>

	Lot size (including any ½ of alleys) <sup>6</sup>	7,029	_SF (a)
	Density allowed by Zone	800	_SF of lot area per DU (b)
	Density allowed by General Plan	400	_
	No. of DUs allowed by right (per LAMC)	8	_ DUs (c) [c = a/b, round down to whole number]
	No. of Guestrooms allowed per AB 682	0	_
	Base Density	9	_DUs (d) [d = a/b, round up to whole number]
В.	Maximum Allowable Density Bonus <sup>7, 8</sup>	13	_ DUs (e) [e = dx1.35, round up to whole number]

<sup>6</sup> If there is a related subdivision case, the lot area shall be calculated based on the site area after a dedication of land has been provided.

- <sup>7</sup> Per AB 2345, 100% affordable housing developments may request an 80% density increase or unlimited density if the project site is within 0.5 miles of a Major Transit Stop or in a Very Low Vehicle Travel Area (see ZIMAS). In addition, a property located in the Hollywood Redevelopment Plan Area is eligible for a 50% density bonus pursuant to Government Code Section 65915(f), as described in the November 2, 2022 AB 2345 Memo.
- <sup>8</sup> Per AB 2334, a Very Low Vehicle Travel Area are defined by Government Code Section 65915(o)(4), as an urbanized area "where the existing residential development generates vehicle miles traveled (VMT) per capita that is below 85 percent of either regional vehicle miles traveled per capita or city vehicle miles traveled per capita.

<sup>□</sup> AB 2345 - Unlimited Density

<sup>&</sup>lt;sup>5</sup> As defined by Government Code Section 65915(o)(7), which states that "maximum allowable residential density" or "base density" means the maximum number of units allowed under the zoning ordinance, specific plan, or land use element of the general plan, or, if a range of density is permitted applicable to the project. If the density allowed under the zoning ordinance is inconsistent with the density allowed under the land use element of the general plan or specific plan, the greater shall prevail.

**C. Proposed Project:** Please indicate total number of DUs requested and break down by levels of affordability set by each category (California Department of Housing and Community Development [HCD] or United States Department of Housing and Urban Development [HUD]). For information on HCD and HUD levels of affordability please contact LAHD at <a href="https://housing.lacity.org/partners/land-use-rent-income-schedules">https://housing.lacity.org/partners/land-use-rent-income-schedules</a>.

Total	HCD (State) HUD (TCAC)
-	N/AN/A
0	N/AN/A
1	1
	N/AN/A
9	(f)
1	(g)
1	(h) [If f>c, then h=f-c; if f <c, h="0]&lt;/td" then=""></c,>
0%	(i) {i = 100 x [(f/d) – 1]} (round down)
11%	(j) [g/d, round down to a whole number]
	8 0 1

<sup>9</sup> Properties proposing 16 units or more need to provide a manager's unit per 25 CCR § 42.

#### 8. SITE PLAN REVIEW CALCULATION

An application for Site Plan Review (SPR) may be required for projects that meet any of the SPR thresholds as outlined in LAMC Section 16.05 C, unless otherwise exempted per LAMC Section 16.05 D. For Density Bonus projects involving bonus units, please use the formula provided below to determine if the project meets the SPR threshold for unit count. If the project meets the threshold(s) but qualifies under the exemption criteria per Section 16.05 D, please confirm the exemption with City Planning's DSC AHSS.

<u>8</u> units allowed by right (permitted by LAMC) – <u>0</u> existing units = <u>8</u> units

#### ☐ YES, SPR is required.

Proposed by-right units minus existing units is equal to or greater than 50<sup>10</sup>

 $\boxtimes$  NO, SPR is not required.

Base Density units minus existing units is less than 50

Exempt.

Specify reason: \_\_\_\_\_

#### **II. DENSITY BONUS (LAMC SECTION 12.22 A.25, ORDINANCE NO. 179,681)**

#### 9. PARKING OPTIONS

#### CHECK ALL THAT APPLY:

Automobile Parking Reductions via Bicycle Parking for Residential Uses<sup>11</sup>. Choose only one of the options, if applicable:

⊠ 10%

□ 15% (Only for residential projects or buildings located within 1,500 feet of a Major Transit Stop)

□ 30% (If selecting the 30% parking reduction, the project will be ineligible for any of the Parking Options listed below)

If selecting the 30% parking reduction, provide the following information:

#### Required Parking per LAMC: \_\_\_\_\_

Required Parking after the 30% reduction:

<sup>10</sup> Site Plan Review may also be required if other characteristics of the project exceeds the thresholds listed in LAMC Section 16.05.

<sup>11</sup> Any project utilizing Parking Option 3 may not further reduce automobile parking via bicycle parking.

#### □ Automobile Parking for Residential Uses (choose only one of the following options):

Note: Any fractional numbers are rounded up.

□ **Parking Option 1.** Based on # of bedrooms, inclusive of Handicapped and Guest parking.

	# of DUs	Spaces/DU	Parking Required	Parking Provided
0-1 Bedroom		1		
2-3 Bedrooms		1.5		
4 or more Bedrooms		2.5		
Stalls Reduced via Bike Parking				Subtract:
TOTALS				

□ **Parking Option 2.** Reduced <u>only</u> for Restricted Affordable Units and up to 40% of required parking for Restricted Affordable Units may be compact stalls.

	# of DUs	Spaces/DU	Parking Required	Parking Provided
Market Rate (Including Senior Market Rate)		Per Code		
Restricted Affordable		1		
VLI/LI Senior or Disabled		0.5		
Restricted Affordable in Residential Hotel		2.5		
Stalls Reduced via Bike Parking				Subtract:
TOTALS				

□ Parking Option 3 [AB 2345 (2020)]. Applies to two types of projects:

- 100% affordable housing developments consisting solely of affordable units, exclusive of a manager's unit(s), with an affordable housing cost to lower income families; or
- Mixed-income developments consisting of 11% VLI or 20% LI units.
- □ **100% Affordable Housing Developments.**<sup>12</sup> There is no minimum parking requirement for any of the following 100% affordable housing developments described below. Check all that apply:

□ A housing development located within 0.5 miles of a Major Transit Stop.

<sup>12</sup> As defined by Government Code Section 65915(b)(1)(G)

- □ A housing development for individuals who are 55 years of age or older with either paratransit service or unobstructed access, within 0.5 miles to a fixed bus route that operates at least eight times per day.<sup>13</sup>
- □ Special Needs Housing Development, as defined in Section 51312 of the Health and Safety Code (H&SC), with either paratransit service or unobstructed access, within 0.5 miles to a fixed bus route that operates at least eight times per day.

#### □ Supportive Housing Development

□ **Mixed-Income Developments** consisting of 11% VLI or 20% LI units.

	Spaces/Unit	Parking Required	Parking Provided
Located within 0.5 miles of Major Transit Stop with unobstructed access to project	0.5		

**Major Transit Stop** is defined as a site containing an existing rail or bus rapid transit station, a ferry terminal served by either a bus or rail transit service, or the intersection of two or more major bus routes with a frequency of service interval of 15 minutes or less during the morning and afternoon peak commute periods. It also includes major transit stops that are included in the applicable regional transportation plan.

**Bus Rapid Transit** is defined as public mass transit service provided by a public agency or by a public-private partnership that includes all of the following features:

- 1) Full-time dedicated bus lanes or operation in a separate right-of-way dedicated for public transportation with a frequency of service interval of 15 minutes or less during the morning and afternoon peak commute periods
- 2) Transit signal priority
- 3) All-door boarding
- 4) Fare collection system that promotes efficiency
- 5) Defined stations

Parking Option 4 [AB 2097 2022]. No minimum automobile parking requirement on any residential, commercial, or other development project that is within one-half mile of a Major Transit Stop.<sup>14</sup>

<sup>14</sup> Parking reductions do not apply to a hotel, motel, bed and breakfast inn or other transient lodging except where a portion of a housing development project is designated for use as a residential hotel, as defined in Section 50519 of the Health and Safety Code. Moreover, reductions do not apply to an event center or commercial parking in a contractual agreement executed before January 1, 2023.

<sup>&</sup>lt;sup>13</sup> AB 2334 aligned the resident age requirement from 62 years of age to 55 years of age for 100 percent affordable housing developments seeking a parking waiver under Section 65915(p)(3)(B).

#### **10. INCENTIVES**

#### A. Qualification for Incentives

Below is the minimum Required Restricted Affordable Housing Units, calculated as a percentage of the base density allowed on the date of the application.

Incentives	% Very Low Income	% Low Income	% Moderate Income
One	□ 5% to <10%	□ 10% to <20%	□ 10% to <20%
Тwo	⊠ 10% to <15%	□ 20% to <30%	□ 20% to <30%
Three	□ 15% or greater	□ 30% or greater	□ 30% or greater

Note: To utilize AB 682, at least 10% Low or 5% Very Low Income of the base units shall be provided.

- 100% Affordable Housing Developments may request up to four (4) incentives and one
   (1) Waiver of Development Standard. Check this box if this applies to the project.
- **B. Project Zoning Compliance & Incentives** (Only for projects requesting a Density Bonus with Incentives/Waivers)

	Permitted w/o Incentives	Proposed per Incentives	On-Menu	Off-Menu	Waivers
X Yard/Setback (each yard	counts as one inc	entive)			
□ Front (1)					
Front (2)					
🗵 Side (1)		5'		x	X
⊠ Side (2)	8'	5'		X	×
Rear					
□ Lot Coverage					
□ Lot Width					
I Floor Area Ratio <sup>15</sup>	1.5	3.25		X	X
☑ Overall Height/Stories <sup>16</sup>	45'	56'			X
☐ Transitional Height(s)					
Open Space					
Density Calculation					
□ Averaging (all count as o	ne incentive — che	eck all that are nee	ded)		
□ FAR □ Density	/ 🗌 Parking	g 🛛 🗍 Open S	Space	Vehicular	Access

<sup>15</sup> See LAMC Section 12.22 A.25(f)(4) for additional requirements.

<sup>16</sup> See LAMC Section 12.22 A.25(f)(5) for additional requirements.

☑ Other Off-Menu Incentives (specify): <u>Parking reduction</u> from 18 spaces to 0 spaces.

Waiver of Development Standards (spe	cify):		
100% Affordable Housing Development stories up to 33 additional feet. Check the stories up to 33 additional feet.		0	ional
TOTAL No. of Incentives Requested:	On-Menu _	Off-Menu	2
TOTAL No. of Waivers Requested: <u>3</u>	2 Waivers	of Development Standards	

#### **11. COVENANT**

All Density Bonus projects are required to prepare and record an Affordability Covenant to the satisfaction of the LAHD's Occupancy Monitoring Unit <u>before</u> a building permit can be issued. For more information, please contact the LAHD at <u>lahd-landuse@lacity.org</u>.

#### III. GREATER DOWNTOWN HOUSING INCENTIVE AREA (LAMC SEC. 12.22 A.29, ORDINANCE NO. 179,076)

#### **12. GREATER DOWNTOWN HOUSING INCENTIVE AREA (GDHIA)**

#### A. Eligibility for Floor Area Bonus

NOTE: The affordability levels required are set by the HUD/TCAC. For information on HCD and HUD levels of affordability please contact the LAHD at lahd-landuse@lacity.org.

- $\Box$  5% of the total number of DUs provided for VLI households; and
- $\hfill\square$  One of the following shall be provided:
  - $\hfill\square$  10% of the total number of DUs for LI households; or
  - $\hfill\square$  15% of the total number of DUs for Moderate Income households; or
  - $\square$  20% of the total number of DUs for Workforce Income households, and
- Any DU or Guestroom occupied by a household earning less than 50% of the Area Median Income (AMI) that is demolished or otherwise eliminated shall be replaced on a one-for-one basis within the Community Plan area in which it is located

#### **B. INCENTIVES**

NOTE: Must meet all three (3) eligibility requirements from 12.A above and provide a Covenant & Agreement (See #11).

#### CHECK ALL THAT APPLY:

- □ A 35% increase in total floor area
- Open Space requirement pursuant to LAMC Section 12.21 G reduced by one-half, provided that a fee equivalent to amount of the relevant park fee, pursuant to LAMC Section 19.17, shall be paid for all dwelling units. See LAMC Section 12.29 A.29(c) for exceptions
- □ No parking required for units for households earning less than 50% AMI
- $\Box$  No more than one parking space required for each dwelling unit

#### C. Additional Incentives to Produce Housing in the GDHIA

- □ No yard requirements except as required by the Urban Design Standards and Guidelines
- □ Buildable area shall be the same as the lot area (for the purpose of calculating buildable area for residential and mixed-use)
- □ Maximum number of dwelling units or guestrooms permitted shall not be limited by the lot area provisions, as long as the total floor area utilized by guestrooms does not exceed the total floor area utilized by dwelling units
- □ No prescribed percentage of the required open space that must be provided as either common open space or private open space

#### **IV. MEASURE JJJ<sup>17</sup> (LAMC Sec. 11.5.11, Ordinance No. 184, 745)**

#### **13. AFFORDABLE REQUIREMENTS**

A certain percentage of affordable units is required based on the total number of units in the project. **Fill out either A or B below:** 

#### A. Rental Projects

No less than the affordability percentage corresponding to the level of density increase requested or allowed:

□ % VLI <b>OR</b>		% LI
-------------------	--	------

□ For projects requesting a General Plan Amendment, Zone Change, and/or Height District Change that results in an increased allowable density greater than 35%:

5% ELI	AND	6% VLI	OR	L 15	% LI	
For projects req	luesting a Gen	eral Plan Amendme	nt, Zone Char	ige, and	d/or Height D	District
Change that res	sults in an incre	eased allowable den	sitv areater th	an 35%		

-				
🗌 5% ELI	AND	🗌 11% VLI	OR	🗌 20% LI

<sup>17</sup> All fractional amounts in Sections 13 and 14 shall be rounded up to the next whole number.

	Required Number	r of Affordable	Units		
	ELI	VLI	LI	_	
В.	For Sale Projects				
	□ No less than the requested or all	• •	ercentage correspon	ding to the I	evel of density increase
	•		🗆% LI	OR	□% Moderate Income
	• •	sults in an increa	ased allowable dens		nge, and/or Height District nan 35% or allows a residential
	🗌 11% VLI	OR	🗌 20% LI	OR	☐ 40% Moderate Income
	Required Number	r of Affordable	Units		
	VLI	LI	Moderate Incom	e	
1/					
				· · /	options available to comply with vise leave this section blank.
Α.	Off-Site Construc	<b>tion –</b> Construc	ction of affordable un	its at the fol	lowing rate:
	□ Within 0.5 miles	s of the outer ec	lge of the Project, Af	fordable Uni	its in Section 13 x 1.0
	$\Box$ Within 2 miles of	of the outer edg	e of the Project, Affo	rdable Units	in Section 13 x 1.25
	$\Box$ Within 3 miles of	of the outer edg	e of the Project, Affo	rdable Units	in Section 13 x 1.5
	Updated Require	d Number of A	ffordable Units		
	ELI	VLI	LI	_ Moderat	e Income
В.	Off-Site Acquisiti	<b>on</b> – Acquisitior	of property that will	provide affo	rdable units at the following rate:
	□ Within 0.5 miles	s of the outer ec	lge of the Project, Af	fordable Uni	its in Section 13 x 1.0
	□ Within 1 mile of	the outer edge	of the Project, Afford	dable Units i	n Section 13 x 1.25
	□ Within 2 miles o	of the outer edg	e of the Project, Affo	rdable Units	in Section 13 x 1.5
	Updated Require	d Number of A	ffordable Units		
	ELI	VLI	LI	_ Moderat	e Income
C.	In-Lieu Fee – Fror	n the Affordabili	ty Gaps Study publis	shed by the	Los Angeles City Planning
	Total In-Lieu Fee		(Note: Fir	nal fee TBD	if/when the project is approved)

#### **15. DEVELOPER INCENTIVES**

Please describe up to a maximum of three (3) incentives:

1)_	1)	
2)	2)	
_		
3) _	3)	

Disclaimer: This review is based on the information and plans provided by the applicant at the time of submittal of this form. Applicants are advised to verify any zoning issues such as height, parking, setback, and any other applicable zoning requirements with LADBS.

#### TRANSPORTATION STUDY ASSESSMENT Department of Transportation



#### PURPOSE

The Department of Transportation (LADOT) Referral Form (hereafter referred to as Referral Form) serves as an initial assessment to determine whether a project requires a Transportation Assessment. A Planning case must be filed with Los Angeles City Planning <u>prior</u> to submitting this Referral Form to LADOT.

#### **GENERAL INFORMATION**

- All new school projects, <u>including by-right projects</u>, must contact LADOT for an assessment of the school's proposed drop-off/pick-up scheme and to determine if any traffic controls, school warning and speed limit signs, school crosswalk and pavement markings, passenger loading zones and school bus loading zones are needed.
- Unless exempted, projects located within a Transportation Specific Plan area <u>may be required</u> to pay a traffic impact assessment fee, regardless of the need to prepare a Transportation Assessment.
- Pursuant to LAMC Section 19.15 of Chapter 1, a review fee payable to LADOT may be required to process this form. The applicant should contact the appropriate <u>LADOT Development Services</u> <u>Office</u> to arrange payment.
- LADOT's Vehicle Miles Traveled (VMT), VMT Calculator, and VMT Calculator User Guide can be found at <a href="http://ladot.lacity.org">http://ladot.lacity.org</a>.
- A transportation study is not needed for the following project applications:
  - Ministerial / by-right projects
  - Discretionary projects limited to a request for change in hours of operation
  - Tenant improvements within an existing shopping center for change of tenants
  - Any project only installing a parking lot or parking structure
  - Time extension
  - Single-family home (unless part of a subdivision)
- This Referral Form is not intended to address the project's site access plan, driveway dimensions and location, internal circulation elements, dedication and widening, and other issues. These items require separate review and approval by LADOT.

#### SUBMITTAL REQUIREMENTS

When submitting this Referral Form to LADOT, complete and include a copy of the documents listed below:

- ⊠ City Planning Application (CP13-7771.1)
- A fully dimensioned Site Plan showing all existing and proposed structures, parking and loading areas, driveways, as well as on-site and off-site circulation
- If filing for purposes of Project Review, the Project Review Supplemental Application (CP13-2150)
- Project-specific VMT Calculator analysis results
- Route this Referral Form for processing to the appropriate <u>LADOT Development Services Office</u> as follows (see this <u>map</u> for geographical reference):

#### LADOT DEVELOPMENT SERVICES DIVISION OFFICES

Metro	West LA	Valley
100 S. Main St, 9th Floor	7166 W. Manchester Blvd	6262 Van Nuys Blvd, 3rd Floor
Los Angeles, CA 90012	Los Angeles, CA 90045	Van Nuys, CA 91401
ladot.devreview.cen@lacity.org	ladot.devreview.wla@lacity.org	ladot.devreview.sfv@lacity.org

#### THIS SECTION TO BE COMPLETED BY APPLICANT

#### **PROJECT INFORMATION**

Case Number: CPC-2023-5657-DB-VHCA								
	Address: 1531-1533 S. Sawtelle Blvd., Los Angeles, CA 90025							
Project Description:	of new 9-unit apar	tment buildi	ng with1 VLI unit.					
Seeking Existing Use Credit (will be calculated by LADOT):	🔀 YES							
Applicant Name: Gary Benjamin, Alchemy Planning +	- Land Use							
Email: gary@alchemyplanning.com								
Phone: (213) 479-7521								

#### PROJECT REFERRAL TABLE

	Land Use (list all)	Size/Unit	Daily Trips <sup>1</sup>
	Multifamily apartments	8	
Proposed <sup>1</sup>	Affordable multifamily apartment	1	
		Total Trips <sup>1</sup> :	39

#### THIS SECTION TO BE COMPLETED BY PLANNING STAFF ONLY

### Planning Staff Name: Isaiah Ross

Phone: 213	8-238-7731			
Signature: _		Digitally signed by Isaiah Ross Date: 2024.01.29 07:38:51 -08'00'	_ Date: <u>1/29/24</u>	

a.	Does the proposed project involve a discretionary action?	🛛 YES	
b.	Would the proposed project generate 250 or more daily vehicle trips <sup>2</sup> ?		🛛 NO
C.	If the project is replacing an existing number of residential units with a smaller number of residential units, is the proposed project located within		🗵 NO

If **YES** to **a.** and **b.** or **c.**, or to **all** of the above, the Project <u>must</u> be referred to LADOT for further assessment.

one-half mile of a heavy rail, light rail, or bus rapid transit station<sup>3</sup>?

<sup>&</sup>lt;sup>1</sup> Qualifying Existing Use to be determined by LADOT staff on following page, per LADOT's TAG.

<sup>&</sup>lt;sup>2</sup> To calculate the project's total daily trips, use the VMT Calculator. Under "Project Information", enter the project address, land use type, and intensity of all proposed land uses. Select the '+' icon to enter each land use. After you enter the information, copy the 'Daily Vehicle Trips' number into the total trips in this table. Do not consider any existing use information for screening purposes. For additional questions, consult LADOT's <u>VMT Calculator User Guide</u> and the LADOT TAG (available on the LADOT website).

<sup>&</sup>lt;sup>3</sup> Relevant transit lines include Metro Red, Purple, Blue, Green, Gold, Expo, Orange, and Silver line stations; and Metrolink stations.

#### THIS SECTION TO BE COMPLETED BY LADOT

#### **PROJECT COMPONENTS**

	Land Use (list all)	Size/Unit	Daily Trips
	Multi-Family	8 DU	
Proposed	Affordable Housing - Family	1 DU	
		Total Trips:	39
	General Retail	2.5 KSF	
Existing			
		Total Trips:	-82
	Net Increase / Decrease (+ or - )		-43

a.	Is the project a single retail use that is less than 50,000 square feet?	🗵 NO
b.	Would the project generate a net increase of 250 or more daily vehicle trips?	🗵 NO
C.	Would the project generate a net increase of 500 or more daily vehicle trips?	🗵 NO
d.	Would the project result in a net increase in daily VMT?	🛛 NO
e.	If the project is replacing an existing number of residential units with a smaller number of residential units, is the proposed project located within one-half mile of a heavy rail, light rail, or bus rapid transit station?	⊠ NO
f.	Does the project trigger Project Review (LAMC Section 16.05 of Chapter 1)?	🗵 NO
g.	Project size:	 
	i. Would the project generate a net increase of 1,000 or more daily vehicle trips?	🗵 NO
	ii. Is the project's frontage 250 linear feet or more along a street classified as an Avenue or Boulevard per the City's General Plan?	⊠ NO
	iii. Is the project's building frontage encompassing an entire block along a street classified as an Avenue or Boulevard per the City's General Plan?	× NO

#### **VMT ANALYSIS (CEQA REVIEW)**

If YES to a. and NO to e. a VMT analysis is NOT required.

If **YES** to both **b**. and **d**.; <u>or</u> to **e**. a VMT analysis **is** required.

#### ACCESS, SAFETY, AND CIRCULATION ASSESSMENT (CORRECTIVE CONDITIONS)

If YES to c., a project access, safety, and circulation evaluation may be required.

If YES to f. and either g.i., g.ii., or g.iii., an access assessment may be required.

#### LADOT COMMENTS:

The project has provided valid proof of previous LU (Retail) operation and occupancy up to 9/302022. The project will not be providing any access driveways or curb cuts as it is a zero-vehicle parking project utilizing an off-menu incentive reduction.

Please note that this form is not intended to address the project's site access plan, driveway dimensions and location, internal circulation elements, dedication and widening, and other issues. These items require separate review and approval by LADOT. Qualifying Existing Use to be determined per LADOT's TAG.

#### LADOT ASSESSMENT QUESTIONS

Specific Plan with Trip Fee or TDM Requirements: (WLA TIMP SP)	🛛 YES	□ NO
Fee Calculation Estimate: <u>NONE (Negative Generator)</u>		
VMT Analysis Required:		⊠ NO
Access, Safety, and Circulation Evaluation Required:		⊠ NO
Access Assessment Required:		🛛 NO
Prepared by DOT Staff Name: Pedro B. Ayala	Phone: <u>(</u> 213) 485-10	62
Signature: Pedro B. Ayala	Date: 4/15/24: Mor	

### **CITY OF LOS ANGELES VMT CALCULATOR Version 1.4**



### Project Screening Criteria: Is this project required to conduct a vehicle miles traveled analysis?

	Project Information	Existing	Lan	d Use			
Project:		Land Use Type		V	alue	Unit	
Scenario:	www	Retail   General Retail	-	2.5		ksf	•
		Retail   General Retail		2.5	ksf		
Address:							
	VENTURA BUT CONTRACTOR CONTRACTON CONTRACTON CONTRACTON CONTRACTON CONTR	Click here to add a single custom land u Proposed Pro					list)
		Land Use Type		V	alue	Unit	
		Housing   Affordable Housing - Family Housing   Multi-Family	-	1	DU	DU	•
		Housing   Affordable Housing - Family		1	DU		
Is the pr	oject replacing an existing number of						
resident	ial units with a smaller number of						
resident	ial units AND is located within one-half						
mile of a station?	a fixed-rail or fixed-guideway transit						
	• Yes • No	Click here to add a single surtem land (		. (	من ادماد	dha ahaaa	1:-4)

Click here to add a single custom land use type (will be included in the above list

#### **Project Screening Summary**

Existing Land Use	Proposed Project			
82	39			
Daily Vehicle Trips	Daily Vehicle Trips			
619	245			
Daily VMT	Daily VMT			
Tier 1 Scree	ning Criteria			
	Project will have less residential units compared to existing residential units & is within one-half in mile of a fixed-rail station.			
Tier 2 Screening Criteria				
The net increase in daily tr	The net increase in daily trips < 250 trips -43 Net Daily Trips			
The net increase in daily V	MT ≤ 0 -374 Net Daily VMT			
The proposed project cons land uses ≤ 50,000 square				
The proposed project is not required to perform VMT analysis.				

Measuring the Miles

Ann Sewill, General Manager Tricia Keane, Executive Officer

Daniel Huynh, Assistant General Manager Anna E. Ortega, Assistant General Manager Luz C. Santiago, Assistant General Manager City of Los Angeles



LOS ANGELES HOUSING DEPARTMENT 1200 West 7th Street, 9th Floor Los Angeles, CA 90017 Tel: 213.928.9071

housing.lacity.org

#### Eric Garcetti, Mayor

DATE: November 15, 2022

TO: 1531 Sawtelle Blvd LLC, a California Limited Liability Company, Owner

FROM: Marites Cunanan, Senior Management Analyst II Los Angeles Housing Department

# SUBJECT:Housing Crisis Act of 2019 (SB 8)<br/>(TOC) Replacement Unit Determination<br/>RE: 1531 - 1535 South Sawtelle Blvd, Los Angeles, CA 90025

Based on the SB 8 Application for a Replacement Unit Determination (RUD) submitted by 1531 Sawtelle Blvd LLC, a California Limited Liability Company (Owner) for the above-referenced property located at 1531 - 1535 S. Sawtelle Blvd (APN 4261-005-008, Lot7) (Property), the Los Angeles Housing Department (LAHD) has determined that no units are subject to replacement pursuant to the requirements of the Housing Crisis Act of 2019 (SB 8). No dwelling unit(s) exist/existed on the property during the five (5)-year lookback period.

#### **PROJECT SITE REQUIREMENTS:**

The Housing Crisis Act of 2019, as amended by SB 8 (California Government Code Section 66300 et seq.), prohibits the approval of any proposed housing development project ("Project") on a site ("Property") that will require demolition of existing dwelling units or occupied or vacant "Protected Units" unless the Project replaces those units as specified below. The replacement requirements below apply to the following projects:

- Discretionary Housing Development Projects that receive a final approval from Los Angeles City Planning (LACP) on or after January 1, 2022,
- Ministerial On-Menu Density Bonus, SB 35 and AB 2162 Housing Development Projects that submit an application to LACP on or after January 1, 2022, and
- Ministerial Housing Development Projects that submit a complete set of plans to the Los Angeles Department of Building & Safety (LADBS) for Plan Check and permit on or after January 1, 2022.

#### Replacement of Existing Dwelling Units

The Project shall provide at least as many residential dwelling units as the greatest number of residential dwelling units that existed on the Property within the past 5 years.

#### Replacement of Existing or Demolished Protected Units

The Project must also replace all existing or demolished "Protected Units". Protected Units are those residential dwelling units on the Property that are, or were, within the 5 years prior to the owner's application for a SB 8 Replacement Unit Determination (SB 8 RUD): (1) subject to a recorded covenant, ordinance, or law that restricts rents to levels affordable to persons and families of lower or very low income, (2) subject to any form of rent or price control through a public entity's valid exercise of its police power within the 5 past years (3) occupied by lower or very low income households (an affordable Protected Unit), or (4) that were withdrawn from rent or lease per the Ellis Act, within the past 10 years.

Whether a unit qualifies as an affordable Protected Unit, is primarily measured by the INCOME level of the occupants (i.e. W-2 forms, tax return, pay stubs, etc.). The Los Angeles Housing Department (LAHD) will send requests for information to each occupant of the existing project. Requests for information can take two (2) or more

#### SB 8 (TOC) Determination: 1531 - 1535 S. Sawtelle Blvd Page 2

weeks to be returned. It is the owner's responsibility to work with the occupants to ensure that the requested information is timely produced.

• In the absence of occupant income documentation: Affordability will default to the percentage of extremely low, very low or low income renters in the jurisdiction as shown in the latest HUD Comprehensive Housing Affordability Strategy (CHAS) database, which as of September 1, 2022 is at 33% extremely low income, 18% very low income and 19% low income for Transit Oriented Communities (TOC) projects and 51% very low income and 19% low income for Density Bonus projects. In the absence of specific entitlements, the affordability will default to 51% very low income and 19% low income. The remaining 30% of the units are presumed above-low income. All replacement calculations resulting in fractional units shall be rounded up to the next whole number.

### Replacement of Protected Units Subject to the Rent Stabilization Ordinance (RSO), Last Occupied by Persons or Families at Moderate Income or Above

The City has the option to require that the Project provide: (1) replacement units affordable to low income households for a period of 55 years (rental units subject to a recorded covenant), OR (2) require the units to be replaced in compliance with the RSO.

#### Relocation, Right to Return, Right to Remain:

All occupants of Protected Units (as defined in California Government Code Section 66300(d)(2)(F)(vi)) being displaced by the Project have the right to remain in their units until six (6) months before the start of construction activities with proper notice subject to Chapter 16 (Relocation Assistance) of Division 7, Title I of the California Government Code ("Chapter 16"). However, all **Lower Income Household** (as defined in California Health and Safety Code Section 50079.5) occupants of Protected Units are **also** entitled to: (a) Relocation benefits also subject to Chapter 16, and (b) the right of first refusal ("Right to Return") to a comparable unit (same bedroom type) at the completed Project. If at the time of lease up or sale (if applicable) of a comparable unit, a returning occupant remains income eligible for an "affordable rent" (as defined in California Health and Safety Code Section 50052.5), owner must also provide the comparable unit at the "affordable rent" or "affordable housing cost", as applicable. This provision does not apply to: (1) a Project that consists of a Single Family Dwelling Unit on a site where a Single Family Dwelling unit is demolished, and (2) a Project that consists of 100% lower income units except Manager's Unit.

#### THE PROPOSED HOUSING DEVELOPMENT PROJECT:

Per the statement received by LAHD on September 27, 2022, the Owner plans to construct a nine (9)-unit project on the Property pursuant to additional incentives with the Department of City Planning (DCP) under Transit Oriented Communities (TOC) Guidelines.

#### PROPERTY STATUS (AKA THE "PROJECT SITE"):

Owner submitted an Application for a RUD for the Property on September 27, 2022. In order to comply with the required <u>five (5)-year</u> lookback period, LAHD collected and reviewed data from September 2017 to September 2022.

#### **Review of Documents:**

Pursuant to the Grant Deed, the Owner acquired the Property on September 21, 2022.

Department of City Planning (ZIMAS), County Assessor Parcel Information (LUPAMS), DataTree database, Billing Information Management System (BIMS) database, and the Code, Compliance, and Rent Information System (CRIS) database, indicates a use code of "1100 - Commercial - Store - One Story" for the Property (APN 4261-005-008).

Google Earth, Google Street View, and an Internet Search confirm that the Property contains two (2) stores.

SB 8 (TOC) Determination: 1531 - 1535 S. Sawtelle Blvd Page 3

The Los Angeles Department of Building and Safety (LADBS) database indicates that the Owner has not applied for a Demolition Permit or a Building Permit Application.

#### **REPLACEMENT UNIT DETERMINATION:**

LAHD has determined that since at least September 2017, the Property has been single-story stores. The replacement provisions of SB 8 do not apply to commercial properties if there are no residential dwelling unit(s) that exist or have existed on the property for the past five (5) years. Further, this development does not require the demolition of any prohibited types of housing, therefore, no SB 8 replacement affordable units are required.

Please note that this SB 8 determination will also apply if the proposed project is Density Bonus.

#### NOTE: This determination is provisional and is subject to verification by LAHD's Rent Division.

If you have any questions about this RUD, please contact Jessica Wang at jessica.wang@lacity.org.

cc: Los Angeles Housing Department File Planning.PARP@lacity.org, Department of City Planning for discretionary projects, or LADBS.ahs@lacity.org, Department of Building and Safety for by-right projects

MAC:jw



#### PRELIMINARY LAND USE REPORT

(PLANNING CASE REFERRAL FORM (PCRF))

The City of Los Angeles, Bureau of Engineering (BOE) / Department of City Planning (DCP)

This is a Preliminary Land Use Report to provide the applicant with a general understanding of what <u>may</u> be required by BOE for a City Planning Case if, after filing, it is referred to BOE; and what may otherwise be required by BOE per Los Angeles Municipal Code Section 12.37 (Highway and Collector Street Dedication) if the City Planning Case is not referred to BOE.

Part I: To be completed by Applicant		DCP Case Nu	mber (If Available):
Applicant:	Gary Benjamin	Address:	4470 W SUNSET BLVD, STE 547
Phone:	213-479-7521	Email:	LOS ANGELES, CA 90027
Owner:	1531 Sawtelle Blvd LLC	Address:	2905 S. Vermont Ave. #204 Los Angeles, CA 90007
-	<u>1531-1535 S. Sawtelle Blvd.</u> rict: <u>WEST LA</u>	APN:	4261-005-008
	ion (attach ZIMAS Map with highlighte	cel(s)):	

Is there a Tract or Parcel Map being filed in conjunction with this:	NO
If yes; provide Map No	
Has the Tract / Parcel report been prepared and submitted to DCP by BOE:	NO
Will new building(s)/structure(s) be constructed as part of this project:	NO

The Preliminary Land Use Report may be voluntarily filed to provide a general understanding of potential required dedication and improvements on existing streets but is not intended to provide preliminary requirements for a Subdivision (Tract or Parcel Map), Private Street Case, or Street/Alley Vacation. If a Tract/Parcel report has been prepared and submitted to DCP by BOE, please refer to the Tract/Parcel map conditions.

#### Part II: To be Completed by BOE Staff:

Is property within the Hillside Ordinance area (Sections 12.21A17 & 12.21	
C10 of LAMC)?:	NO
Is the property subject to Section 12.37 of the LAMC? :	YES
Is the project in the Historic Overlay Preservation Zone? :	NO
Does the project adjoin a State Highway?	NO
Is the project within 100' of the intersection of the intersection of the building lines of a corner lot?	NO
(Per Section 91.106.4.7.1 of LAMC)	
Is the project within a streetscape area?	NO

The Preliminary Land Use Report does not provide preliminary information for projects subject to the Baseline Hillside Ordinance. (Obtain a Hillside Referral Form from BOE for Hillside Ordinance project requirements.)

#### DEDICATIONS

Street/Alley	Classification	Ex Full R/W	Req Full R/W	Ex Adj.Half R/W	Req Adj. Half R/W	Adjacent Dedication Required	Required under 12.37	Required under a DCP Referred Planning Action
Sawtelle Blvd	Collector	62	66	30	33	3-ft	YES	YES
Alley	Alley	15	20	7.5	10	2.5-ft	NO	YES
							SELECT	SELECT
							SELECT	SELECT
							SELECT	SELECT

Corner	Classification	Dimensions	Required under 12.37	Required under a DCP Referred Planning Action
			SELECT	SELECT

ADDITIONAL NOTES:

Dedicate 3-ft along Sawtelle Blvd. Dedicate 2.5-ft along Alley.

#### **IMPROVEMENTS**

Street/Alley	Classification	Ex Full Roadway	Req Full Roadway	Ex adjacent half Roadway	Required adjacent Half Roadway	Missing Improvements	Exist. Trees	Exist. CB	Potential Widening	Required under 12.37	Required under a DCP Referred Planning Action
Sawtelle Blvd	Collector	40	40	20	20	None	0	6"	None	NO	NO
Alley	Alley	15	20	7.5	10	None	0	0	2.5-ft	NO	YES
										SELECT	SELECT
										SELECT	SELECT
										SELECT	SELECT

Corner	Classification	Provide/ Upgrade Corner Ramp	Required under 12.37	Required under a DCP Referred Planning Action
		SELECT	SELECT	SELECT
		SELECT	SELECT	SELECT
		SELECT	SELECT	SELECT
		SELECT	SELECT	SELECT

Street Trees: If the recommendation for Street Widening is marked "Yes", street tree removals may be required. Street Tree removals must be approved by the Board of Public Works. Applicants shall contact the Urban Forestry Division (UFD) of StreetsLA at (213)-847-3077 before proceeding with the Master Land Use Application. Applicants are also advised to contact Urban Forestry Division (UFD) of Streets LA for proposed driveway location impacting existing street trees.

ADDITIONAL NOTES:

For Alley construct new asphalt pavement to extend to new property line with 2-ft longitudinal gutter.

No widening required along Sawtelle Blvd.

Repair and/or replace any broken or off-grade asphalt, sidewalk (to ADA standards) or curb and gutter. Extend the existing sewer lateral to abut the new property line.

Repairs: In all cases, applicants may be required to close any unused driveways; repair any sidewalks not compliant with ADA requirements, and install/replace public improvements such as driveway aprons and access ramps to meet ADA requirements. In cases referred to BOE by DCP, applicants will also be required to remove and reconstruct broken, off-grade, or bad order concrete curb, gutter, driveways or sidewalks.

Newly Dedicated Areas: In all cases referred by DCP to BOE, applicant may be required to fill in newly dedicated areas with concrete sidewalk, and will be required to remove or obtain Revocable Permit for any encroachments. In cases not referred but subject to L.A.M.C. Section 12.37, where there is existing sidewalk, applicant will have the option to either: fill in newly dedicated areas with concrete sidewalk, obtain revocable permit for existing or new encroachments, or install/retain standard plant materials such as grass.

Other Public Improvements: Planning Cases may also have requirements for Public Improvements determined by Bureau of Street Lighting (BSL), Urban Forestry Division (UFD) of StreetsLA, and Los Angeles Department of Transportation (LADOT)

30 Ft.

YES

#### **SEWERS**

Sewers Exist in the following Ri Enter street names (select from above) NO Sewer easement within the project site? NO Sewer facilities within easements? ADDITIONAL NOTES: Sewer Permit No. 621-27 **STORM DRAINS** Are there storm drain catch basins existing in the right-of-way adjacent to the project site? (Number) 0 NO Storm Drain easement within the project site? NO Storm Drain facilities within easements?

ADDITIONAL NOTES:

#### Does the lot have a legal connection to the sewer? Distance from subject lot to the nearest mainline sewer?

n options provided Sawtelle Blvd	ights-of-Way	Street/R/W	Street/R/W	Street/R/W	Street/R/W
	n options provided	Sawtelle Blvd			

#### ADDITIONAL NOTES (cont.):

NOTE: This is a Preliminary Land Use Report to provide the applicant with a general understanding of what <u>may</u> be required by BOE for a City Planning Case if, after filing, it is referred to BOE; and what may otherwise be required by BOE per Los Angeles Municipal Code Section (LAMC) 12.37 (Highway and Collector Street Dedication) if the City Planning Case is not referred to BOE.

For City Planning Cases, a formal investigation and engineering report may be required, if so determined by the City Planning Department. If so, the Engineering Report will be provided after submittal of all documentation and payment of fees. Measurements and statements contained herein may be adjusted in the Engineering Report.

For cases not referred by City Planning to BOE, requirements of LAMC Section 12.37 may be applicable. To determine requirements of LAMC Section Section 12.37, a formal investigation and engineering report may be required during the Building Permit Plan Check clearance process as applicable. If so, the Highway Dedication ("R3") letter will be provided after submittal of all documentation and payment of fees. Measurements and statements contained herein may be adjusted in the Highway Dedication ("R3") letter. [LAMC Section 12.37 provides for minimum dedication and improvement requirements which do not preclude conditions established by City Planning actions]

Prepared by: <u>Jason Ng</u>

1. Mar.

Date:

Date:

Reviewed by: Nikta Mousavi

 $\sim$ 

PRELIMINARY LAND USE REPORT



PRELIMINARY LAND USE REPORT

TO:

#### CITY OF LOS ANGELES INTER-DEPARTMENTAL CORRESPONDENCE

**DATE:** January 12, 2024

Juliet Oh, Senior City Planner Department of City Planning

**FROM:** Bryan Ramirez, Street Tree Superintendent I Bureau of Street Services, Urban Forestry Division

#### SUBJECT: CPC-2023-5657-DB-VHCA – 1531 S. SAWTELLE BLVD.

In regard to your request for review of this case regarding Urban Forestry requirements, it is our recommendation that:

#### 1. STREET TREES

- a. Project shall preserve all healthy mature street trees whenever possible. All feasible alternatives in project design should be considered and implemented to retain healthy mature street trees. A permit is required for the removal of any street tree and shall be replaced 2:1 as approved by the Board of Public Works and Urban Forestry Division.
- b. Plant street trees at all feasible planting locations within dedicated streets as directed and required by the Bureau of Street Services, Urban Forestry Division. All tree plantings shall be installed to current tree planting standards when the City has previously been paid for tree plantings. The sub divider or contractor shall notify the Urban Forestry Division at: (213) 847-3077 upon completion of construction for tree planting direction and instructions.
- **Note:** Removal of street trees requires approval from the Board of Public Works. All projects must have environmental (CEQA) documents that appropriately address any removal and replacement of street trees. Contact Urban Forestry Division at: (213) 847-3077 for tree removal permit information.

BR:djm



## WLA SAWTELLE NEIGHBORHOOD COUNCIL

WWW.WESTLASAWTELLE.ORG // ADRIANE RANSOM // ALEX CARYOTAKIS // ALEXANDRA POLIN // DANILO TORRO // DAVID SWARTZ // JAMES ALTUNER // JAY HANDAL // KENT KAISAKI // MONICA MEJIA-LAMBERT // PIERRE TECON // RON BEN-YEHUDA // TASCHA FOLSOI // VIC PACHECO //VINCE PEAGLER // WALTON CHIU //

**Council File Number:** 

### City Planning Number: CPC-2023-5657-DB-VHCA

06.26.2024

**PRESENTATION:** Gary Benjamin for Case #: CPC-2023-5657-DB-VHCA at 1531 S. Sawtelle Blvd.

**MOTION:** To approve Case #: CPC-2023-5657-DB-VHCA at 1531 S. Sawtelle Blvd as presented with one abstention

On March 21, 2024, the PLUM Committee voted 3-0-1 to approve with one abstention due to the negative impact that market rate co-living represents to meaningfully affordable, family-sized units in Sawtelle.

The West LA Sawtelle NC Board voted 11-1-1 to approve the motion.

#### CITY OF LOS ANGELES INTER-DEPARTMENTAL CORRESPONDENCE

Date: December 21, 2023

To: Vincent Bertoni, Director Department of City Planning Attn: Kyle Winston (City Planner)

From: Bertram Moklebust, Principal Civil Engineer Permit Case Management Division Bureau of Engineering (BOE)

# Subject: Case Number CPC 2023-5657-DB-VHCA (1531 South Sawtelle Boulevard)

The following recommendations identify the infrastructure deficiencies adjacent to the above-referenced site. These recommendations are respectfully submitted for your consideration in the approval of a Density Bonus and Vesting Housing Crisis Act application:

#### 1. Dedication Required:

**Sawtelle Boulevard** (Collector Street) – A 3-foot wide strip of land along the property frontage to complete a 33-foot wide half right-of-way in accordance with Collector Street standards.

**Alley** (West of Sawtelle Boulevard) – A 2.5-foot wide strip of land along the alley frontage to complete a 10-foot wide half right-of-way.

#### 2. Improvements Required:

**Sawtelle Boulevard** – Construct a new concrete curb, 2-foot gutter and fullwidth concrete sidewalk abutting the new property line. Repair and or replace any broken, damaged/cracked or off-grade roadway pavement along the property frontage.

**Alley** – Remove the alley pavement and construct a new 10-foot wide half alley and a 2-foot wide longitudinal concrete gutter, including any necessary removal and reconstruction of existing improvements.

**Notes:** Broken curb and/or gutter includes segments within existing score lines that are depressed or upraised by more than  $\frac{1}{4}$  inch from the surrounding concrete work or are separated from the main body of the concrete piece by a crack through the entire vertical segment and greater than  $\frac{1}{8}$  inch at the surface of the section.

Non- ADA compliant sidewalk shall include any sidewalk that has a cross slope that exceeds 2% and/or is depressed or upraised by more than <sup>1</sup>/<sub>4</sub> inch from the surrounding concrete work or has full concrete depth cracks that have separations greater than 1/8 inch at the surface. The sidewalk also includes that portion of the pedestrian path of travel across a driveway.

All new sidewalk curb and gutter shall conform to the Bureau of Engineering Standard Plans S410-2, S440-4, S442-6 and S444-0.

Install tree wells with root barriers and plant street trees satisfactory to the City Engineer and the Urban Forestry Division of the Bureau of Street Services. The applicant should contact the Urban Forestry Division for further information (213) 847-3077 or via https://appointments.lacity.org/apptsys/Public/Account.

Department of Transportation may have additional requirements for dedication and improvements.

Refer to the Department of Transportation regarding traffic signals, signs andequipment(213)482-7024orviahttps://appointments.lacity.org/apptsys/Public/Account.

Regarding any conflicts with power pole matters, contact the Department of Water and Power at (213) 367-2715 or via <u>https://appointments.lacity.org/apptsys/Public/Account</u>.

Refer to the Fire Department Hydrants and Access Unit regarding fire hydrants (213) 482-6543 or via https://appointments.lacity.org/apptsys/Public/Account.

- 3. Roof drainage and surface run-off from the property shall be collected and treated at the site and drained to the streets through drain pipes constructed under the sidewalk through curb drains or connection to the catch basins.
- 4. Sewer line exists in Sawtelle Boulevard. Extension of the house connection laterals to the new property line may be required. All Sewerage Facilities Charges and Bonded Sewer Fees are to be paid prior to obtaining a building permit.
- 5. Submit parking area and driveway plan to the West Los Angeles District Office of the Bureau of Engineering and the Department of Transportation for review and approval.

Any questions regarding this report may be directed to Quyen Phan of my staff via quyen.phan@lacity.org.

BOARD OF BUILDING AND SAFETY COMMISSIONERS

JAVIER NUNEZ

ELVIN W. MOON VICE PRESIDENT

JOSELYN GEAGA-ROSENTHAL LAUREL GILLETTE GEORGE HOVAGUIMIAN CITY OF LOS ANGELES

CALIFORNIA



KAREN BASS MAYOR DEPARTMENT OF BUILDING AND SAFETY 201 NORTH FIGUEROA STREET LOS ANGELES, CA 90012

OSAMA YOUNAN, P.E. GENERAL MANAGER SUPERINTENDENT OF BUILDING

> JOHN WEIGHT EXECUTIVE OFFICER

#### **GEOLOGY AND SOILS REPORT REVIEW LETTER**

May 4, 2023

LOG # 124355 SOILS/GEOLOGY FILE - 2 LIQ/AP-Santa Monica Fault Zone

Tripalink Real Estate LLC 2905 S. Vermont Avenue, Suite 204 Los Angeles, CA 90007

TRACT:	BARRETT VILLA TRACT (MR 70-32/35)
BLOCK:	E
LOTS:	7, FR 8 (Arb. 4)
LOCATION:	1531, 1533 & 1535 S. Sawtelle Boulevard

CURRENT REFERENCE	REPORT	DATE OF	
REPORT/LETTER(S)	No.	DOCUMENT	PREPARED BY
Geology/Soils Report	22-005-011EG	03/24/2023	EGL
Oversized Doc(s).	**	**	**

The Grading Division of the Department of Building and Safety has reviewed the referenced report that provide a surface fault rupture investigation and recommendations for the proposed construction of a 5-level 9-unit apartment building and associated structures including the removal of the upper 5 feet of site soils or to a depth at least 3 feet below the proposed footings, whichever is deeper.

The earth materials at the subsurface exploration locations consist of up to 11.4 feet of uncertified fill underlain by alluvial fan deposits. According to the consultants, groundwater was not encountered to the maximum depth explored of 60 feet, and historically highest groundwater level is at about 20 to 30 feet below the ground surface.

The consultants recommend to support the proposed structures on conventional foundations bearing on native undisturbed soils (page 19) and/or a blanket of properly placed fill (page 18) a minimum of 3 feet thick.

The site is located in designated fault zone and liquefaction hazard zone as shown on the Seismic Hazard Zones map issued by the State of California.

The project is located within a Fault Zone identified by the State of California Alquist-Priolo Act.

#### Page 2 1531, 1533 & 1535 S. Sawtelle Boulevard

The review of the subject report cannot be completed because the stability or safety of the proposed development cannot be determined at this time. The review will be continued upon submittal of an addendum to the report which includes, but need not be limited to, the following:

(Note: Numbers in parenthesis () refer to applicable sections of the 2023 City of LA Building Code. P/BC numbers refer to the applicable Information Bulletin. Information Bulletins can be accessed on the internet at LADBS.ORG.)

- 1. Please clarify the proposed project. What are the proposed accessory structures? Show the location of the proposed structures on the geologic map.
- 2. Are any basements proposed as part of the construction? Show the location and label the height of all proposed retaining walls.
- 3. Page 18 of the subject report recommends foundations on 3 feet of fill and page 19 recommends foundations on natural soils. Clarify the recommended bearing material.
- 4. The consultants recommend removals 5 feet below existing surface or 3 feet below proposed foundations and 5 feet beyond the proposed foundations. How will this be achieved, particularly in the area of the deep fill (trash pit)? Provide exploration to determine the limits of the trash pit. Provide recommendations for building over the area of deep fill.
- 5. Provide a geologic map and cross sections showing existing and proposed topographic profiles; limits of the trash pit; existing and proposed structures (including proposed retaining walls); and, recommended temporary excavation removals. (7006.3.2)
- 6. It appears that the site is located on an Alquist-Priolo Earthquake fault zone. The fault investigation performed does not appear to be in accordance with the standard of practice nor information Bulletin P/BC 2023-129. Provide a fault investigation conducted in accordance with guidelines presented in P/BC 2023-129. Include answers to the following questions.
  - a. Fault investigations must be conducted by a California licensed Certified Engineering Geologist or Professional Geologist who is experienced with fault investigations. What is the fault investigation experience of the licensed geologist?
  - b. Were City and State records for fault investigation reports in the site vicinity reviewed?
  - c. What is the range of mapped fault orientations in the vicinity of the subject site?
  - d. The Geoprobe percussion hammer driven samples do not appear to be the standard of practice and would have high disturbance. Provide a discussion of the sample disturbance and photographs of the intact retrieved core.
  - e. Why weren't down-hole logged bucket auger borings or continuous core borings used in the investigation?
  - f. What age dating technique was used to determine the age of the deposits and depth to Pleistocene age soils?

#### Page 3 1531, 1533 & 1535 S. Sawtelle Boulevard

- g. The consultants describe the deposits as appearing "complex with predominately medium to very coarse-grained sand interfingering with the fine sand- and silt-sized interbeds and were not fully differentiated graphically." Based upon the unit descriptions and geologic profiles (GP-1, GP-2 and GP-3) it appears that multiple faults (including the faulted Qof over Qya-Qyf depicted on Plate GP-3) could be located through the proposed habitable structures. Provide additional exploration to rule out active faulting at the subject site.
- h. What was the orientation of the caliche stringers? Were any of the orientations consistent with active fault rupture features?
- i. What was the orientation of the fine sand laminae? Were any of the orientations consistent with liquefaction or active fault rupture features?
- j. Were any of the abundant charcoal fragments collected for age dating?
- 7. What is the recommended thickness of EI<20 material below the proposed slabs?
- 8. Provide design calculations and recommendations for temporary excavations for a minimum factor of safety of 1.25.

The geologist and soils engineer shall prepare a report containing an itemized response to the review items indicated in this letter. If clarification concerning the review letter is necessary, the report review engineer and/or geologist may be contacted. Two copies of the response report, including one unbound wet-signed original for archiving purposes, a pdf-copy of the complete report in a flash drive, and the appropriate fees will be required for submittal.

CASEY LEE JENSEN Engineering Geologist Associate III

GLEN RAAD Geotechnical Engineer I

CLJ/GR:clj/gr Log No. 124355 213-482-0480

cc: Ryan Jones, Applicant Environmental Geotechnology Laboratory, Inc. (EGL), Project Consultant WL District Office CITY OF LOS ANGELES DEPARTMENT OF BUILDING AND SAFETY

Grading Division

WLA	
District	

APPLICATION FOR REVIEW OF	TECHNICAL REPORTS
---------------------------	-------------------

	APPLICATION FOR RE		L REPORTS					
		ISTRUCTIONS						
A. Address all communications to		221 N. Figueroa St., 12th F	I., Los Angeles, CA 90012					
Telephone No. (213)482-0480 B. Submit two copies (three for s		If" convert the report on a	CD Dom on flock drive					
and one copy of application w	vith items "1" through "10" com	if copy of the report on a	a CD-Rom or flash drive,					
C. Check should be made to the		ipieteu.						
1. LEGAL DESCRIPTION		2. PROJECT ADDRESS:						
Tract: Barrett Villa Tract		1531,1533	& 1535 S. Sawtelle Blvd					
Block: E Lots: L	Lot 7 and a Portion of Lot 8	4. APPLICANT RYA	N JONES					
3. OWNER: Tripalink Real Estate LLC Address: 2905 S VERMONT AVE #204 City: LOS ANGELES Zip: 90007		Address:11819 GOLDRING RD UNIT ACity:ARCADIAZip:91006Phone (Daytime):626-263-3588						
					Phone (Daytime): 213-436		E-mail address:	RYAN@EGLAB.COM / MAIL@EGL88.COM
5. Report(s) Prepared by: RYAN JONES		<ol> <li>Report Date(s): <sup>3/24/2023</sup> </li> </ol>						
7. Status of project:	Proposed	Under Construction	Storm Damage					
8. Previous site reports?	□ YES if yes, give date(s)	) of report(s) and name of	f company who prepared report(s)					
9. Previous Department actions?	TYES	if yes, provide dates ar	nd attach a copy to expedite processing.					
Dates:	-		the week					
10. Applicant Signature:			Position: PROJECT ENGINEER					
	(DEPAR	TMENT USE ONLY)						
REVIEW REQUESTED	FEES REVIEW REQU	ESTED FEES	Fee Due: \$1,33855					
Soils Engineering	No, of Lots		Fee Verified By: BR Date: 3/27/2023					
Geology	No. of Acres		(Cashier Use Only)					
	HAC,00 Division of Land							
Supplemental	Other		0 1-11-					
Combined Supplemental	Expedite	\$363,00	Receipt#					
Import-Export Route	Response to Correction	n	10/01/01					
Cubic Yards:	Expedite ONLY		1550611					
		Sub-total \$ 1,089,00	(GK)					
		Surcharge \$ 249,58	4/4/23					
ACTION BY:		TOTAL FEE \$1,338.58	117125					
THE REPORT IS:	IOT APPROVED	/						
APPROVED WITH CON	DITIONS DELOW	□ ATTACHED						
For Geol	logy	Date						
For So	ils	Date						
			-					
			_					
			-					
			1					
			1					

COUNTY CLERK'S USE CITY OF LOS ANGELES OFFICE OF THE CITY CLERK 200 NORTH SPRING STREET, ROOM 395 LOS ANGELES, CALIFORNIA 90012 CALIFORNIA ENVIRONMENTAL QUALITY ACT NOTICE OF EXEMPTION						
	(PRC Section 21152; CEQA Guidelines Section 15062)					
		(,,,.,		,		
Pursuant to Public Resources Code § 21152(b) and CEQA Guidelines § 15062, the notice should be posted with the County Clerk by mailing the form and posting fee payment to the following address: Los Angeles County Clerk/Recorder, Environmental Notices, P.O. Box 1208, Norwalk, CA 90650. Pursuant to Public Resources Code § 21167 (d), the posting of this notice starts a 35-day statute of limitations on court challenges to reliance on an exemption for the project. Failure to file this notice as provided above, results in the statute of limitations being extended to 180 days. PARENT CASE NUMBER(S) / REQUESTED ENTITLEMENTS CPC-2023-5657-DB-VHCA						
LEAD C	ITY AGENCY			CASE NUMBER		
City o	f Los Angeles (Dep	partment of City Planning)		ENV-2023-5658-CE		
	PROJECT TITLE 1531 South Sawtelle Boulevard			COUNCIL DISTRICT 11 - Park		
PROJE	CT LOCATION (Street	Address and Cross Streets and/or Att	ached Map)	Map attached.		
1531 -	- 1535 South Sawte	elle Boulevard				
	CT DESCRIPTION:			☐ Additional page(s) attached.		
		it residential development with one ur	hit set aside for Very I	Low Income Households.		
	OF APPLICANT / OWNE	R:				
Dong						
CONTACT PERSON (If different from Applicant/Owner above)(AREA CODE) TELEPHONE NUMBEREXT.Gary Benjamin(213) 436-8606						
EXEMP	PT STATUS: (Check all	boxes, and include all exemptions, the	at apply and provide i	relevant citations.)		
		STATE CEQA STATUTI	E & GUIDELINES			
	STATUTORY EXEMP					
	Public Resources Cod	e Section(s)				
CATEGORICAL EXEMPTION(S) (State CEQA Guidelines Sec. 15301-15333 / Class 1-Class 33)						
CEQA Guideline Section(s) / Class(es) 15332 (Class 32)						
OTHER BASIS FOR EXEMPTION (E.g., CEQA Guidelines Section 15061(b)(3) or (b)(4) or Section 15378(b) )						
JUSTIF	ICATION FOR PROJEC	T EXEMPTION:		Additional page(s) attached		
☑ None of the exceptions in CEQA Guidelines Section 15300.2 to the categorical exemption(s) apply to the Project.						
The project is identified in one or more of the list of activities in the City of Los Angeles CEQA Guidelines as cited in the justification.						
IF FILED BY APPLICANT, ATTACH CERTIFIED DOCUMENT ISSUED BY THE CITY PLANNING DEPARTMENT STATING THAT THE DEPARTMENT HAS FOUND THE PROJECT TO BE EXEMPT.						
If different from the applicant, the identity of the person undertaking the project. CITY STAFF USE ONLY:						
CITY STAFF USE ONLY: CITY STAFF NAME AND SIGNATURE						
Isaiah I		·	×	City Planning Associate		
	ENTITLEMENTS APPROVED					
L						



Isaiah Ross <isaiah.ross@lacity.org>

#### CPC-2023-5657-DB-VHCA ENV-2023-5658-CE

2 messages

**Stephen Halkovic** <stephen\_h\_3@hotmail.com> To: "isaiah.ross@lacity.org" <isaiah.ross@lacity.org>

Good day Isaiah Ross!

How are you?

Fri, Sep 13, 2024 at 6:05 PM

I'm Stephen Halkovic. I live in an apartment next door to the 1531-1535 South Sawtelle Boulevard, 90025. at 1525 Sawtelle in apartment #14. I think it will be well and good to have the property restored to the 3 retail stores that it seems to have originally planned for when built. However, to build a 5 story, 9-unit residential unit seems a bit over the top.

First of all, and I could be wrong on this point, there hasn't been a visible notice put on the property about this public hearing. I believe that is one of the requirements to have a hearing.

The second point is that parking in the surrounding area is scarious, and another 9 vehicles will greatly exasperate this situation. They may claim that there exist 10 spots behind the existing structure, however 4 to 6 of them are regularly occupied on a daily basis. As a matter of fact, the "Proposed Project" indicates "... Including zero automobile parking...".

The third point has to do with the lack of proper disposal of "waste" from the property. For about a year, give or take, they have been using the property to store furniture and the like. During the last few months, they have been retrieving stored items. However, when the workers find damaged, dirty, or unwanted items, they leave them outside the front of the building by the sidewalk and do not return to remove these discarded items. One time it was 6 mattresses, a broken table, a couple of broken chairs, and random bit like cabnet doors and the like.

I haven't participated in a public hearing before, however I would like to present these facts to the hearing officer.

Thank you for your service!

Stephen Halkovic

Isaiah Ross <isaiah.ross@lacity.org>

Wed, Sep 18, 2024 at 1:49 PM



Isaiah Ross <isaiah.ross@lacity.org>

#### 1531 Sawtelle Blvd.

1 message

judiwatson@me.com <judiwatson@me.com> To: isaiah.ross@lacity.org Cc: Jeff Khau <Jeff.khau@lacity.org>, michael.amster@lacity.org, councilmember.park@lacity.org, Jay Handal <jayh@westlasawtelle.org>

Dear Mr. Ross,

I am an interested party in Planning Case CPC -2023-5657-DB-VHCA (1532 Sawtelle Blvd.), and would like to receive all project updates, including the Decision Letter.

I attended the virtual hearing on October 4 and did not find it as informative as I hoped, with only a very short time for questions/comments and no opportunity for follow-up. I hoped to be able to speak with you prior to sending further communication to Planning regarding this project, but have been unable to reach you. I do have concerns about this project (and questions), and will try to communicate them as best I can.

My hope is that, because of the nature of this development, it's impact on the location, and also the very significant issues it raises, there can be additional community review and input before a decision is made. I believe there really is not much community awareness despite the standard Planning Department outreach. **Once something is built it cannot be unbuilt** - and the risk is destroying neighborhoods and overall city livability by focusing only on increasing housing.

I support re-development, but would like to see some changes to the scope and design of this project to reduce its negative impact on the neighborhood and increase its positive contribution. The project plans available for public perusal are lacking a lot of detail/dimensions making it difficult to discern some important items.

And, I hope my last minute submittal will be taken into consideration by you and the Planning Department in your review of this project. Please let me know that you have received this message, and if you have accepted it.

Sincerely,

Judi Watson

10/30/24, 9:36 AM

#### City of Los Angeles Mail - 1531 Sawtelle Blvd.

<u>A major concern is that the project has no parking.</u> AB 2097 does allow a public agency to impose or enforce minimum automobile parking requirements on a project that is located within one-half mile of public transit if the public agency finds that not imposing or enforcing minimum automobile parking requirements on the development would have a substantially negative impact on . . . (iii) existing residential or commercial parking within one-half mile of the housing development project. <u>This development is a</u> <u>MAJOR change of usage and definitely will have a substantially negative impact on existing parking.</u>

- At the hearing, applicant's representative said that there was plenty of street parking, and there are many nearby public and private parking lots. Private parking lots are for the usage of those properties' occupants/visitors, and are often not even adequate to fully serve those needs. In my observation, the nearby public lots are often full, and they certainly are not adequate to accommodate the needs of large residential developments in the area that do not provide their own parking.

- The applicant seems to assume that tenants will not have need for vehicle parking, or that only a few will need parking; I don't think this is an accurate or realistic assessment. While aimed at a student/young professional market seeking affordable housing, and while the location is near bus transportation, a significant proportion of students and young professionals DO commute by car - and even if they may use bus transportation sometimes, they often own a car for other usages. This project has <u>47</u> bedrooms. We can assume that a high proportion will be occupied by more than one person. Using a conservative estimate of 50% of units occupied by 2 people, there will be 70 occupants of this building - and if only 1 in 3 have a car, that is a demand for 23 parking spaces. Also, I see <u>no bicycle parking spaces</u> (except a few on the public sidewalk).

- Occupants will be having visitors at various times, and those visitors coming to the area will also need parking.

- The previous development on this property, Bundy Lock & Safe, had just a few employees (estimate of 4-5 at any one time), with ample on-site parking for them. Rarely were there more than a few customers in the shop and always for just a short time. <u>This development will generate a significantly increased demand</u> <u>for parking.</u>

# <u>The density of this project is not realistically reflected by evaluating it as an "apartment building".</u> It is Co-Living, and this project is quite different from what the general understanding is of an "apartment building" and it should NOT be vetted as though it were an Apartment Building.

- This is supposedly a 9 unit building but it consists of 47 bedrooms. Almost all apartments consist of 0 to 2 bedrooms, with a small percentage of 3 bedrooms, and a very small number of 4 bedrooms. Apartments with 5 -6 bedrooms are unheard of. Yet this proposed project consists of 5 - 5 bedroom "units", 3 - 6 bedroom "units" and 1 - 4 bedroom "unit". While there is no specification that I know of regarding the number of bedrooms in an "apartment", historically this has been balance of market needs/rental rates/development costs - and the result is an average 1.5 bedrooms for apartment buildings. If the proposed project matched the average for number of bedrooms in an "apartment", it would be a 31 unit building - and there is no way it could be configured to fit in the allowable building envelope.

- There are really no "common" areas in a "unit" in this project. Except for Single/Studio apartments, a living room is an included common area in an apartment. In this project, there are NO living rooms (even though most so-called Co-Housing projects DO include a common living room in their units). This project's "units" consist of only bedrooms with a bathroom, and a shared stacked washer/dryer and small galley kitchen. The designation, "unit", is applied to take advantage of a lag in LA Planning definitions as they relate to housing. The creation of 9 "units" was driven solely by organization/access limitations to the spaces available per floor to maximize the number of individual bedrooms (i.e., occupancy spaces).

- These "units" are NOT leased as a "unit", unlike an "apartment". Rather, each individual bedroom with bathroom is individually leased.

- This project is more like a dormitory, a boarding house, a hostel or hotel (with no on site services). It is a new category (and I think a valuable one), but Los Angeles Planning must address this and put forth a new set of development standards before approving this kind of housing. Many other municipalities ARE doing exactly this. Why not Los Angeles???

<u>This new project will not at all be compatible with the existing neighborhood.</u> Currently in this one-block area, there is one 4 story office building, one 3 story office building, and <u>ALL the rest of the developments are either one or two stories</u>. Neither of the two taller buildings have a visually unrelieved front facade as the new proposed building has.

- Besides being unlike any other building on this block, the proposed 5-story project towers over the adjacent 3-story office building to the south and the adjacent 2story apartment building to the north. While TOC (and other?) incentives may allow this type of development, wouldn't sensitive planning attempt to mitigate these impacts?

- The proposed project presents as a giant BOX, with no visual relief. There are no balconies along the front facade, and there are no step-backs.

**<u>Cumulative Impact</u>**. Approval of this project as designed will set a precedent for future development on this block. Re-development may be inevitable and desirable, as is the creation of more housing. However, the consequences of Planning decisions should be taken into consideration. There are quite a few lots on this block of Sawtelle that are potential re-development targets. What would be the effect of multiple buildings like this proposed project replacing existing apartments that have both much smaller occupancy and do have parking, and small businesses with few occupants? Just making a rough calculation, 6 additional projects like this one (which is not at all far-fetched on this block) would replace an estimate of about 60 people with perhaps 360 or more, with no parking required.

# I do not believe there is adequate street landscaping. I see only a small cactus garden at the front of the building, and no additional trees at the street-scape.

**I question the TOC Tier 4 being claimed**. Zimas shows Tier 2. Can you please verify and explain how this location qualifies as Tier 4 (or even Tier 3)? And can you help me understand how that impacts development on this site?

Is this project subject to CEQA? It is within 500 feet of a Freeway. Also it is directly across the street from a Post-Acute Care facility.

<u>Can you confirm the 15' clearance between the building face and high tension power lines, as claimed by applicant?</u> This should be verified by LADWP before further progress. It may be necessary to underground the lines.